

"THIS IS A FULLY CONTROLLED ACCESS FACILITY"


DATE REVISED	DATE FILMED	DATE REVISED	DATE FILMED	FED. RD. DIST. NO.	STATE	FED. AID PROJ. NO.	SHEET NO.	TOTAL SHEET
				6	ARK.			
JOB NO.						061451	1	130
						(2) ARKANSAS TOURIST INFORMATION CENTER (WHITE RIVER) (S)		

ARKANSAS STATE HIGHWAY AND TRANSPORTATION DEPARTMENT
CONSTRUCTION PLANS

ARKANSAS TOURIST INFORMATION CENTER
(WHITE RIVER) (S)

PRAIRIE COUNTY
ROUTE 40 SECTION 42

F.A.P. STPE-ENHN(481)
JOB 061451

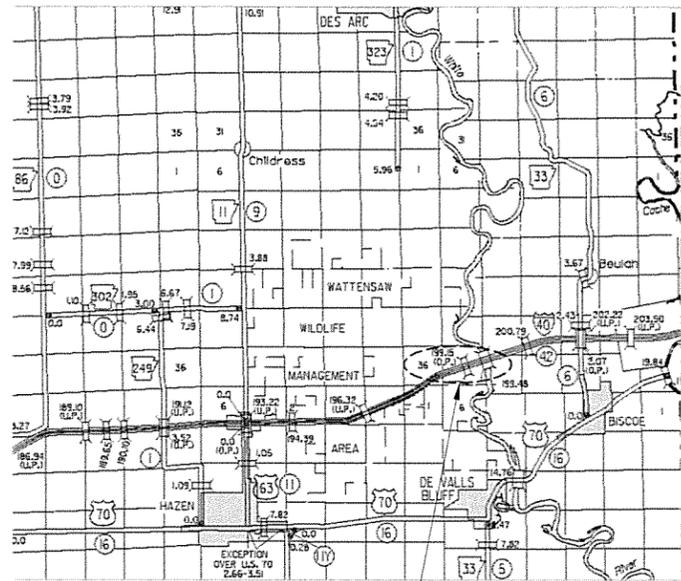

PROJECT LOCATION
TOURIST INFORMATION CENTER

VICINITY MAP

PROJECT LOCATION
TOURIST INFORMATION CENTER
(WESTBOUND)

(.7 MILE WEST OF WHITE RIVER BRIDGE
5.8 MILES EAST OF HWY. 63 (EXIT 193)
LOG MILE 199.15)

PROJECT LOCATION
TOURIST INFORMATION CENTER
(EASTBOUND)

PROJECT COORDINATES

MID-POINT OF PROJECT (EASTBOUND)


LAT. = N 34° 50' 09"

LONG. = W 91° 28' 06"


MID-POINT OF PROJECT (WESTBOUND)

LAT. = N 34° 50' 13"

LONG. = W 91° 28' 07"

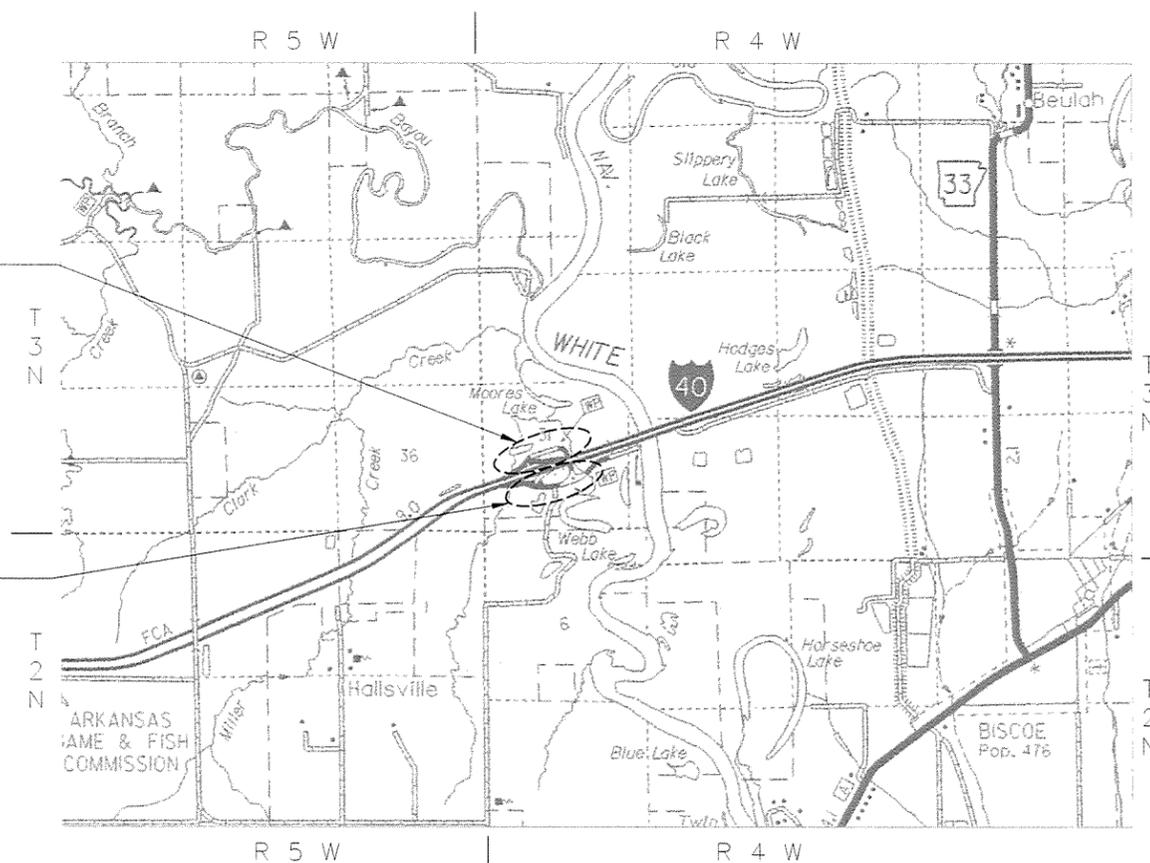

LOCATION MAP
(NOT TO SCALE)

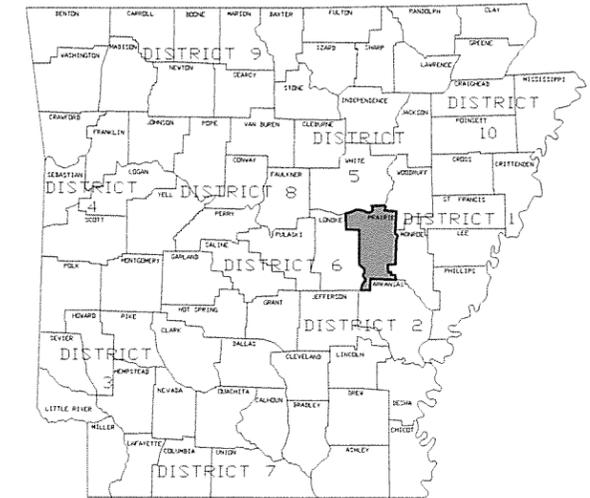

ARKANSAS HIGHWAY DISTRICT 6



P.E. JOB 061451
NON-PART.

ARKANSAS TOURIST INFORMATION CENTER (WHITE RIVER) - SHEET INDEX								
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G-001	1	COVER SHEET	-	-	-	-	-	
G-002	2	SHEET INDEX	-	-	-	-	-	
G-003	3	CODE ANALYSIS	-	-	-	-	-	
G-004	4	GOVERNING SPECIFICATIONS	-	-	-	-	-	
G-005	5	SUMMARY OF QUANTITIES	-	-	-	-	-	
C-001	6	GENERAL NOTES AND LEGEND	-	-	-	-	-	
C-002	7	OVERALL SURVEY PLAN	-	-	-	-	-	
C-003	8	OVERALL SITE PLAN	-	-	-	-	-	
C-101	9	TOURIST INFORMATION CENTER AND MAINTENANCE BUILDING DEMOLITION PLAN (WESTBOUND)	-	-	-	-	-	
C-102	10	TOURIST INFORMATION CENTER AND MAINTENANCE BUILDING SITE PLAN (WESTBOUND)	-	-	-	-	-	
C-103	11	TOURIST INFORMATION CENTER AND MAINTENANCE BUILDING GRADING AND EROSION CONTROL PLAN (WESTBOUND)	-	-	-	-	-	
C-104	12	TOURIST INFORMATION CENTER AND MAINTENANCE BUILDING UTILITY PLAN I (WESTBOUND)	-	-	-	-	-	
C-105	13	TOURIST INFORMATION CENTER AND MAINTENANCE BUILDING UTILITY PLAN II (WESTBOUND)	-	-	-	-	-	
C-111	14	TOURIST INFORMATION CENTER DEMOLITION PLAN (EASTBOUND)	-	-	-	-	-	
C-112	15	TOURIST INFORMATION CENTER SITE PLAN (EASTBOUND)	-	-	-	-	-	
C-113	16	TOURIST INFORMATION CENTER GRADING AND EROSION CONTROL PLAN (EASTBOUND)	-	-	-	-	-	
C-114	17	TOURIST INFORMATION CENTER UTILITY PLAN (EASTBOUND)	-	-	-	-	-	
C-131	18	TRUCKER-VENDING BUILDING DEMOLITION PLAN (EASTBOUND AND WESTBOUND)	-	-	-	-	-	
C-132	19	TRUCKER-VENDING BLDG SITE AND UTILITY PLAN (EASTBOUND AND WESTBOUND)	-	-	-	-	-	
C-133	20	TRUCKER-VENDING BUILDING GRADING AND EROSION CONTROL PLAN (EASTBOUND AND WESTBOUND)	-	-	-	-	-	
C-500	21	DETAILS I	-	-	-	-	-	
C-501	22	DETAILS II	-	-	-	-	-	
C-502	23	DETAILS III	-	-	-	-	-	
SE-101	24	EXTERIOR AREA LIGHTING PLAN	-	-	-	-	-	
TEC-1	25	TEMPORARY EROSION CONTROL DEVICES	-	12/15/11	-	-	-	
TEC-3	26	TEMPORARY EROSION CONTROL DEVICES	-	11/3/94	-	-	-	
WF-3	27	CHAIN LINK FENCE	-	11/17/10	-	-	-	
WR-2	28	WHEELCHAIR RAMPS ALTERATIONS ONLY	-	10/09/03	-	-	-	
A-001	29	GENERAL NOTES & LEGEND	-	-	-	-	-	
A-002	30	FINISH SCHEDULE AND MATERIAL LEGENDS	-	-	-	-	-	
A-003	31	DOOR SCHEDULE & DOOR AND FRAME ELEVATIONS	-	-	-	-	-	
A-004	32	WINDOW ELEVATIONS	-	-	-	-	-	
A-005	33	DOOR DETAILS	-	-	-	-	-	
A-006	34	STANDARD WALL DETAILS	-	-	-	-	-	
A-007	35	WINDOW DETAILS	-	-	-	-	-	
A-101	36	TOURIST INFORMATION CENTER FLOOR PLAN	-	-	-	-	-	
A-102	37	TOURIST INFORMATION CENTER DIMENSIONED FLOOR PLAN	-	-	-	-	-	
A-103	38	TOURIST INFORMATION CENTER PARTIAL ENLARGED FLOOR PLAN	-	-	-	-	-	
A-104	39	TOURIST INFORMATION CENTER ROOF AND REFLECTED CEILING PLANS	-	-	-	-	-	
A-121	40	MAINTENANCE BUILDING FLOOR PLAN	-	-	-	-	-	
A-122	41	MAINTENANCE BUILDING REFLECTED CEILING AND ROOF PLANS	-	-	-	-	-	
A-131	42	TRUCKER-VENDING BUILDING FLOOR PLAN	-	-	-	-	-	
A-132	43	TRUCKER-VENDING BUILDING ROOF AND REFLECTED CEILING PLANS	-	-	-	-	-	
A-201	44	TOURIST INFORMATION CENTER BUILDING ELEVATIONS	-	-	-	-	-	
A-202	45	TOURIST INFORMATION CENTER BUILDING ELEVATIONS	-	-	-	-	-	
A-221	46	MAINTENANCE BUILDING ELEVATIONS	-	-	-	-	-	
A-231	47	TRUCKER-VENDING BUILDING BUILDING ELEVATIONS	-	-	-	-	-	
A-232	48	TRUCKER-VENDING BUILDING BUILDING ELEVATIONS	-	-	-	-	-	
A-301	49	TOURIST INFORMATION CENTER BUILDING SECTIONS	-	-	-	-	-	
A-302	50	TOURIST INFORMATION CENTER BUILDING SECTIONS	-	-	-	-	-	
A-303	51	TOURIST INFORMATION CENTER BUILDING SECTIONS	-	-	-	-	-	
A-304	52	TOURIST INFORMATION CENTER WALL SECTIONS	-	-	-	-	-	
A-305	53	TOURIST INFORMATION CENTER WALL SECTIONS	-	-	-	-	-	
A-306	54	TOURIST INFORMATION CENTER WALL SECTIONS	-	-	-	-	-	
A-307	55	TOURIST INFORMATION CENTER WALL SECTIONS	-	-	-	-	-	
A-308	56	TOURIST INFORMATION CENTER WALL SECTIONS	-	-	-	-	-	
A-309	57	TOURIST INFORMATION CENTER WALL SECTIONS	-	-	-	-	-	
A-310	58	TOURIST INFORMATION CENTER WALL SECTIONS	-	-	-	-	-	
A-321	59	MAINTENANCE BUILDING BUILDING SECTION	-	-	-	-	-	
A-322	60	MAINTENANCE BUILDING WALL SECTIONS	-	-	-	-	-	
A-331	61	TRUCKER-VENDING BUILDING BUILDING SECTIONS	-	-	-	-	-	
A-332	62	TRUCKER-VENDING BUILDING WALL SECTIONS	-	-	-	-	-	
A-333	63	TRUCKER-VENDING BUILDING WALL SECTIONS	-	-	-	-	-	
A-401	64	TOURIST INFORMATION CENTER INTERIOR ELEVATIONS	-	-	-	-	-	
A-431	65	TRUCKER-VENDING BUILDING INTERIOR ELEVATIONS	-	-	-	-	-	

ARKANSAS TOURIST INFORMATION CENTER (WHITE RIVER) - SHEET INDEX								
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A-503	68	TOURIST INFORMATION CENTER DETAILS	-	-	-	-	-	
A-504	69	TOURIST INFORMATION CENTER DETAILS	-	-	-	-	-	
A-505	70	TOURIST INFORMATION CENTER DETAILS	-	-	-	-	-	
A-506	71	TOURIST INFORMATION CENTER DETAILS	-	-	-	-	-	
A-507	72	TOURIST INFORMATION CENTER DETAILS	-	-	-	-	-	
A-531	73	TRUCKER-VENDING BUILDING DETAILS	-	-	-	-	-	
A-532	74	TRUCKER-VENDING BUILDING DETAILS	-	-	-	-	-	
A-533	75	TRUCKER-VENDING BUILDING DETAILS	-	-	-	-	-	
A-534	76	TRUCKER-VENDING BUILDING DETAILS	-	-	-	-	-	
A-601	77	TOURIST INFORMATION CENTER FLOOR PATTERN PLAN	-	-	-	-	-	
S-001	78	GENERAL NOTES	-	-	-	-	-	
S-002	79	GENERAL NOTES	-	-	-	-	-	
S-003	80	TOURIST INFORMATION CENTER WIND UPLIFT DIAGRAM (ROOF)	-	-	-	-	-	
S-101	81	TOURIST INFORMATION CENTER FOUNDATION PLAN	-	-	-	-	-	
S-102	82	TOURIST INFORMATION CENTER ROOF FRAMING PLAN	-	-	-	-	-	
S-121	83	MAINTENANCE BUILDING FOUNDATION AND ROOF FRAMING PLANS	-	-	-	-	-	
S-131	84	TRUCKER-VENDING BUILDING FOUNDATION AND ROOF FRAMING PLANS	-	-	-	-	-	
S-301	85	TOURIST INFORMATION CENTER FOUNDATION SECTIONS	-	-	-	-	-	
S-302	86	TOURIST INFORMATION CENTER FRAMING SECTIONS	-	-	-	-	-	
S-303	87	TOURIST INFORMATION CENTER FRAMING SECTIONS	-	-	-	-	-	
S-304	88	TOURIST INFORMATION CENTER FRAMING SECTIONS	-	-	-	-	-	
S-305	89	TOURIST INFORMATION CENTER FRAMING SECTIONS	-	-	-	-	-	
S-306	90	TOURIST INFORMATION CENTER FRAMING SECTIONS	-	-	-	-	-	
S-307	91	TOURIST INFORMATION CENTER FRAMING SECTIONS	-	-	-	-	-	
S-308	92	TOURIST INFORMATION CENTER FRAMING SECTIONS	-	-	-	-	-	
S-321	93	MAINTENANCE BUILDING FOUNDATION SECTIONS	-	-	-	-	-	
S-322	94	MAINTENANCE BUILDING FRAMING SECTIONS	-	-	-	-	-	
S-331	95	TRUCKER-VENDING BUILDING FOUNDATION SECTIONS	-	-	-	-	-	
S-332	96	TRUCKER-VENDING BUILDING FOUNDATION SECTIONS	-	-	-	-	-	
S-333	97	TRUCKER-VENDING BUILDING FRAMING SECTIONS	-	-	-	-	-	
S-334	98	TRUCKER-VENDING BUILDING FRAMING SECTIONS	-	-	-	-	-	
S-335	99	TRUCKER-VENDING BUILDING FRAMING SECTIONS	-	-	-	-	-	
S-336	100	TRUCKER-VENDING BUILDING FRAMING SECTIONS	-	-	-	-	-	
S-501	101	TYPICAL DETAILS	-	-	-	-	-	
S-502	102	TYPICAL DETAILS	-	-	-	-	-	
M-101	103	TOURIST INFORMATION CENTER MECHANICAL PLAN	-	-	-	-	-	
M-121	104	MAINTENANCE BUILDING MECHANICAL PLAN	-	-	-	-	-	
M-131	105	TRUCKER-VENDING BUILDING MECHANICAL PLAN	-	-	-	-	-	
M-201	106	TOURIST INFORMATION CENTER MECHANICAL DETAILS	-	-	-	-	-	
P-001	107	LEGEND, ABBREVIATIONS AND NOTES	-	-	-	-	-	
P-101	108	TOURIST INFORMATION CENTER SANITARY SEWER PIPING PLAN	-	-	-	-	-	
P-102	109	TOURIST INFORMATION CENTER DOMESTIC WATER PIPING PLAN	-	-	-	-	-	
P-131	110	TRUCKER-VENDING BUILDING SANITARY SEWER PIPING PLAN	-	-	-	-	-	
P-132	111	TRUCKER-VENDING BUILDING DOMESTIC WATER PIPING PLAN	-	-	-	-	-	
P-501	112	DETAILS I	-	-	-	-	-	
P-502	113	DETAILS II	-	-	-	-	-	
P-503	114	DETAILS III	-	-	-	-	-	
P-601	115	SCHEDULES I	-	-	-	-	-	
P-602	116	SCHEDULES II	-	-	-	-	-	
P-603	117	RISER DIAGRAMS I	-	-	-	-	-	
P-604	118	RISER DIAGRAMS II	-	-	-	-	-	
P-605	119	RISER DIAGRAMS III	-	-	-	-	-	
E-001	120	LEGEND & ABBREVIATIONS	-	-	-	-	-	
E-101	121	TOURIST INFORMATION CENTER LIGHTING PLAN	-	-	-	-	-	
E-102	122	TOURIST INFORMATION CENTER POWER & SYSTEMS PLAN	-	-	-	-	-	
E-121	123	MAINTENANCE BUILDING	-	-	-	-	-	
E-131	124	TRUCKER-VENDING BUILDING	-	-	-	-	-	
E-501	125	DETAILS I	-	-	-	-	-	
E-502	126	DETAILS II	-	-	-	-	-	
E-601	127	RISER DIAGRAMS I	-	-	-	-	-	
E-602	128	RISER DIAGRAMS II	-	-	-	-	-	
E-603	129	SCHEDULES I	-	-	-	-	-	
E-604	130	SCHEDULES II	-	-	-	-	-	



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N Little Rock, AR 72118
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9/30/15

	JRR Apr
	10/11/15 Date
	ISSUED FOR CONSTRUCTION Description
	FC Symbol

Job Number 060451	N/A	N/A	N/A
Submitted by: John T. Ramsey, P.E., BE Director, Federal Services	Print Scale: 1:2	Draw Code:	
Print Date: 10/27/15	Drawn by: S. BOWEN	Checked by: G. ANCHER	File Name: AHS15WR-G-002.DWG
Designed by: J. RAMSEY			

ARKANSAS HIGHWAY AND TRANSPORTATION DEPARTMENT
ARKANSAS TOURIST INFORMATION CENTER
(WHITE RIVER) (S)
JOB 061451

SHEET INDEX

Sheet
Reference
Number:
G-002

Sheet 2 of 130

BUILDING CODE INFORMATION

EVALUATED UNDER 2012 ARKANSAS FIRE PROTECTION CODE, BASED ON 2012 INTERNATIONAL BUILDING CODE

TOURIST INFORMATION CENTER

GENERAL:

THIS PROJECT IS THE CONSTRUCTION OF A NEW TOURIST INFORMATION CENTER (RESTROOM FACILITY) AT LOCATIONS ALONG ARKANSAS INTERSTATE HIGHWAYS
PRIMARY USES WILL BE AS FOLLOWS:
MEN AND WOMEN RESTROOMS
VENDING AREA

SPECIAL INSPECTIONS:
NONE REQUIRED (CHAPTER 17; SECTION 1704.2, EXCEPTION 3)

OCCUPANCY CLASSIFIED:
U UTILITY (NON-SEPARATED)(CHAPTER 303)

OCCUPANCY SEPARATION:
NON-SEPARATED - PRIMARY OCCUPANCY TO BE GROUP U, UTILITY.

TYPE OF CONSTRUCTION:
Type IIB UNPROTECTED (TABLE 601)
NON-SPRINKLER NOT REQUIRED PER CHAPTER 9; SECTION 903

ALLOWABLE HEIGHT: (CHAPTER 5, TABLE 503)
ACTUAL: 22'-0"
ALLOWED: 55'-0"

ALLOWABLE STORIES: (CHAPTER 5, TABLE 503)
ACTUAL: 1
ALLOWED: 2

ALLOWABLE BUILDING AREAS: (CHAPTER 5, TABLE 503)
ACTUAL: 3,995 GSF
ALLOWED: 8,500 GSF PER FLOOR/STORY

AREA INCREASE: (CHAPTER 5, SECTION 506.2)
FRONTAGE AREA INCREASE NOT REQUIRED

SPRINKLER AREA INCREASE: NOT ALLOWED

FIRE SEPARATION: (CHAPTER 5, TABLE 508.4; CHAPTER 7)
NON-SEPARATED USE - NO FIRE SEPARATION REQUIRED

SHAFT ENCLOSURES - FIRE RESISTANCE RATING: (CHAPTER 7, SECTION 713.4; LESS THAN 4 STORES: 1-HOUR FIRE RATING REQUIRED)

TORNADO SHELTER AREA: NOT REQUIRED

MECHANICAL AREA: (CHAPTER 5, TABLE 509): NOT REQUIRED

EGRESS REQUIREMENTS: (CHAPTER 10; TABLE 1004.1.2)
OCCUPANT LOAD
GROUP U UTILITY 56 OCCUPANTS - (28 MEN; 28 WOMEN) BASED ON NUMBER OF FIXTURES AVAILABLE FOR
TOTAL OCCUPANT LOAD 56 OCCUPANTS

MEANS OF EGRESS: (CHAPTER 10, SECTION 1015)
EXITS
EXITS REQUIRED: 2
EXITS PROVIDED: 2

COMMON PATH OF TRAVEL (CHAPTER 10; SECTION 1014; TABLE 1014.3):
GROUP U, NON-SPRINKLERED
ACTUAL: 52'-0"
ALLOWED: 75'-0"

EXIT ACCESS TRAVEL DISTANCE (CHAPTER 10; SECTION 1016; TABLE 1016.2):
GROUP A-3, NON-SPRINKLERED - 300'
ACTUAL: 68'-0"
ALLOWED: 300'-0"

EXIT LOAD:
56 OCCUPANT/2 EXITS PROVIDED: 28 OCCUPANTS PER EXIT

EXIT STAIRWAYS (CHAPTER 10, SECTION 1005.3.1, SECTION 1009):
NOT REQUIRED

EXIT STAIRWAY FIRE RESISTANCE RATING (CHAPTER 10, SECTION 1005.3.1, SECTION 1009.3.1.2):
LESS THAN 4 STORIES: 1 HOUR FIRE RATING REQUIRED - N/A

EXIT CORRIDORS:
WIDTH (CHAPTER 10, SECTION 1005.3.2, SECTION 1018):
REQUIRED WIDTH: 28 OCCUPANTS x 0.2 CAPACITY FACTOR = 5.6"
PROVIDED WIDTH: 48" MIN.
MINIMUM CORRIDOR WIDTH (TABLE 1018.2): 44"

EXIT CORRIDOR FIRE RESISTANCE RATING (CHAPTER 7, SECTION 722.6; CHAPTER 10, SECTION 1018, TABLE 1018.1):
GROUP U, NON-SPRINKLERED AND OCCUPANT LOAD LESS THAN 30; NO RATING REQUIRED FOR WALLS AND CEILING.

EXIT DOORS:
WIDTH (CHAPTER 10, SECTION 1008):
REQUIRED WIDTH: 28 OCCUPANTS x 0.2 CAPACITY FACTOR = 5.6"
PROVIDE WIDTH: 2 PROVIDED 36" MIN. (OR 72")
MINIMUM CLEAR WIDTH (SECTION 1008.1.1) 32"

FIRESTOPPING:
NONE REQUIRED

BUILDING CODE INFORMATION

EVALUATED UNDER 2012 ARKANSAS FIRE PROTECTION CODE, BASED ON 2012 INTERNATIONAL BUILDING CODE

MAINTENANCE BUILDING

GENERAL:

THIS PROJECT IS THE CONSTRUCTION OF A NEW MAINTENANCE FACILITY AT LOCATIONS ALONG ARKANSAS INTERSTATE HIGHWAYS
PRIMARY USES WILL BE AS FOLLOWS:
MAINTENANCE EQUIPMENT STORAGE

SPECIAL INSPECTIONS:
NONE REQUIRED (CHAPTER 17; SECTION 1704.2, EXCEPTION 3)

OCCUPANCY CLASSIFIED:
U UTILITY (NON-SEPARATED)(CHAPTER 303)

OCCUPANCY SEPARATION:
NON-SEPARATED - PRIMARY OCCUPANCY TO BE GROUP U, UTILITY.

TYPE OF CONSTRUCTION:
Type IIB UNPROTECTED (TABLE 601)
NON-SPRINKLER NOT REQUIRED PER CHAPTER 9; SECTION 903

ALLOWABLE HEIGHT: (CHAPTER 5, TABLE 503)
ACTUAL: 15'-0"
ALLOWED: 55'-0"

ALLOWABLE STORIES: (CHAPTER 5, TABLE 503)
ACTUAL: 1
ALLOWED: 2

ALLOWABLE BUILDING AREAS: (CHAPTER 5, TABLE 503)
ACTUAL: 800 GSF
ALLOWED: 8,500 GSF PER FLOOR/STORY

AREA INCREASE: (CHAPTER 5, SECTION 506.2)
FRONTAGE AREA INCREASE NOT REQUIRED

SPRINKLER AREA INCREASE: NOT ALLOWED

FIRE SEPARATION: (CHAPTER 5, TABLE 508.4; CHAPTER 7)
NON-SEPARATED USE - NO FIRE SEPARATION REQUIRED

SHAFT ENCLOSURES - FIRE RESISTANCE RATING: (CHAPTER 7, SECTION 713.4; LESS THAN 4 STORES: 1-HOUR FIRE RATING)

TORNADO SHELTER AREA: NOT REQUIRED

MECHANICAL AREA: (CHAPTER 5, TABLE 509): NOT REQUIRED

EGRESS REQUIREMENTS: (CHAPTER 10; TABLE 1004.1.2)
OCCUPANT LOAD
GROUP U UTILITY 2 OCCUPANTS - (800/500=1.6-2)
TOTAL OCCUPANT LOAD 2 OCCUPANTS

MEANS OF EGRESS: (CHAPTER 10, SECTION 1015; TABLE 1015.1)
EXITS
EXITS REQUIRED: 1
EXITS PROVIDED: 1

COMMON PATH OF TRAVEL (CHAPTER 10; SECTION 1014; TABLE 1014.3):
GROUP U, NON-SPRINKLERED
ACTUAL: 40'-0"
ALLOWED: 75'-0"

EXIT ACCESS TRAVEL DISTANCE (CHAPTER 10; SECTION 1016; TABLE 1016.2):
GROUP A-3, NON-SPRINKLERED - 300'
ACTUAL: 40'-0"
ALLOWED: 300'-0"

EXIT LOAD:
2 OCCUPANT/1 EXITS PROVIDED: 2 OCCUPANTS PER EXIT

EXIT STAIRWAYS (CHAPTER 10, SECTION 1005.3.1, SECTION 1009):
NOT REQUIRED

EXIT STAIRWAY FIRE RESISTANCE RATING (CHAPTER 10, SECTION 1005.3.1, SECTION 1009.3.1.2):
LESS THAN 4 STORIES: 1 HOUR FIRE RATING REQUIRED - N/A

EXIT CORRIDORS:
WIDTH (CHAPTER 10, SECTION 1005.3.2, SECTION 1018):
REQUIRED WIDTH: OCCUPANTS x 0.2 CAPACITY FACTOR = 0.4"
PROVIDED WIDTH: N/A DIRECT EXIT TO EXTERIOR
MINIMUM CORRIDOR WIDTH (TABLE 1018.2): 44"

EXIT CORRIDOR FIRE RESISTANCE RATING (CHAPTER 7, SECTION 722.6; CHAPTER 10, SECTION 1018, TABLE 1018.1):
GROUP U, NON-SPRINKLERED AND OCCUPANT LOAD LESS THAN 30; NO RATING REQUIRED FOR WALLS AND CEILING.

EXIT DOORS:
WIDTH (CHAPTER 10, SECTION 1008):
REQUIRED WIDTH: 2 OCCUPANTS x 0.2 CAPACITY FACTOR = 0.4"

PROVIDE WIDTH: 1 PROVIDED 36" MIN.
MINIMUM CLEAR WIDTH (SECTION 1008.1.1) 32"

FIRESTOPPING:
NONE REQUIRED

BUILDING CODE INFORMATION

EVALUATED UNDER 2012 ARKANSAS FIRE PROTECTION CODE, BASED ON 2012 INTERNATIONAL BUILDING CODE

TRUCKER VENDING BUILDING

GENERAL:

THIS PROJECT IS THE CONSTRUCTION OF A NEW TRUCKER RESTROOM FACILITY AT LOCATIONS ALONG ARKANSAS INTERSTATE HIGHWAYS
PRIMARY USES WILL BE AS FOLLOWS:
MEN AND WOMEN RESTROOMS
VENDING AREA

SPECIAL INSPECTIONS:
NONE REQUIRED (CHAPTER 17; SECTION 1704.2, EXCEPTION 3)

OCCUPANCY CLASSIFIED:
U UTILITY (NON-SEPARATED)(CHAPTER 303)

OCCUPANCY SEPARATION:
NON-SEPARATED - PRIMARY OCCUPANCY TO BE GROUP U, UTILITY.

TYPE OF CONSTRUCTION:
Type IIB UNPROTECTED (TABLE 601)
NON-SPRINKLER NOT REQUIRED PER CHAPTER 9; SECTION 903

ALLOWABLE HEIGHT: (CHAPTER 5, TABLE 503)
ACTUAL: 15'-0"
ALLOWED: 55'-0"

ALLOWABLE STORIES: (CHAPTER 5, TABLE 503)
ACTUAL: 1
ALLOWED: 2

ALLOWABLE BUILDING AREAS: (CHAPTER 5, TABLE 503)
ACTUAL: 812 GSF
ALLOWED: 8,500 GSF PER FLOOR/STORY

AREA INCREASE: (CHAPTER 5, SECTION 506.2)
FRONTAGE AREA INCREASE NOT REQUIRED

SPRINKLER AREA INCREASE: NOT ALLOWED

FIRE SEPARATION: (CHAPTER 5, TABLE 508.4; CHAPTER 7)
NON-SEPARATED USE - NO FIRE SEPARATION REQUIRED

SHAFT ENCLOSURES - FIRE RESISTANCE RATING: (CHAPTER 7, SECTION 713.4; LESS THAN 4 STORES: 1-HOUR FIRE RATING)

TORNADO SHELTER AREA: NOT REQUIRED

MECHANICAL AREA: (CHAPTER 5, TABLE 509): NOT REQUIRED

EGRESS REQUIREMENTS: (CHAPTER 10; TABLE 1004.1.2)
OCCUPANT LOAD
GROUP U UTILITY 12 OCCUPANTS - (6 MEN; 6 WOMEN) BASED ON NUMBER OF FIXTURES AVAILABLE FOR
TOTAL OCCUPANT LOAD 12 OCCUPANTS

MEANS OF EGRESS: (CHAPTER 10, SECTION 1015; TABLE 1015.1)
EXITS
EXITS REQUIRED: 1
EXITS PROVIDED: 1 EACH FROM MEN AND WOMEN RESTROOM

COMMON PATH OF TRAVEL (CHAPTER 10; SECTION 1014; TABLE 1014.3):
GROUP U, NON-SPRINKLERED
ACTUAL: 40'-0"
ALLOWED: 75'-0"

EXIT ACCESS TRAVEL DISTANCE (CHAPTER 10; SECTION 1016; TABLE 1016.2):
GROUP A-3, NON-SPRINKLERED - 300'
ACTUAL: 40'-0"
ALLOWED: 300'-0"

EXIT LOAD:
12 OCCUPANT/2 EXITS PROVIDED: 6 OCCUPANTS PER EXIT

EXIT STAIRWAYS (CHAPTER 10, SECTION 1005.3.1, SECTION 1009):
NOT REQUIRED

EXIT STAIRWAY FIRE RESISTANCE RATING (CHAPTER 10, SECTION 1005.3.1, SECTION 1009.3.1.2):
LESS THAN 4 STORIES: 1 HOUR FIRE RATING REQUIRED - N/A

EXIT CORRIDORS:
WIDTH (CHAPTER 10, SECTION 1005.3.2, SECTION 1018):
REQUIRED WIDTH: 6 OCCUPANTS x 0.2 CAPACITY FACTOR = 1.2"
PROVIDED WIDTH: 48" MIN.
MINIMUM CORRIDOR WIDTH (TABLE 1018.2): 44"

EXIT CORRIDOR FIRE RESISTANCE RATING (CHAPTER 7, SECTION 722.6; CHAPTER 10, SECTION 1018, TABLE 1018.1):
GROUP U, NON-SPRINKLERED AND OCCUPANT LOAD LESS THAN 30; NO RATING REQUIRED FOR WALLS AND CEILING.

EXIT DOORS:
WIDTH (CHAPTER 10, SECTION 1008):
REQUIRED WIDTH: 6 OCCUPANTS x 0.2 CAPACITY FACTOR = 1.2"
2 PROVIDED - 1 EACH MEN &

PROVIDE WIDTH: WOMEN RESTROOM 36" MIN.
MINIMUM CLEAR WIDTH (SECTION 1008.1.1) 32"

FIRESTOPPING:
NONE REQUIRED

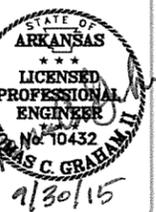


Table with columns: Job No., Job Name, Date, Description, Symbol, Issued For Construction

Table with columns: Job Number, Submitted by, Plot Scale, Plot Date, Drawn by, Checked by, File Name

ARKANSAS HIGHWAY AND TRANSPORTATION DEPARTMENT
ARIZONA TOURIST INFORMATION CENTER
(WHITE RIVER) (S)
JOB 061451
CODE ANALYSIS

Sheet Reference Number
G-003
Sheet 3 of 130

GENERAL NOTES:

1. GRADE LINE DENOTES FINISHED GRADE WHERE SHOWN ON PLANS.
2. ALL PIPE LINES, POWER, TELEPHONE, AND TELEGRAPH LINES TO BE MOVED OR LOWERED BY THE RESPECTIVE OWNERS AS PER AGREEMENT WITH SUCH OWNERS.
3. ANY EQUIPMENT OR APPURTENANCE THAT INTERFERES WITH THE PROPOSED CONSTRUCTION AND WHICH MAY BE THE PROPERTY OF UTILITY SERVICE ORGANIZATIONS SHALL BE MOVED BY THE OWNERS UNLESS OTHERWISE PROVIDED.
4. ALL LAND MONUMENTS LOCATED WITHIN THE CONSTRUCTION AREA SHALL BE PROTECTED IN ACCORDANCE WITH SECTION 107.12 OF THE STANDARD SPECIFICATIONS.
5. ALL TREES THAT DO NOT DIRECTLY INTERFERE WITH THE PROPOSED CONSTRUCTION SHALL BE SPARED AS DIRECTED BY THE ENGINEER. CARE AND DISCRETION SHALL BE USED TO INSURE THAT ALL TREES NOT TO BE REMOVED SHALL BE HARMED AS LITTLE AS POSSIBLE DURING THE CONSTRUCTION OPERATIONS.
6. THE EXISTING CONCRETE SIDEWALK TO BE REMOVED FROM THE REMAINING SIDEWALK SHALL BE SEPARATED BY SAWING ALONG A NEAT LINE. AFTER SAWING, THE SIDEWALK TO BE REMOVED SHALL BE CAREFULLY REMOVED IN A MANNER THAT WILL NOT DAMAGE THE SIDEWALK THAT IS TO REMAIN. ANY DAMAGE OF THE SIDEWALK THAT IS TO REMAIN IN PLACE SHALL BE REPAIRED AT THE CONTRACTOR'S EXPENSE.
7. ALL FLEXIBLE BASE AND ASPHALTIC PAVEMENTS REMOVED SHALL BE PAID FOR UNDER THE ITEM NO. 210 - UNCLASSIFIED EXCAVATION.
8. THE EXISTING ASPHALT PAVEMENT TO BE REMOVED FROM THE REMAINING PAVEMENT SHALL BE SEPARATED BY SAWING ALONG A NEAT LINE. AFTER SAWING, THE PAVEMENT TO BE REMOVED SHALL BE CAREFULLY REMOVED IN A MANNER THAT WILL NOT DAMAGE THE PAVEMENT THAT IS TO REMAIN. ANY DAMAGE OF THE ASPHALT PAVEMENT THAT IS TO REMAIN IN PLACE SHALL BE REPAIRED AT THE CONTRACTOR'S EXPENSE.

GOVERNING SPECIFICATIONS

ARKANSAS STATE HIGHWAY COMMISSION STANDARD SPECIFICATIONS FOR HIGHWAY CONSTRUCTION, EDITION OF 2014, AND THE FOLLOWING SPECIAL PROVISIONS AND SUPPLEMENTAL SPECIFICATIONS:

ERRATA _____ ERRATA FOR THE BOOK OF STANDARD SPECIFICATIONS

- FHWA-1273 _____ REQUIRED CONTRACT PROVISIONS FEDERAL-AID CONSTRUCTION CONTRACTS
- FHWA-1273 _____ SUPPLEMENT - EQUAL EMPLOYMENT OPPORTUNITY - NOTICE TO CONTRACTORS
- FHWA-1273 _____ SUPPLEMENT - SPECIFIC EQUAL EMPLOYMENT OPPORTUNITY RESPONSIBILITIES (23 U.S.C. 140)
- FHWA-1273 _____ SUPPLEMENT - EQUAL EMPLOYMENT OPPORTUNITY - GOALS AND TIMETABLES
- FHWA-1273 _____ SUPPLEMENT - EQUAL EMPLOYMENT OPPORTUNITY - FEDERAL STANDARDS
- FHWA-1273 _____ SUPPLEMENT - POSTERS AND NOTICES REQUIRED FOR FEDERAL-AID PROJECTS
- FHWA-1273 _____ SUPPLEMENT - WAGE RATE DETERMINATION
- FHWA-1273 _____ SUPPLEMENT - WAGE RATE DETERMINATION - BUILDING

- 100-3 _____ CONTRACTOR'S LICENSE
- 108-1 _____ LIQUIDATED DAMAGES
- 620-1 _____ MULCH COVER

- JOB 061451 _____ BIDDING REQUIREMENTS AND CONDITIONS
- JOB 061451 _____ BROADBAND INTERNET SERVICE FOR FIELD OFFICE
- JOB 061451 _____ BUILDERS RISK INSURANCE
- JOB 061451 _____ COMPETENCY OF BIDDERS
- JOB 061451 _____ DOCUMENTATION OF PAYMENTS MADE TO DISADVANTAGED BUSINESS ENTERPRISES
- JOB 061451 _____ MANDATORY ELECTRONIC CONTRACT
- JOB 061451 _____ MEASUREMENT AND PAYMENT
- JOB 061451 _____ PARTNERING REQUIREMENTS
- JOB 061451 _____ PROJECT MANUAL
- JOB 061451 _____ STANDARD SPECIFICATIONS APPLICABILITY
- JOB 061451 _____ STORM WATER POLLUTION PREVENTION PLAN
- JOB 061451 _____ UTILITY ADJUSTMENTS
- JOB 061451 _____ VALUE ENGINEERING

ARKANSAS TOURIST INFORMATION CENTER (WHITE RIVER) (S) JOB NO. 061451

THE CONTRACTOR SHALL PROVIDE ALL OF THE WATER AND SANITARY SEWER SERVICES NECESSARY TO PROVIDE UTILITY SERVICES TO THE TOURIST INFORMATION CENTERS (TICS) (EASTBOUND AND WESTBOUND) AND THE TRUCKER-VENDING BUILDINGS (EASTBOUND AND WESTBOUND). ELECTRICAL WORK SHALL INCLUDE ALL SITE LIGHTING AND BUILDING ELECTRICAL SERVICES FOR THE TICS, THE MAINTENANCE BUILDING, AND THE TRUCKER-VENDING BUILDINGS. THE CONTRACTOR IS RESPONSIBLE FOR THE DEMOLITION AND RE-ROUTING OF EXISTING UTILITIES THAT INTERFERE WITH THE CONSTRUCTION OF THE NEW TICS, MAINTENANCE BUILDING, AND TRUCKER-VENDING BUILDINGS.

OWNER:

ARKANSAS STATE HIGHWAY AND TRANSPORTATION DEPARTMENT
P.O. BOX 2261
LITTLE ROCK, ARKANSAS 72203-2261

CONTACT: RAY GRUVER, SECTION HEAD
MAINTENANCE DIVISION, FACILITIES MANAGEMENT SECT.
PHONE: 501-569-2090
FAX: 501-569-2011

OPERATOR:

ARKANSAS STATE HIGHWAY AND TRANSPORTATION DEPARTMENT

DESIGN FIRM ARCHITECTURE AND ENGINEERING:

GARVER, LLC
4701 NORTHSHORE DRIVE
NORTH LITTLE ROCK, ARKANSAS 72218
PHONE: 501-376-3633
FAX: 501-372-8042

ARCHITECT: JOHN RAMSEY, R.A.

MECHANICAL ENGINEER: LEE SUGGS, P.E.

STRUCTURAL ENGINEER: DAVID CLEMENT, P.E.

ELECTRICAL ENGINEER: BRYAN MELTON, P.E.

CIVIL ENGINEER: THOMAS GRAHAM, P.E.


"I HEREBY CERTIFY THAT THESE PLANS AND SPECIFICATIONS HAVE BEEN PREPARED BY ME, OR UNDER MY SUPERVISION. I FURTHER CERTIFY THAT TO THE BEST OF MY KNOWLEDGE THESE PLANS AND SPECIFICATIONS ARE AS REQUIRED BY LAW AND IN COMPLIANCE WITH THE ARKANSAS FIRE PREVENTION CODE FOR THE STATE OF ARKANSAS."

Thomas C. Graham II
THOMAS C. GRAHAM II, ENGINEER

John Ramsey
JOHN RAMSEY, R.A.



4701 Northshore Drive
Little Rock, AR 72118
501-376-3633
www.GarverUSA.com

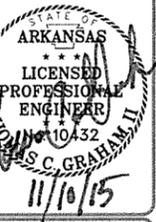

Job Number	060451
Submitted by	J. E. SE
Submitted by Date	11/10/15
Plot Scale	1:1
Plot Date	11/10/15
Drug Code	
Designed by	T. GRAHAM
Drawn by	T. BARTON
Checked by	G. ARCHER
File Name	ARKSHR-G-004.DWG
Job Name	ARKANSAS HIGHWAY AND TRANSPORTATION DEPARTMENT ARKANSAS TOURIST INFORMATION CENTER (WHITE RIVER) (S) JOB 061451
IFC Symbol	ISSUED FOR CONSTRUCTION
Date	10/1/15
Appr	JJR

Job Number	060451
Submitted by	J. E. SE
Submitted by Date	11/10/15
Plot Scale	1:1
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ARKANSAS HIGHWAY AND TRANSPORTATION DEPARTMENT
ARKANSAS TOURIST INFORMATION CENTER
(WHITE RIVER) (S)
JOB 061451

GOVERNING SPECIFICATIONS

Sheet Reference Number:
G-004
Sheet 4 of 130

SUMMARY OF QUANTITIES

SUMMARY OF QUANTITIES AHTD Job No. 061451			
ITEM NUMBER	ITEM	QUANTITY	UNIT
201	CLEARING	0.50	ACRE
201	GRUBBING	0.50	ACRE
201	CLEARING AND GRUBBING TREES	1	EACH
202	REMOVAL AND DISPOSAL OF BUILDINGS	8	EACH
202	REMOVAL AND DISPOSAL OF CONCRETE WALKS	1489	SOYD
202	REMOVAL AND DISPOSAL OF CURB AND GUTTER	72	LF
202	REMOVAL AND DISPOSAL OF FENCE	112	LF
202	REMOVAL AND DISPOSAL OF LIGHT POLE	2	EACH
202	REMOVAL AND DISPOSAL OF PIPE	338	LF
202	REMOVAL AND DISPOSAL OF POLE AND FOUNDATION	1	EACH
202	REMOVAL AND DISPOSAL OF WALLS	65	LF
202	REMOVAL AND DISPOSAL OF WATER SPIGOT	2	EACH
202	REMOVAL AND RELOCATION OF LIGHT POLE	2	EACH
202	REMOVAL AND RELOCATION OF SIGN	4	EACH
210	UNCLASSIFIED EXCAVATION	4250	CUYD
210	COMPACTED EMBANKMENT	4600	CUYD
601	MOBILIZATION	1.00	L.S.
SP & 602	FURNISHING FIELD OFFICE	1	EACH
603	MAINTENANCE OF TRAFFIC	1.00	L.S.
604	REMOVAL OF PERMANENT PAVEMENT MARKINGS	211	LF
604	REMOVAL OF PERMANENT PAVEMENT MARKINGS (WHEELCHAIR EMBLEMS)	4	EACH
620	SEEDING	1.09	ACRE
SS & 620	MULCH COVER	1.86	ACRE
620	WATER	165.9	MGAL
620	LIME	2	TON
621	TEMPORARY SEEDING	1.86	ACRE
621	SILT FENCE	1609	LF
621	SEDIMENT REMOVAL AND DISPOSAL	50	CUYD
624	SOLID SODDING	1332	SOYD
633	CONCRETE WALKS	1299	SOYD
633	CONCRETE STEPS	5	SOYD
633	HAND RAILING	14	LF
641	WHEELCHAIR RAMPS (TYPE SPECIAL)	48	SOYD
718	REFLECTORIZED PAINT PAVEMENT MARKING WHITE (4")	720	LF
718	REFLECTORIZED PAINT PAVEMENT MARKING SYMBOLS (WHEELCHAIR)	4	EACH
SP	SITE UTILITIES	1.00	L.S.
SP	SITE FURNISHINGS	1.00	L.S.
SP	EXTERIOR ELECTRICAL DISTRIBUTION	1.00	L.S.
SP	EXTERIOR AREA LIGHTING	1.00	L.S.
SP	TOURIST INFORMATION CENTER FACILITY	2.00	L.S.
SP	MAINTENANCE BUILDING	1.00	L.S.
SP	TRUCKER-VENDING BUILDING	2.00	L.S.

FOR INFORMATION ONLY

SITE UTILITIES AHTD Job No. 061451			
ITEM	ITEM	QUANTITY	UNIT
	6" SDR 26 PVC SANITARY SEWER	136	LF
	4" SDR 26 PVC SANITARY SEWER	68	LF
	SANITARY SEWER CLEANOUT	4	EACH
	TWO-WAY SANITARY SEWER CLEANOUT	6	EACH
	4" WATER LINE	1360	LF
	4" VALVE	8	EACH
	4"x4" TEE	4	EACH
	5"x4" TEE	1	EACH
	4"-450 BEND	18	EACH
	4"-900 BEND	1	EACH
	4" TO 1" REDUCER	2	EACH
	4"x1" TEE	2	EACH
	1" VALVE	4	EACH
	1" WATER LINE	47	LF
	4" X 2" TEE	1	EACH
	2" VALVE	1	EACH
	2" WATER LINE	10	LF
	4"x1 1/4" TEE	8	EACH
	1 1/4" VALVE	8	EACH
	1 1/4" WATER LINE	93	LF
	4"x2 1/2" TEE	4	EACH
	2 1/2" TO 2" REDUCER	2	EACH
	2 1/2" VALVE	6	EACH
	2 1/2" WATER LINE	102	LF

EROSION CONTROL PLAN REVISION

DATE	REVISION

FOR INFORMATION ONLY

REMOVAL AND DISPOSAL OF PIPE AHTD Job No. 061451			
ITEM	ITEM	QUANTITY	UNIT
	SANITARY SEWER LINE	80	LF
	WATER LINE	258	LF

REVISIONS

REVISION AHTD Job No. 061451		
DATE	REVISION	SHEET NUMBER


EROSION CONTROL

EROSION CONTROL											
STATION	STATION	LOCATION	PERMANENT EROSION CONTROL				TEMPORARY EROSION CONTROL				*SEDIMENT REMOVAL & DISPOSAL
			SEEDING	WATER	LIME	SOLID SODDING	TEMPORARY SEEDING	MULCH COVER	WATER	SILT FENCE (E-11)	
			ACRE	MGAL	TON	SOYD	ACRE	ACRE	MGAL	LF	CUYD
ENTIRE	PROJECT	ENTIRE SITE	1.09	128.0	2.0	1332	1.86	1.86	37.9	1609	50
*ENTIRE PROJECT TO BE USED IF AND WHERE DIRECTED BY THE ENGINEER.											
TOTALS:			1.09	128.0	2.0	1332	1.86	1.86	37.9	1609	50

BASIS OF ESTIMATE:
 LIME.....2 TONS / ACRE OF SEEDING.
 WATER.....102 M.G. / ACRE OF SEEDING.
 WATER.....20.4 M.G. / ACRE OF TEMPORARY SEEDING.
 WATER.....12.6 GAL. / SQ. YD. OF SOLID SODDING.

NOTE: THE TEMPORARY EROSION CONTROL DEVICES SHOWN ABOVE AND ON THE PLANS SHALL BE INSTALLED IN SUCH A SEQUENCE AS TO DETER EROSION AND SEDIMENTATION ON U.S. WATERWAYS AS EXPLAINED BY THE NATIONAL POLLUTANT DISCHARGE ELIMINATION SYSTEM PERMIT.

*QUANTITIES ARE ESTIMATED.
 SEE SECTION 104.03 OF THE STD. SPECS.

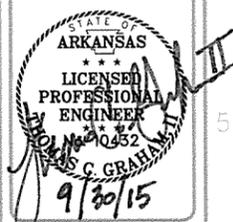

JRR	Appr.
10/1/15	Date
ISSUED FOR CONSTRUCTION	Description
IPC	Symbol

Job Number 061451	Submitted by John T. Grahm Director, Federal Services	Plot Scale 1:1	Plot Date 10/1/15	Drawn by T. BARTON	Checked by G. ARCHER	File Name AHTD-SW-G-005.DWG
N/A	N/A	N/A	N/A	N/A	N/A	N/A

ARKANSAS HIGHWAY AND TRANSPORTATION DEPARTMENT
 ARKANSAS TOURIST INFORMATION CENTER
 (WHITE RIVER) (S)
 JOB 061451

SUMMARY OF QUANTITIES

GENERAL SITE NOTES:

- CAUTION: UNDERGROUND UTILITIES LIE WITHIN AND ADJACENT TO THE LIMITS OF CONSTRUCTION. AN ATTEMPT HAS BEEN MADE TO LOCATE THESE UTILITIES ON THE PLANS, HOWEVER ALL EXISTING UTILITIES MAY NOT BE SHOWN AND THE ACTUAL LOCATIONS OF THE UTILITIES MAY VARY FROM LOCATIONS SHOWN. PRIOR TO BEGINNING ANY TYPE OF EXCAVATION, THE CONTRACTOR SHALL MARK THE VISIBLE UTILITIES & THE UTILITIES SHOWN ON THE PLANS IN THE FIELD. THE CONTRACTOR SHALL MAINTAIN THE UTILITY LOCATION MARKING UNTIL THEY ARE NO LONGER NECESSARY. USE EXTREME CAUTION WHEN EXCAVATING.
- DIMENSIONS ARE GIVEN TO BACK OF CURB, CENTER OF STRIPE, FACE OF BUILDING, EDGE OF PAVEMENT, OR PROPERTY LINE.
- COORDINATES GIVEN FOR RADII ARE FROM THE CENTER OF THE RADIUS.
- THE CONTRACTOR IS RESPONSIBLE FOR THE APPROPRIATE BARRICADES AND SAFETY PRECAUTIONS IN ALL EXCAVATED AREAS. EXCAVATED AREAS SHALL BE ADEQUATELY FILLED OR COVERED BY THE CONTRACTOR BEFORE LEAVING THE JOB SITE EACH DAY.
- THE CONTRACTOR IS RESPONSIBLE FOR DAMAGE TO EXISTING STRUCTURES, PAVEMENTS, AND UTILITIES.
- THE CONTRACTOR SHALL MAINTAIN THE SITE IN AN ORDERLY AND CLEAN FASHION.
- ALL WASTE MATERIALS GENERATED FROM CONSTRUCTION BECOME THE PROPERTY OF THE CONTRACTOR. THE CONTRACTOR SHALL REMOVE THE WASTE MATERIALS FROM THE SITE AND DISPOSE OF IN A LEGAL MANNER.
- SEE ARCHITECTURAL PLANS FOR BUILDING ACCESS AND A/C CONDENSER DETAILS.
- ALL REINFORCING STEEL SHALL BE GRADE A-60.
- THE CONTRACTOR IS TO REMOVE OR RELOCATE, WHEN APPLICABLE, EASEMENTS, AND CONNECTING IMPROVEMENTS, DRAIN PIPES, POWER POLES AND GUY WIRES, WATER METERS AND WATER LINES, WELLS, SIGN POLES, UNDERGROUND GAS, SEPTIC TANKS, AND ASPHALT, SHOWN AND NOT SHOWN, WITHIN CONSTRUCTION LIMITS AND WHERE NEEDED, TO ALLOW FOR FILL MATERIAL, UNLESS OTHERWISE DENOTED, TO BE REMOVED AND AS "UNCLASSIFIED EXCAVATION".

GENERAL UTILITY NOTES:

- CAUTION: UNDERGROUND UTILITIES LIE WITHIN AND ADJACENT TO THE LIMITS OF CONSTRUCTION. AN ATTEMPT HAS BEEN MADE TO LOCATE THESE UTILITIES ON THE PLANS; HOWEVER, ALL EXISTING UTILITIES MAY NOT BE SHOWN AND THE ACTUAL LOCATIONS OF THE UTILITIES MAY VARY FROM LOCATIONS SHOWN. PRIOR TO BEGINNING ANY TYPE OF EXCAVATION, THE CONTRACTOR SHALL CONTACT THE UTILITIES INVOLVED AND MAKE ARRANGEMENTS FOR THE LOCATION OF THE UTILITIES ON THE GROUND. THE CONTRACTOR SHALL MAINTAIN THE UTILITY LOCATION MARKING UNTIL THEY ARE NO LONGER NECESSARY.
- THE CONTRACTOR SHALL VERIFY HORIZONTAL AND VERTICAL LOCATION AND SIZE FOR ALL EXISTING STORM SEWER STRUCTURES, PIPES, AND ALL UTILITIES PRIOR TO CONSTRUCTION.
- THE CONTRACTOR IS RESPONSIBLE FOR REPAIRS OF DAMAGE TO ANY EXISTING IMPROVEMENTS DURING CONSTRUCTION, SUCH AS, BUT NOT LIMITED TO, UTILITIES, PAVEMENT, STRIPING, CURBS, ETC. REPAIRS SHALL BE EQUAL TO OR BETTER THAN EXISTING CONDITIONS.
- THE CONTRACTOR SHALL REFER TO ARCHITECTURAL PLANS AND SPECIFICATIONS FOR ACTUAL LOCATION OF ALL UTILITY ENTRANCES TO INCLUDE SANITARY SEWER LATERALS, DOMESTIC AND FIRE PROTECTION WATER SERVICE, ELECTRICAL, TELEPHONE, AND COMMUNICATIONS. CONTRACTOR SHALL COORDINATE INSTALLATION OF UTILITIES IN SUCH A MANNER AS TO AVOID CONFLICTS AND ASSURE PROPER DEPTHS ARE ACHIEVED AS WELL AS COORDINATING WITH LOCAL UTILITY REQUIREMENTS AS TO LOCATIONS AND SCHEDULING FOR TIE-INS/CONNECTIONS PRIOR TO CONNECTING EXISTING FACILITIES.
- THE CONTRACTOR SHALL COMPLY TO THE FULLEST EXTENT WITH THE LATEST STANDARD OF OSHA DIRECTIVES OR ANY OTHER AGENCY HAVING JURISDICTION FOR EXCAVATION AND TRENCHING PROCEDURES. THE CONTRACTOR SHALL USE SUPPORT SYSTEMS, SLOPING, BENCHING, AND OTHER MEANS OF PROTECTION. THIS TO INCLUDE, BUT NOT LIMITED TO, ACCESS AND EGRESS FROM ALL EXCAVATION AND TRENCHING. CONTRACTOR IS RESPONSIBLE FOR COMPLIANCE WITH PERFORMANCE CRITERIA FOR OSHA.
- THE MINIMUM HORIZONTAL SEPARATION BETWEEN THE CLOSEST TWO POINTS OF THE WATER AND SEWER LINE IS TEN (10) FEET, OR MINIMUM VERTICAL SEPARATION BETWEEN THE CLOSEST TWO POINTS OF THE WATER AND SEWER LINE IS EIGHTEEN (18) INCHES.
- THE CONTRACTOR SHALL, ON ALL UTILITIES, COORDINATE INSPECTION WITH THE APPROPRIATE AUTHORITIES PRIOR TO COVERING TRENCHES AT INSTALLATION.
- THE CONTRACTOR SHALL COORDINATE UTILITY INSTALLATIONS WITH LOCAL GOVERNING AUTHORITIES. PAYMENT OF ALL FEES REGARDING THE INSTALLATION OF UTILITIES (I.E. TAPPING FEES, PERMIT FEES, INSTALLATION FEES, METER FEES, ETC.) SHALL BE THE RESPONSIBILITY OF THE CONTRACTOR.

WATER NOTES:

- ALL WATERLINES (12-INCHES OR LESS) SHALL BE FABRICATED FROM PVC C-900, DR18.
- ALL PVC WATER LINE MATERIAL SHALL BE BLUE.
- ALL MECHANICAL JOINT BENDS USED ON WATER MAINS 4-INCHES AND LARGER, SHALL BE RESTRAINED USING RESTRAINED FITTINGS OR CONCRETE THRUST BLOCKS.
- PROVIDE METALLIC TAPE ABOVE ALL WATER DISTRIBUTION LINE ROUTES. INCLUDE A #10 INSULATED COPPER LOCATOR WIRE ABOVE THE PIPE. WIRE SHALL BE BROUGHT TO GRADE AT VALVE BOXES AND HYDRANTS.
- PROVIDE CHLORINATION AND INDEPENDENT TESTING OF WATER SAMPLES FOR NEWLY INSTALLED WATER MAINS AND SERVICE PIPING, IN ACCORDANCE WITH THE ARKANSAS DEPARTMENT OF HEALTH. SAMPLING AND TESTING SHALL BE PERFORMED BY A CERTIFIED LABORATORY QUALIFIED TO PERFORM WATER TESTING.
- PROVIDE A MINIMUM COVER OF THIRTY (30) INCHES FROM FINISHED GRADE TO THE TOP OF THE PIPE UNLESS OTHERWISE SPECIFIED.
- DIG THROUGH LOCATOR TAPE SHALL BE BURIED 2 FEET ABOVE LINE.
- ALL IRON PIPE AND FITTINGS SHALL BE POLYWRAPPED.
- BEDDING, BACKFILL, AND COMPACTION OVER WATER LINES SHALL BE IN ACCORDANCE WITH THE SPECIFICATIONS.
- THE CONTRACTOR SHALL NOTIFY THE ENGINEER A MINIMUM OF 5 FULL BUSINESS DAYS PRIOR TO CLOSING A LANE/ROAD. IF THE CONTRACTOR FAILS TO GIVE THE PROPER NOTIFICATION, THE LANE/ROAD CLOSURE WILL NOT BE ALLOWED UNTIL 5 FULL BUSINESS DAYS AFTER THE NOTIFICATION WAS GIVEN.
- THRUST BLOCKS SHALL BE PROVIDED AT ALL HORIZONTAL BENDS, TEES, AND FIRE HYDRANTS. SEE DETAILS.
- REFERENCE ARCHITECTURAL PLANS FOR ALL SERVICE CONNECTION LOCATIONS.
- ALL VERTICAL BENDS ON WATER MAIN SHALL BE RESTRAINED WITH A MECHANICAL JOINT FITTING SUPPLIED WITH THE RETAINER GLANDS. ANY JOINTS 25 FEET OR LESS FROM EITHER SIDE OF VERTICAL BEND SHALL BE RESTRAINED WITH A RETAINER GLAND.

SANITARY SEWER NOTES:

- ALL GRAVITY PIPING 4-INCHES TO 15-INCHES IN DIAMETER SHALL BE PVC, ASTM D3034, SDR 26 OR BETTER AND THE COLOR SHALL BE GREEN.
- THE DEPTH OF COVER FOR FORCE MAINS, GRAVITY MAINS, AND LATERALS SHALL NOT BE LESS THAN 36-INCHES.
- WASTEWATER GRAVITY OR FORCE MAINS SHALL MAINTAIN HORIZONTAL AND VERTICAL SEPARATION FROM WATER MAINS.
- INSTALLATION OF PVC PIPE SHALL BE IN ACCORDANCE WITH ASTM 2321. WHERE PVC ENTERS A MANHOLE, A SUITABLE MANHOLE COUPLER OR FLEXIBLE MANHOLE CONNECTOR SHALL BE INSTALLED IN THE MANHOLE WALL TO PROVIDE A WATER TIGHT CONNECTION.
- ALL MANHOLES SHALL BE 4-FOOT DIAMETER POLYETHYLENE LINED PRE-CAST CONCRETE ACCORDING TO ASTM C478. MINIMUM WALL THICKNESS SHALL BE OF 5-INCHES. MINIMUM MANHOLE ACCESS OF 22-INCHES IS REQUIRED. MAXIMUM DISTANCE BETWEEN MANHOLES SHALL BE 400 FEET.
- MANHOLE COVERS SHALL BE ABSOLUTELY LEVEL WITH THE PAVEMENT OR CONCRETE, AND 3-INCHES ABOVE THE FINAL FINISHED SURFACE IN GRASSY AREAS.
- ALL MANHOLE RINGS AND COVERS SHALL BE CAST IRON, AND HAVE THE WORD "SANITARY SEWER" MARKED IN EACH COVER.
- ALL SERVICE LATERALS SHALL BE AT LEAST 4-INCH DIAMETER, AND SHALL HAVE A SURFACE (FLUSH WITH THE GROUND) CLEANOUT MADE OF PVC BELL AND SPIGOT. THE CLEANOUT SHALL BE ENCASED WITH AN 18-INCH SQUARE OR ROUND BY 6-INCH THICK COLLAR.
- ALL SERVICE LATERALS CONNECTING TO THE COLLECTION LINES SHALL HAVE GASKET "WYED" FITTINGS MADE OF PVC, WHICH WILL BE HELD IN PLACE WITH STAINLESS STEEL BANDS.
- PROVIDE METALLIC TAPE ABOVE ALL SEWER LINE AND FORCE MAIN ROUTES. INCLUDE A #10 LOCATOR WIRE ALONG SIDE OF PIPE. WIRE SHALL BE BROUGHT TO GRADE AT VALVE BOXES.
- REFERENCE ARCHITECTURAL PLANS FOR ALL BUILDING SERVICE CONNECTION LOCATIONS.
- COORDINATES OR DIMENSIONS SHOWN ARE TO CENTERLINE OF PIPE OR TO CENTER OF MANHOLE.
- CONTRACTOR SHALL BE RESPONSIBLE FOR PAYING ALL APPLICABLE FEES FOR SANITARY SEWER INSTALLATION INCLUDING, BUT NOT LIMITED TO, TAPPING FEES, ETC.

GENERAL GRADING/DRAINAGE NOTES:

- PAVEMENT MARKINGS SHALL COMPLY WITH THE STANDARDS SET FORTH IN THE LATEST EDITION OF THE "MANUAL ON UNIFORM TRAFFIC CONTROL DEVICES" BY THE U. S. DEPARTMENT OF TRANSPORTATION.
- THE CONTRACTOR IS RESPONSIBLE FOR ADEQUATE EROSION CONTROL MEASURES. THESE MEASURES WILL SATISFY SECTION 109 OF THE STANDARD SPECIFICATIONS, SPECIAL PROVISIONS AND THE REQUIREMENTS OF THE ARKANSAS DEPARTMENT OF ENVIRONMENTAL QUALITY. EROSION CONTROL DEVICES WILL BE MAINTAINED UNTIL PERMANENT GROUND COVER IS ESTABLISHED. PERIMETER CONTROLS SHALL BE PLACED AS THE CLEARING AND GRUBBING OPERATIONS ARE STARTED.
- SEED, FERTILIZE AND MULCH AREAS DISTURBED BY CONSTRUCTION (EXCEPT AREAS TO BE PAVED). COMPLY WITH THE STANDARDS SET FORTH IN THE STANDARD SPECIFICATIONS.
- CONTRACTOR SHALL EMPLOY A QUALIFIED MATERIALS TESTING LABORATORY, ACCEPTABLE TO THE ENGINEER, TO PROVIDE TESTING SERVICES DURING CONSTRUCTION. TEST RESULTS SHALL BE PROMPTLY SENT TO THE OWNER/ENGINEER.
- CONTRACTOR SHALL MAINTAIN BENCHMARKS ON SITE UNTIL THE END OF CONSTRUCTION.


TELEPHONE AND COMMUNICATIONS NOTES:

- REFERENCE ARCHITECTURAL DOCUMENTS FOR ALL BUILDING SERVICE CONNECTIONS.
- ALL WORK SHALL BE COMPLETED TO AT&T SPECIFICATIONS AND STANDARDS.

POWER NOTES:

- REFERENCE ARCHITECTURAL DOCUMENTS FOR ALL BUILDING SERVICE CONNECTIONS.
- ALL WORK SHALL BE COMPLETED TO ENTERGY SPECIFICATIONS AND STANDARDS.

SITE SYMBOL LEGEND					
UTILITY OR FEATURE	EXISTING	PROPOSED	UTILITY OR FEATURE	EXISTING	PROPOSED
UTILITY POLE			POTABLE WATER	---	---WWT
WATER VALVE			SANITARY SEWER	---	---SS
SAN SEWER MANHOLE			SANITARY FORCED MAIN	---	---FM
TRANSFORMER			SITE GAS	---	---G
WATER METER			OH ELECTRIC SERVICE	---	---OHE
GAS METER			UG ELECTRIC SERVICE	---	---UE
FIRE HYDRANT			EASEMENT	---	---
DROP INLET			UG TELEVISION CABLE	---	---USTV
TREE			UG TELEPHONE	---	---USTP
TREE TO BE REMOVED OR TRANSPLANTED			UG FIBER OPTIC CABLE	---	---USFO
STORM SEWER			PROPERTY LINE	---	---PL
SIGN			RIGHT-OF-WAY	---	---ROW
TELEPHONE PEDESTAL			ROADWAY CENTER LINE	---	---RW
			BUILDING SET BACK	---	---BSL
			FIRE LINE		
			EROSION CONTROL		
			SILT FENCE		
			PROJECT BOUNDARY		
			INDEX CONTOURS		
			INTERMEDIATE CONTOURS		
			GUY WIRE		
			CURB AND GUTTER		
			TRAFFIC FLOW ARROW		
			CONCRETE		
			FLARED END SECTION		
			RIP RAP		
			ASPHALT PAVING		
			COMPACTED CLASS 7		
			AGG. BASE		

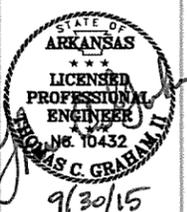

10/1/15	Apr	IFC	Symbol
10/1/15	Date	ISSUED FOR CONSTRUCTION	Description

000451	Job Number	N/A	N/A	N/A
Submitted by	Dir. of Reg. & Lic. Services	1:1	1:1	1:1
10/30/15	Print Date	9/30/15	Drawn Date	10/30/15
Designed by	T. GRAHAM	Checked by	O. ARCHER	File Name
Drawn by	T. BARTON			M11500-C-001.DWG

ARKANSAS HIGHWAY AND TRANSPORTATION DEPARTMENT
 ARKANSAS TOURIST INFORMATION CENTER
 (WHITE RIVER) (S)
 JOB 001451

GENERAL NOTES AND LEGEND

CONTROL POINT DATA

SURVEY CONTROL COORDINATES

Project Name: 061451 (CONTROL IS ORIGINALLY FROM JOB# 061316)
 Date: 8/31/2015
 Coordinate System: Arkansas State Plane Coordinates
 Based on AHTD GPS PT 590013, 590013A, 590014
 Projected to Ground Coordinates
 Units: U.S. Survey Foot

COORDINATES LISTED BELOW ARE GROUND (Localized) COORDINATES !!!!

Point No.	Northing	SY	Easting	SX	Elevation	SZ	Code	Feature	Point Description
1	2102494.586	0.0220	1472128.595	0.0150	204.12	0.004	CTL	PD:5/8" REBAR W/2" CAP	
2	2101954.9076	0.0080	1472074.1716	0.0060	201.37	0.005	CTL	PD:5/8" REBAR W/2" CAP	
3	2102116.2847	0.0070	1472675.6751	0.0080	177.80	0.007	CTL	PD:5/8" REBAR W/2" CAP	
4	2102708.5244	0.0110	1473407.9976	0.0090	176.89	0.007	CTL	PD:5/8" REBAR W/2" CAP	
8	2102969.9446	0.0131	1472117.3961	0.0121	198.56	0.004	CTL	PD:5/8" REBAR W/2" CAP	
9	2102998.9968	0.0179	1472546.5744	0.0143	176.18	0.007	CTL	PD:5/8" REBAR W/2" CAP	
10	2103081.4469	0.0213	1473005.5326	0.0148	175.20	0.007	CTL	PD:5/8" REBAR W/2" CAP	
100	2101994.4584	0.0001	1470426.4873	0.0001	192.09	0.000	GPS	PD:AHTD GPS 590013	
101	2102852.1180	0.0001	1471493.4509	0.0001	201.85	0.000	GPS	PD:AHTD GPS 590013A	
900	2102626.6058	30.0000	1472477.9030	30.0000	199.79	0.006	TBM	PD:CHISELED SQUARE SOUTHEAST CORNER OF BRIDGE	

Control Coordinates End- Control Datum, Metadata, & Notes Begin

*Standard Primary Control Monument - Rebar and Cap - Standard - 5/8" x 24" Rebar with 2" Aluminum Cap stamped: "(include all common information here)" plus other markings indicated in the point description of the individual point. AHTD monuments will be stamped "Arkansas Hwy & Trans Dept" with "PN: ###" & "Job #####". Monuments that are set by Consultants will be stamped "Arkansas Hwy & Trans Dept" with "PN:###", "Job#####", & "PS#####". The consultant Professional Surveyor in charge will stamp his/her PS license number on the cap.

**Standard GPS Control Point Monument - 5/8" x 48" Rebar with 2.5" Aluminum Cap stamped: "(include all common information here)" plus other markings indicated in the point description of the individual point. These monuments will be stamped "Ark. State Hwy Trans. Dept.", "GPS Survey", & "Point No. #####".
 SX, SY, SZ - Represents the standard error estimate of the coordinate values of each point at the 67% confidence level (one sigma) based on the least squares analysis of the control network. See the AASHTO SDMS Technical Data Guide data tag definition for SX, SY, and SZ for additional information. These values shall be used when control points are added and the entire network is reprocessed using least square analysis. A value of 0.001 is defined as fixed (no adjustment) in the least square analysis process. A value of 30 is defined as location by handheld GPS device or scaled from USGS Quadmap.

Reference Control points (1500 series) shall be used to re-establish horizontal datum if the primary control has been destroyed. These reference control points shall not be used for vertical control unless the elevation has been established from the project datum with 3-wire level techniques.

All additional project control shall be occupied, measured, and adjusted with direct survey ties to at least two of the control points listed in the table above. New survey control shall not be independent of the survey control listed above. This includes horizontal coordinates and elevations.

Positional Accuracy: Horizontal - GPS (1.0 cm ± 1PPM) 100 & 101
 Horizontal - Primary (2.0 cm ± 20PPM) PN: 1-4, 8-10
 Horizontal - Secondary (3 cm ± 50PPM) PN: N/A
 Vertical - NGS 1st Order (±4mm x vdist in km) PN: N/A
 Vertical - NGS 2nd Order (±6mm x vdist in km) PN: N/A
 Vertical - NGS 3rd Order (±8mm x vdist in km) PN: 900


Horizontal Datum: NAD 1983 (1997) State Plane Zone: 0302 - North Zone
 The adjustment year is based on metadata in the SDMS Control file
 A project CAF of: 1.0000144480 has been used to compute the above coordinates.
 The project CAF shall have a minimum precision of 9 digits right of the decimal.
Note: This project CAF is the same as Job 061316

This CAF is intended for use within the project limits only.
 Grid Distance = Ground Distance X CAF
 If Coordinates are listed as Ground:
 To compute Grid Coordinates, multiply the Ground Coordinates by CAF about the origin of X=0 & Y=0
 If Coordinates are listed as Grid:
 To compute Ground Coordinates, divide the Grid Coordinates by CAF about the origin of X=0 & Y=0



Vertical Datum: NAVD 1988 based NGS BM:
 A project Elevation Factor of: 0.9999908934 has been computed and incorporated in the above CAF.
 This is based on the average elevation of the project: 190.38 Feet
 3-Wire Leveling techniques have been used to establish elevations on
 Points: 1-4, 8-10, 100-101 From NGS BM 13 78, 5 109, D 31

Basis of Bearing: Grid Bearings based on AHTD GPS points: 590013, 590013A, 590014
 Convergence Angle is: 0-17-53.02 RIGHT at PN: 1
 LT: N 34-50-13.1 LG: W 091-28-02.82
 Grid Azimuth = Astronomical Azimuth - Convergence Angle

Control Datum, Metadata, & Notes End

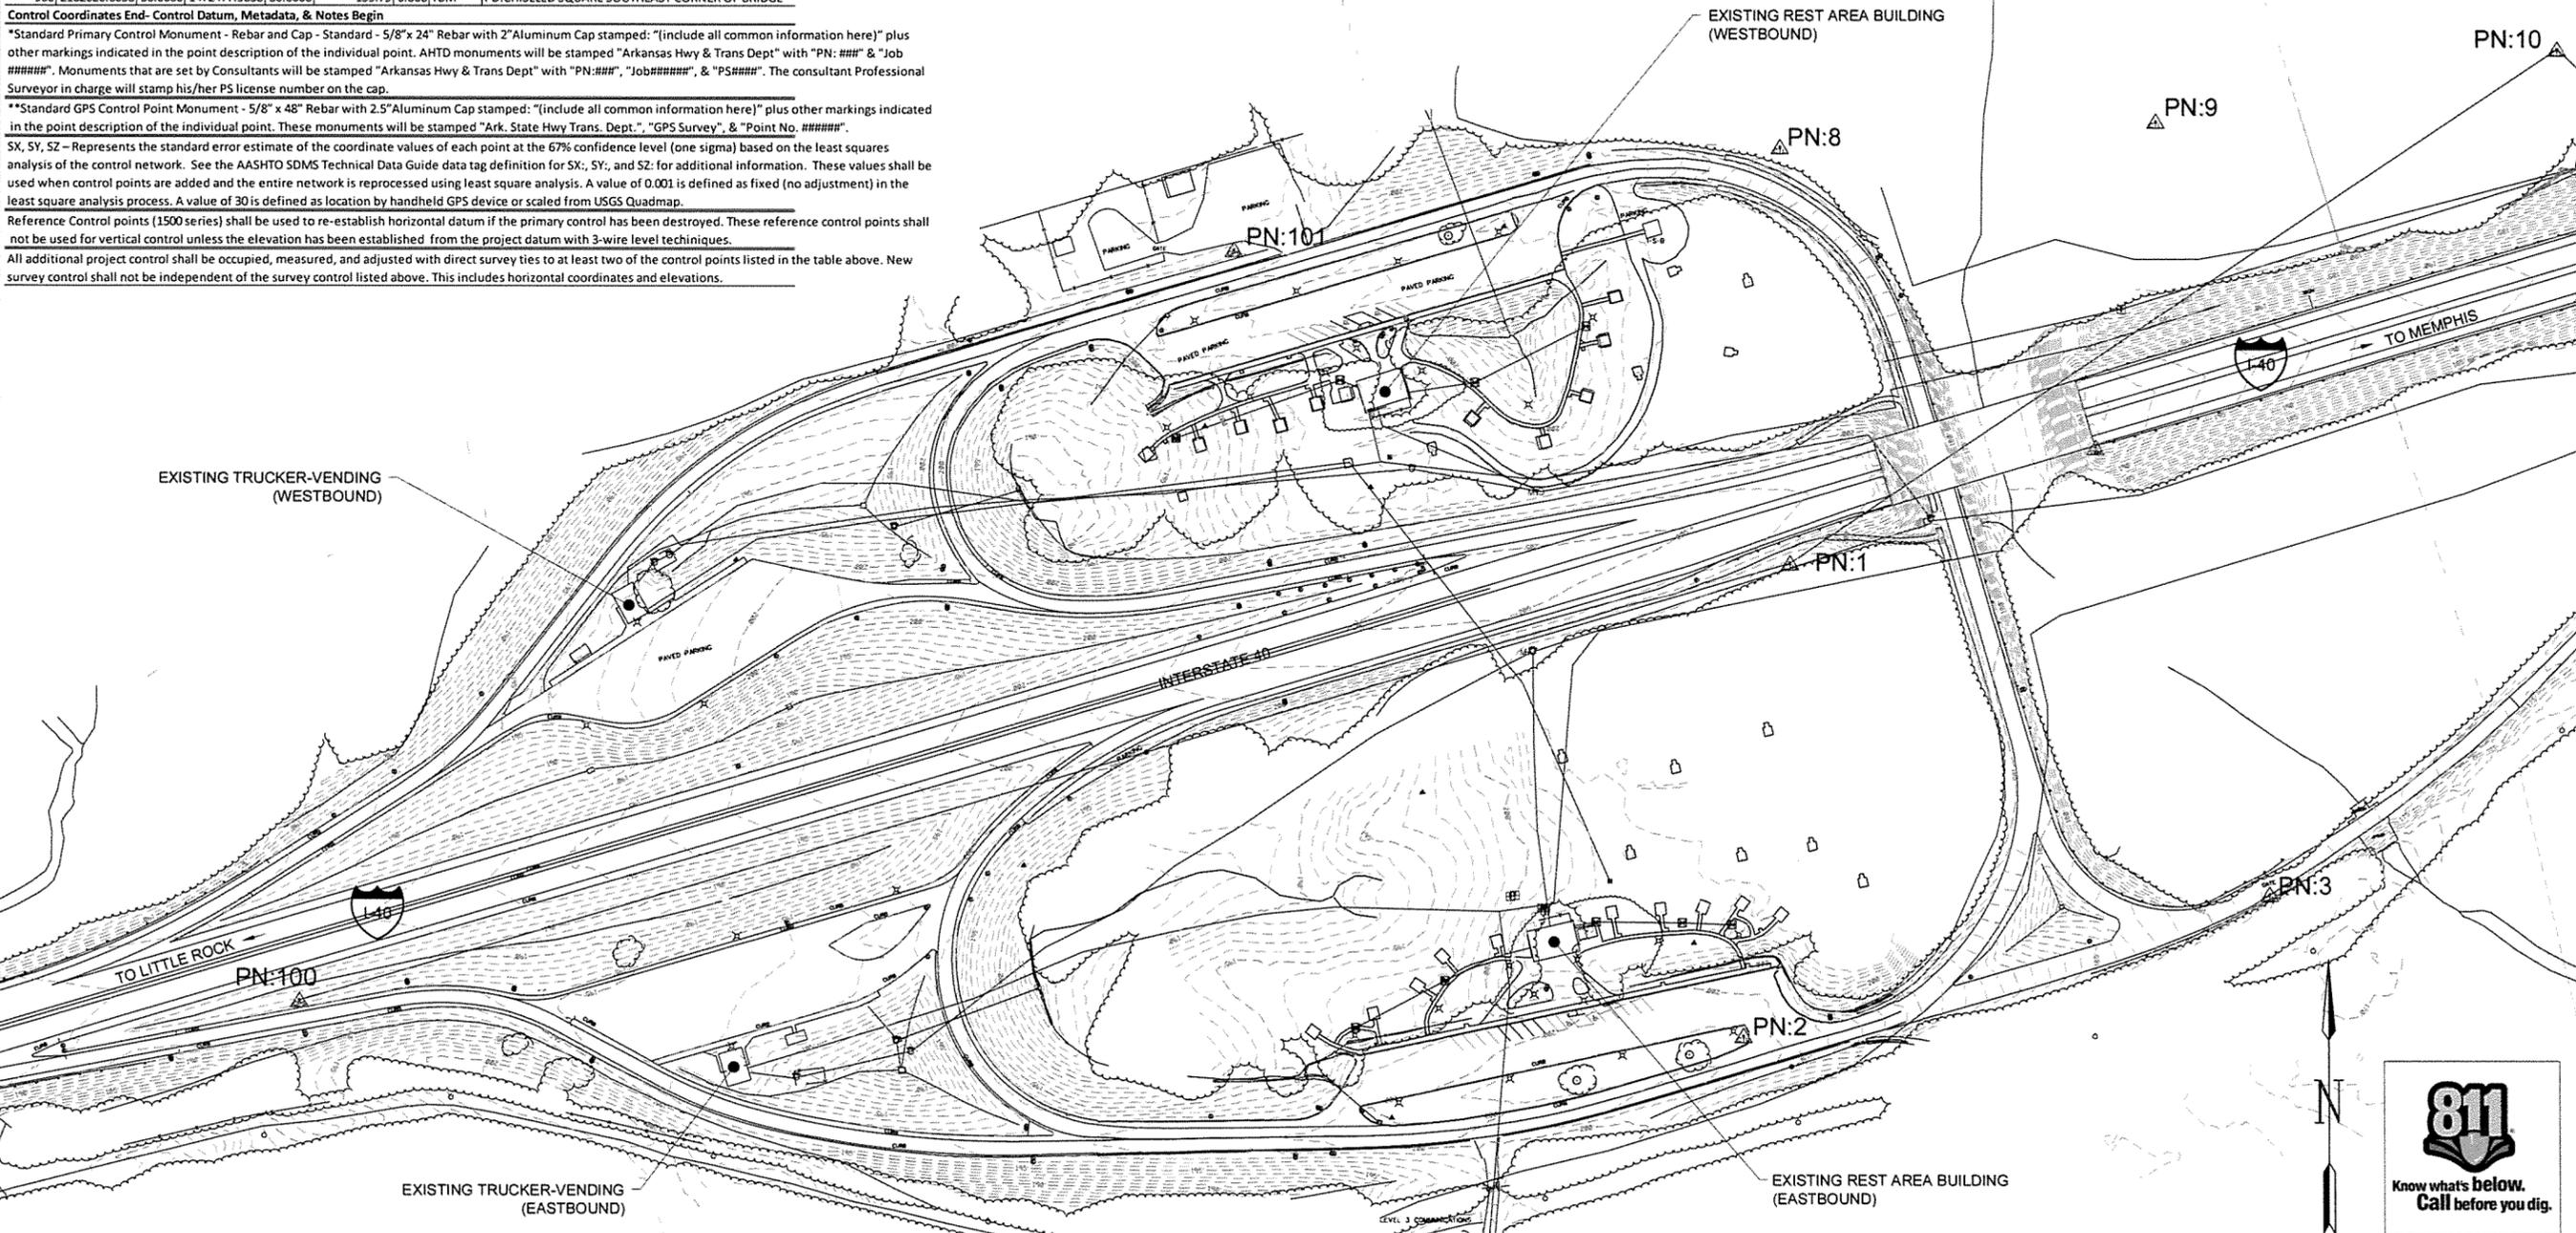

1 OVERALL SURVEY PLAN
 SCALE: 1" = 100'

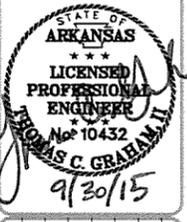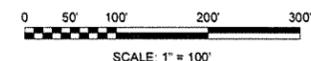


Job Number	Job Name	Issue Date	Issue For
061451			

Submitted by	Reviewed by	Drawn by	Checked by	File Name
John T. Moore III, PE, SE, Director, Federal Services		T. GRAHAM	G. ARCHER	AH1594R-C-002.DWG

ARKANSAS HIGHWAY AND TRANSPORTATION DEPARTMENT
 ARKANSAS TOURIST INFORMATION CENTER
 (WHITE RIVER) (S)
 JOB 061451
 OVERALL SURVEY PLAN

Sheet Reference Number:
C-002
 Sheet 7 of 130

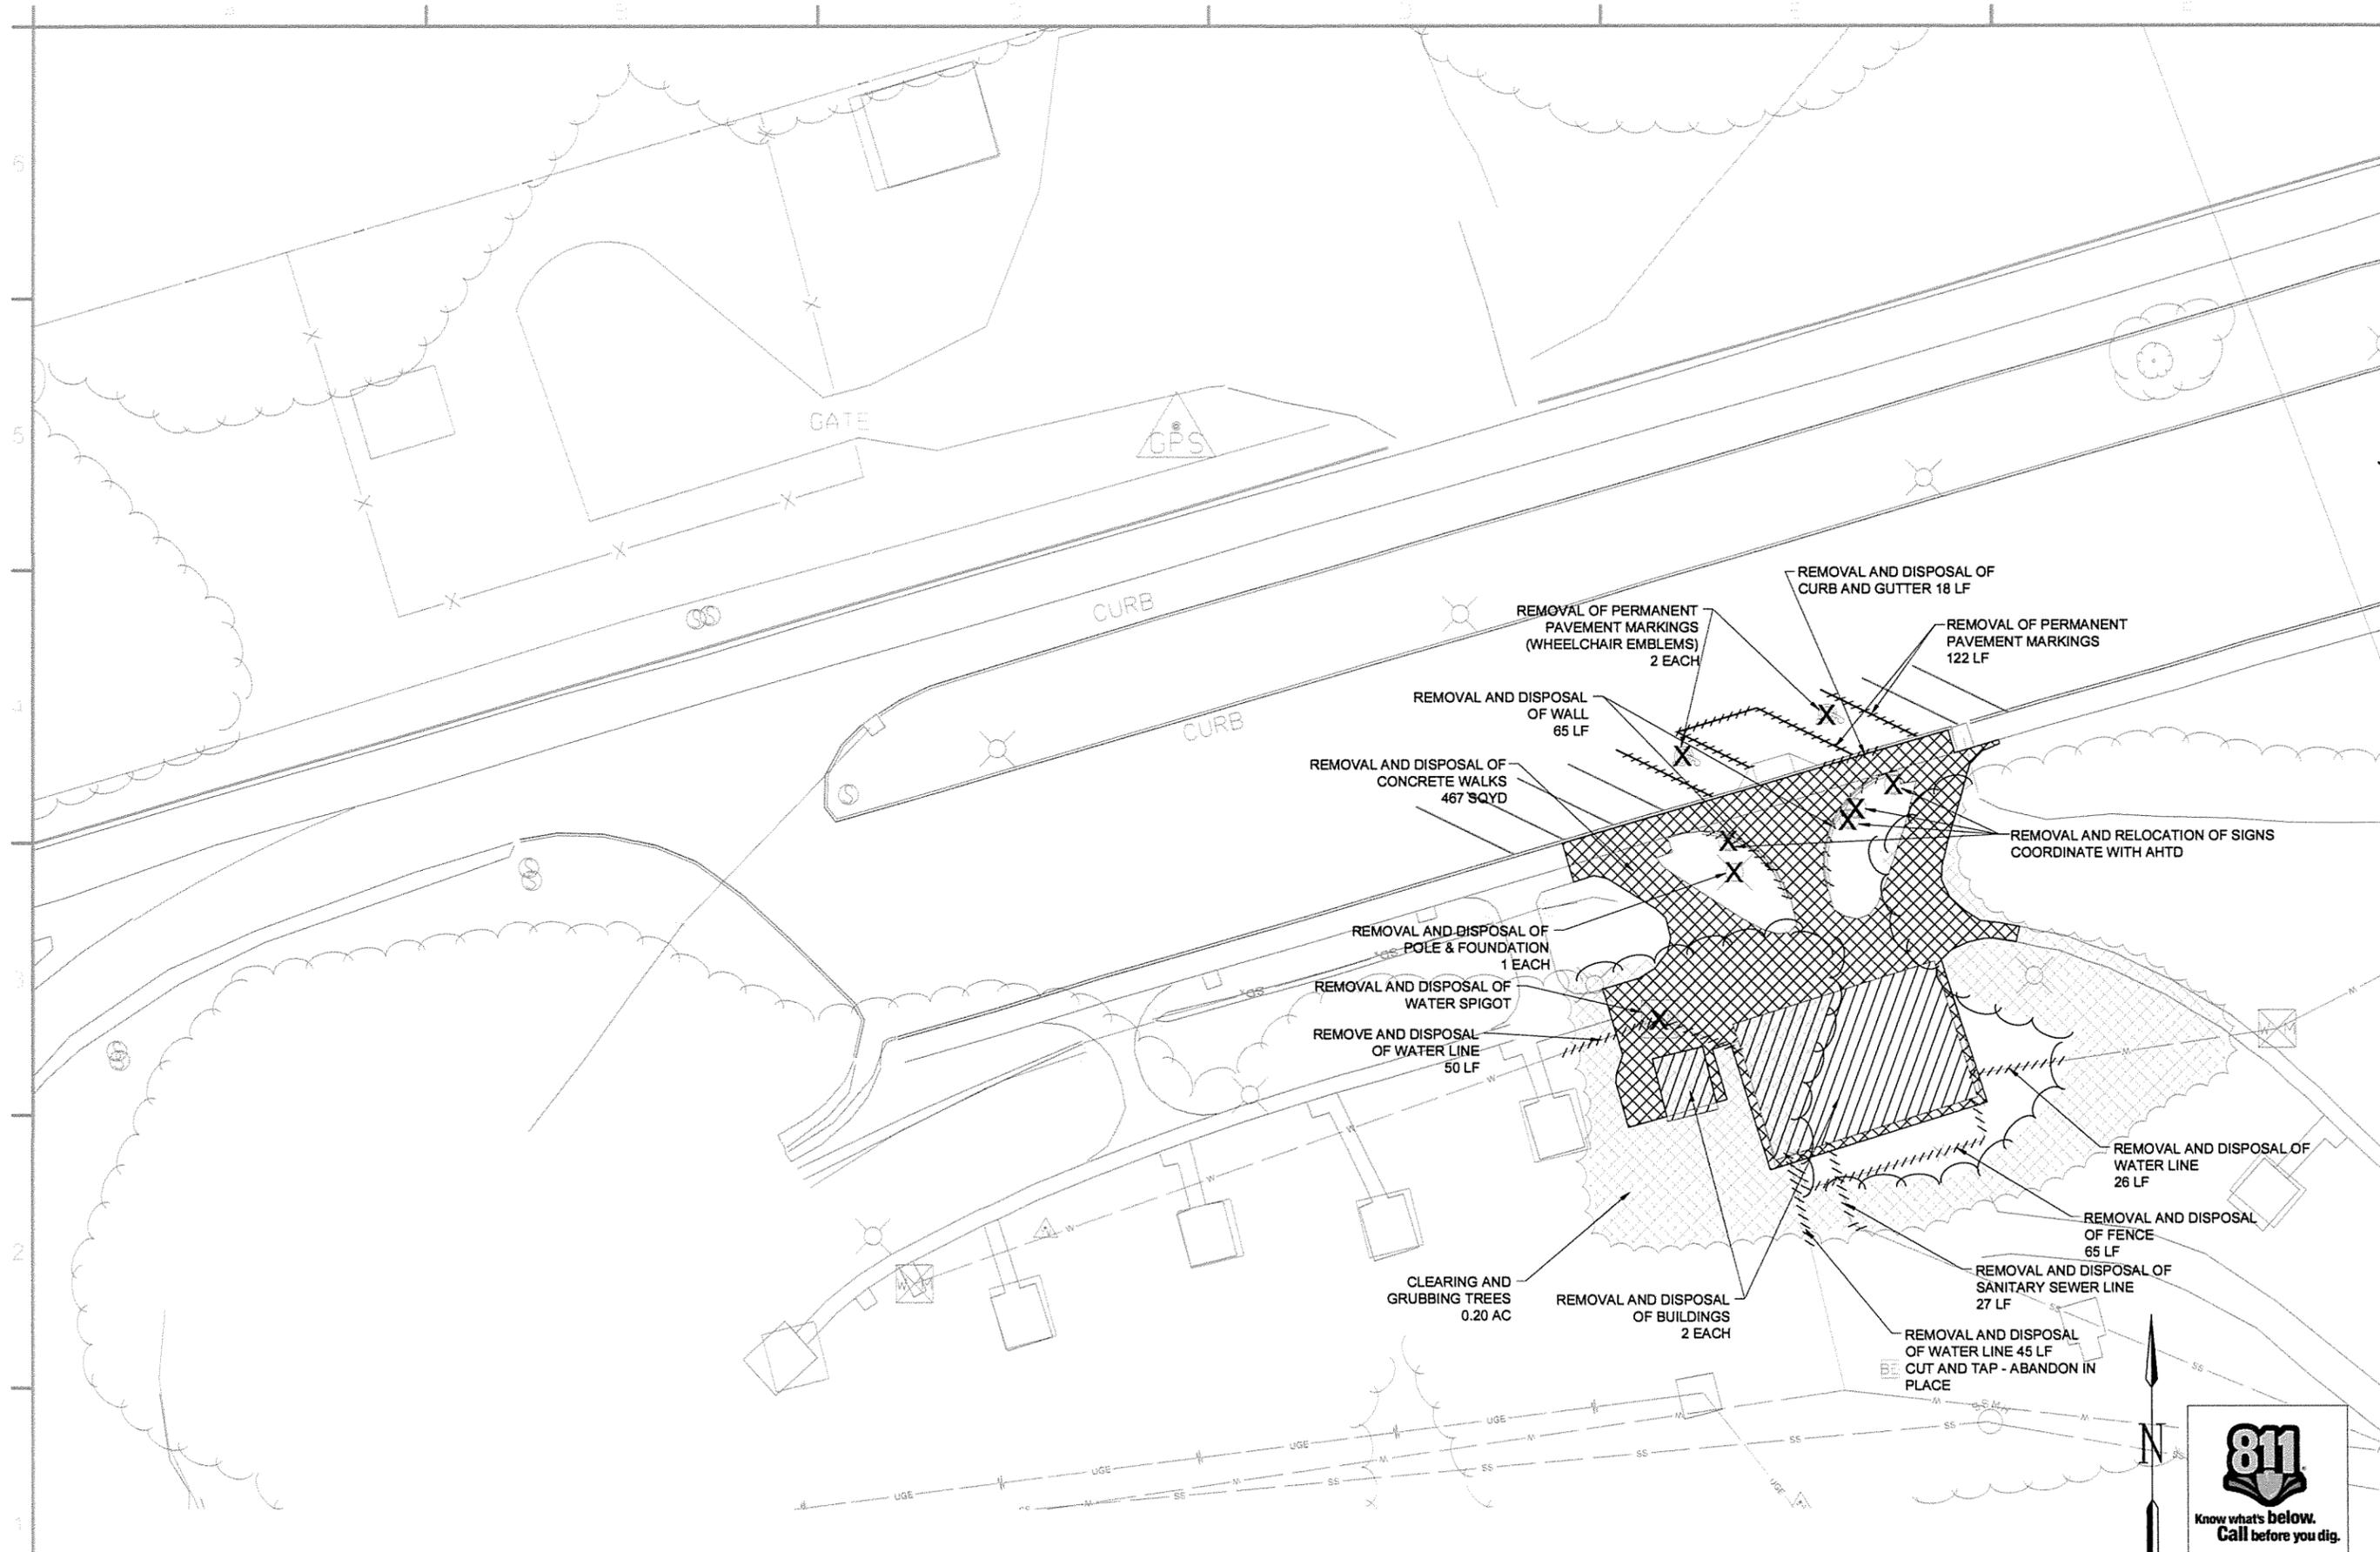

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 501-376-3633
 www.GarverUSA.com




STATE OF ARKANSAS
 LICENSED PROFESSIONAL ENGINEER
 No. 10432
THOMAS C. GRAHAM, II
 9/30/15

Job Number	Job Name	Issue Date	Revision	Description
000451	NA	10/1/15	1	ISSUED FOR CONSTRUCTION

Submitted by T. GRAHAM Director, Federal Services	Job Number 000451
Drawn by T. BARTON	Job Name NA
Checked by G. ARCHER	Job Date 9/30/15
File Name AHTSR-C-101.DWG	Plot Scale 1:1
	Dwg Code NA

ARKANSAS HIGHWAY AND TRANSPORTATION DEPARTMENT
 ARKANSAS TOURIST INFORMATION CENTER
 (WHITE RIVER) (S)
 JOB 061451

TOURIST INFORMATION CENTER
 AND MAINTENANCE BUILDING
 DEMOLITION PLAN (WESTBOUND)

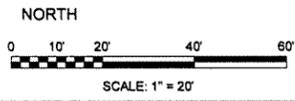

1
C-101

TOURIST INFORMATION CENTER DEMOLITION PLAN (WESTBOUND)


SCALE: 1" = 20'

Sheet Reference Number:

C-101

Sheet 9 of 130

MAINTENANCE BUILDING NODE LIST (WESTBOUND)			
POINT NUMBER	NORTHING	EASTING	DESCRIPTION
100	2102835.74	1471298.88	BLDG. COR.
101	2102845.36	1471330.79	BLDG. COR.
102	2102846.51	1471334.62	EDGE OF CONC.
103	2102840.45	1471336.45	EDGE OF CONC.
104	2102841.99	1471341.56	EDGE OF CONC.
105	2102828.58	1471345.60	EDGE OF CONC.

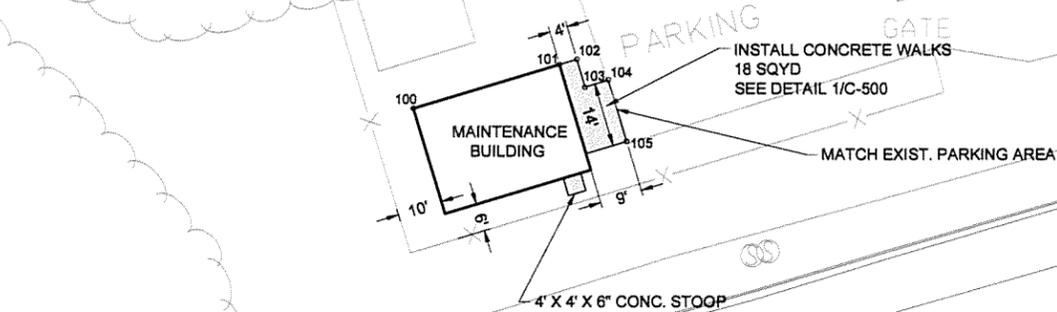

TOURIST INFORMATION CENTER NODE LIST (WESTBOUND)			
POINT NUMBER	NORTHING	EASTING	DESCRIPTION
110	2102716.61	1471691.67	BLDG. COR.
111	2102691.12	1471604.66	BLDG. COR.
112	2102747.42	1471590.34	EDGE OF CONC.
113	2102775.84	1471687.94	EDGE OF CONC.
114	2102770.15	1471689.51	EDGE OF CONC.
115	2102769.69	1471687.91	EDGE OF CONC.
116	2102764.90	1471689.32	RADIUS POINT
117	2102766.37	1471684.54	EDGE OF CONC.
118	2102747.83	1471678.84	EDGE OF CONC.
119	2102743.42	1471693.18	RADIUS POINT
120	2102728.59	1471690.94	EDGE OF CONC.
121	2102726.47	1471704.95	EDGE OF CONC.
122	2102722.57	1471704.09	EDGE OF CONC.
123	2102725.80	1471682.69	EDGE OF CONC.
124	2102701.08	1471678.96	RADIUS POINT
125	2102725.07	1471671.93	EDGE OF CONC.
126	2102720.49	1471656.32	EDGE OF CONC.
127	2102715.69	1471657.72	RADIUS POINT
128	2102714.29	1471652.92	EDGE OF CONC.
129	2102708.53	1471654.61	EDGE OF CONC.
130	2102704.31	1471640.22	EDGE OF CONC.
131	2102710.07	1471638.53	EDGE OF CONC.
132	2102708.67	1471633.73	RADIUS POINT
133	2102713.46	1471632.32	EDGE OF CONC.
134	2102707.13	1471610.71	EDGE OF CONC.
135	2102703.25	1471602.57	EDGE OF CONC.
136	2102710.81	1471600.33	EDGE OF CONC.
137	2102715.46	1471616.10	EDGE OF CONC.
138	2102720.25	1471614.68	RADIUS POINT
139	2102724.22	1471617.73	EDGE OF CONC.
140	2102736.08	1471602.32	EDGE OF CONC.
141	2102728.16	1471596.22	RADIUS POINT
142	2102737.69	1471593.19	EDGE OF CONC.

TOURIST INFORMATION CENTER NODE LIST (WESTBOUND)			
POINT NUMBER	NORTHING	EASTING	DESCRIPTION
143	2102742.99	1471614.66	RADIUS POINT
144	2102747.79	1471613.25	EDGE OF CONC.
145	2102750.31	1471621.88	EDGE OF CONC.
146	2102745.52	1471623.29	RADIUS POINT
147	2102746.90	1471628.10	EDGE OF CONC.
148	2102735.12	1471631.48	EDGE OF CONC.
149	2102733.74	1471626.67	RADIUS POINT
150	2102741.68	1471657.41	EDGE OF CONC.
151	2102754.47	1471653.74	EDGE OF CONC.
152	2102755.85	1471658.54	RADIUS POINT
153	2102760.64	1471657.14	EDGE OF CONC.
154	2102763.59	1471667.20	EDGE OF CONC.
155	2102758.79	1471668.61	RADIUS POINT
156	2102743.56	1471663.93	RADIUS POINT
157	2102738.77	1471665.33	EDGE OF CONC.
158	2102738.26	1471663.62	EDGE OF CONC.
159	2102743.06	1471662.21	RADIUS POINT
160	2102648.67	1471656.57	EDGE OF CONC.
161	2102662.81	1471704.85	EDGE OF CONC.
162	2102716.55	1471689.10	RADIUS POINT
163	2102682.07	1471733.22	EDGE OF CONC.
164	2102700.55	1471747.68	EDGE OF CONC.
165	2102697.48	1471751.61	RADIUS POINT
166	2102701.82	1471754.09	EDGE OF CONC.
167	2102710.03	1471740.40	EDGE OF CONC.
168	2102705.76	1471737.79	RADIUS POINT
169	2102658.56	1471668.99	EDGE OF CONC.
170	2102664.33	1471667.34	EDGE OF CONC.
171	2102660.20	1471653.26	EDGE OF CONC.
172	2102760.45	1471656.59	EDGE OF CONC.
173	2102765.56	1471673.85	EDGE OF CONC.

1 SITE PLAN (WESTBOUND)
SCALE: 1" = 20'



811
Know what's below.
Call before you dig.

SCALE: 1" = 20'


PARKING

PARKING

PAVED PARKING

PAVED PARKING

TOURIST INFORMATION CENTER (WESTBOUND)

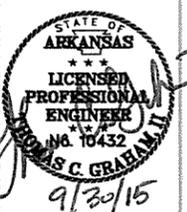


Date	Appr	Issued For Construction	Symbol
10/15			

Job Number	Scale	Plot Date	Draw Code
000451	N/A	9/30/15	11

ARKANSAS HIGHWAY AND TRANSPORTATION DEPARTMENT
 ARKANSAS TOURIST INFORMATION CENTER
 (WHITE RIVER) (S)
 JOB 001451

TOURIST INFORMATION CENTER AND MAINTENANCE BUILDING
 SITE PLAN (WESTBOUND)

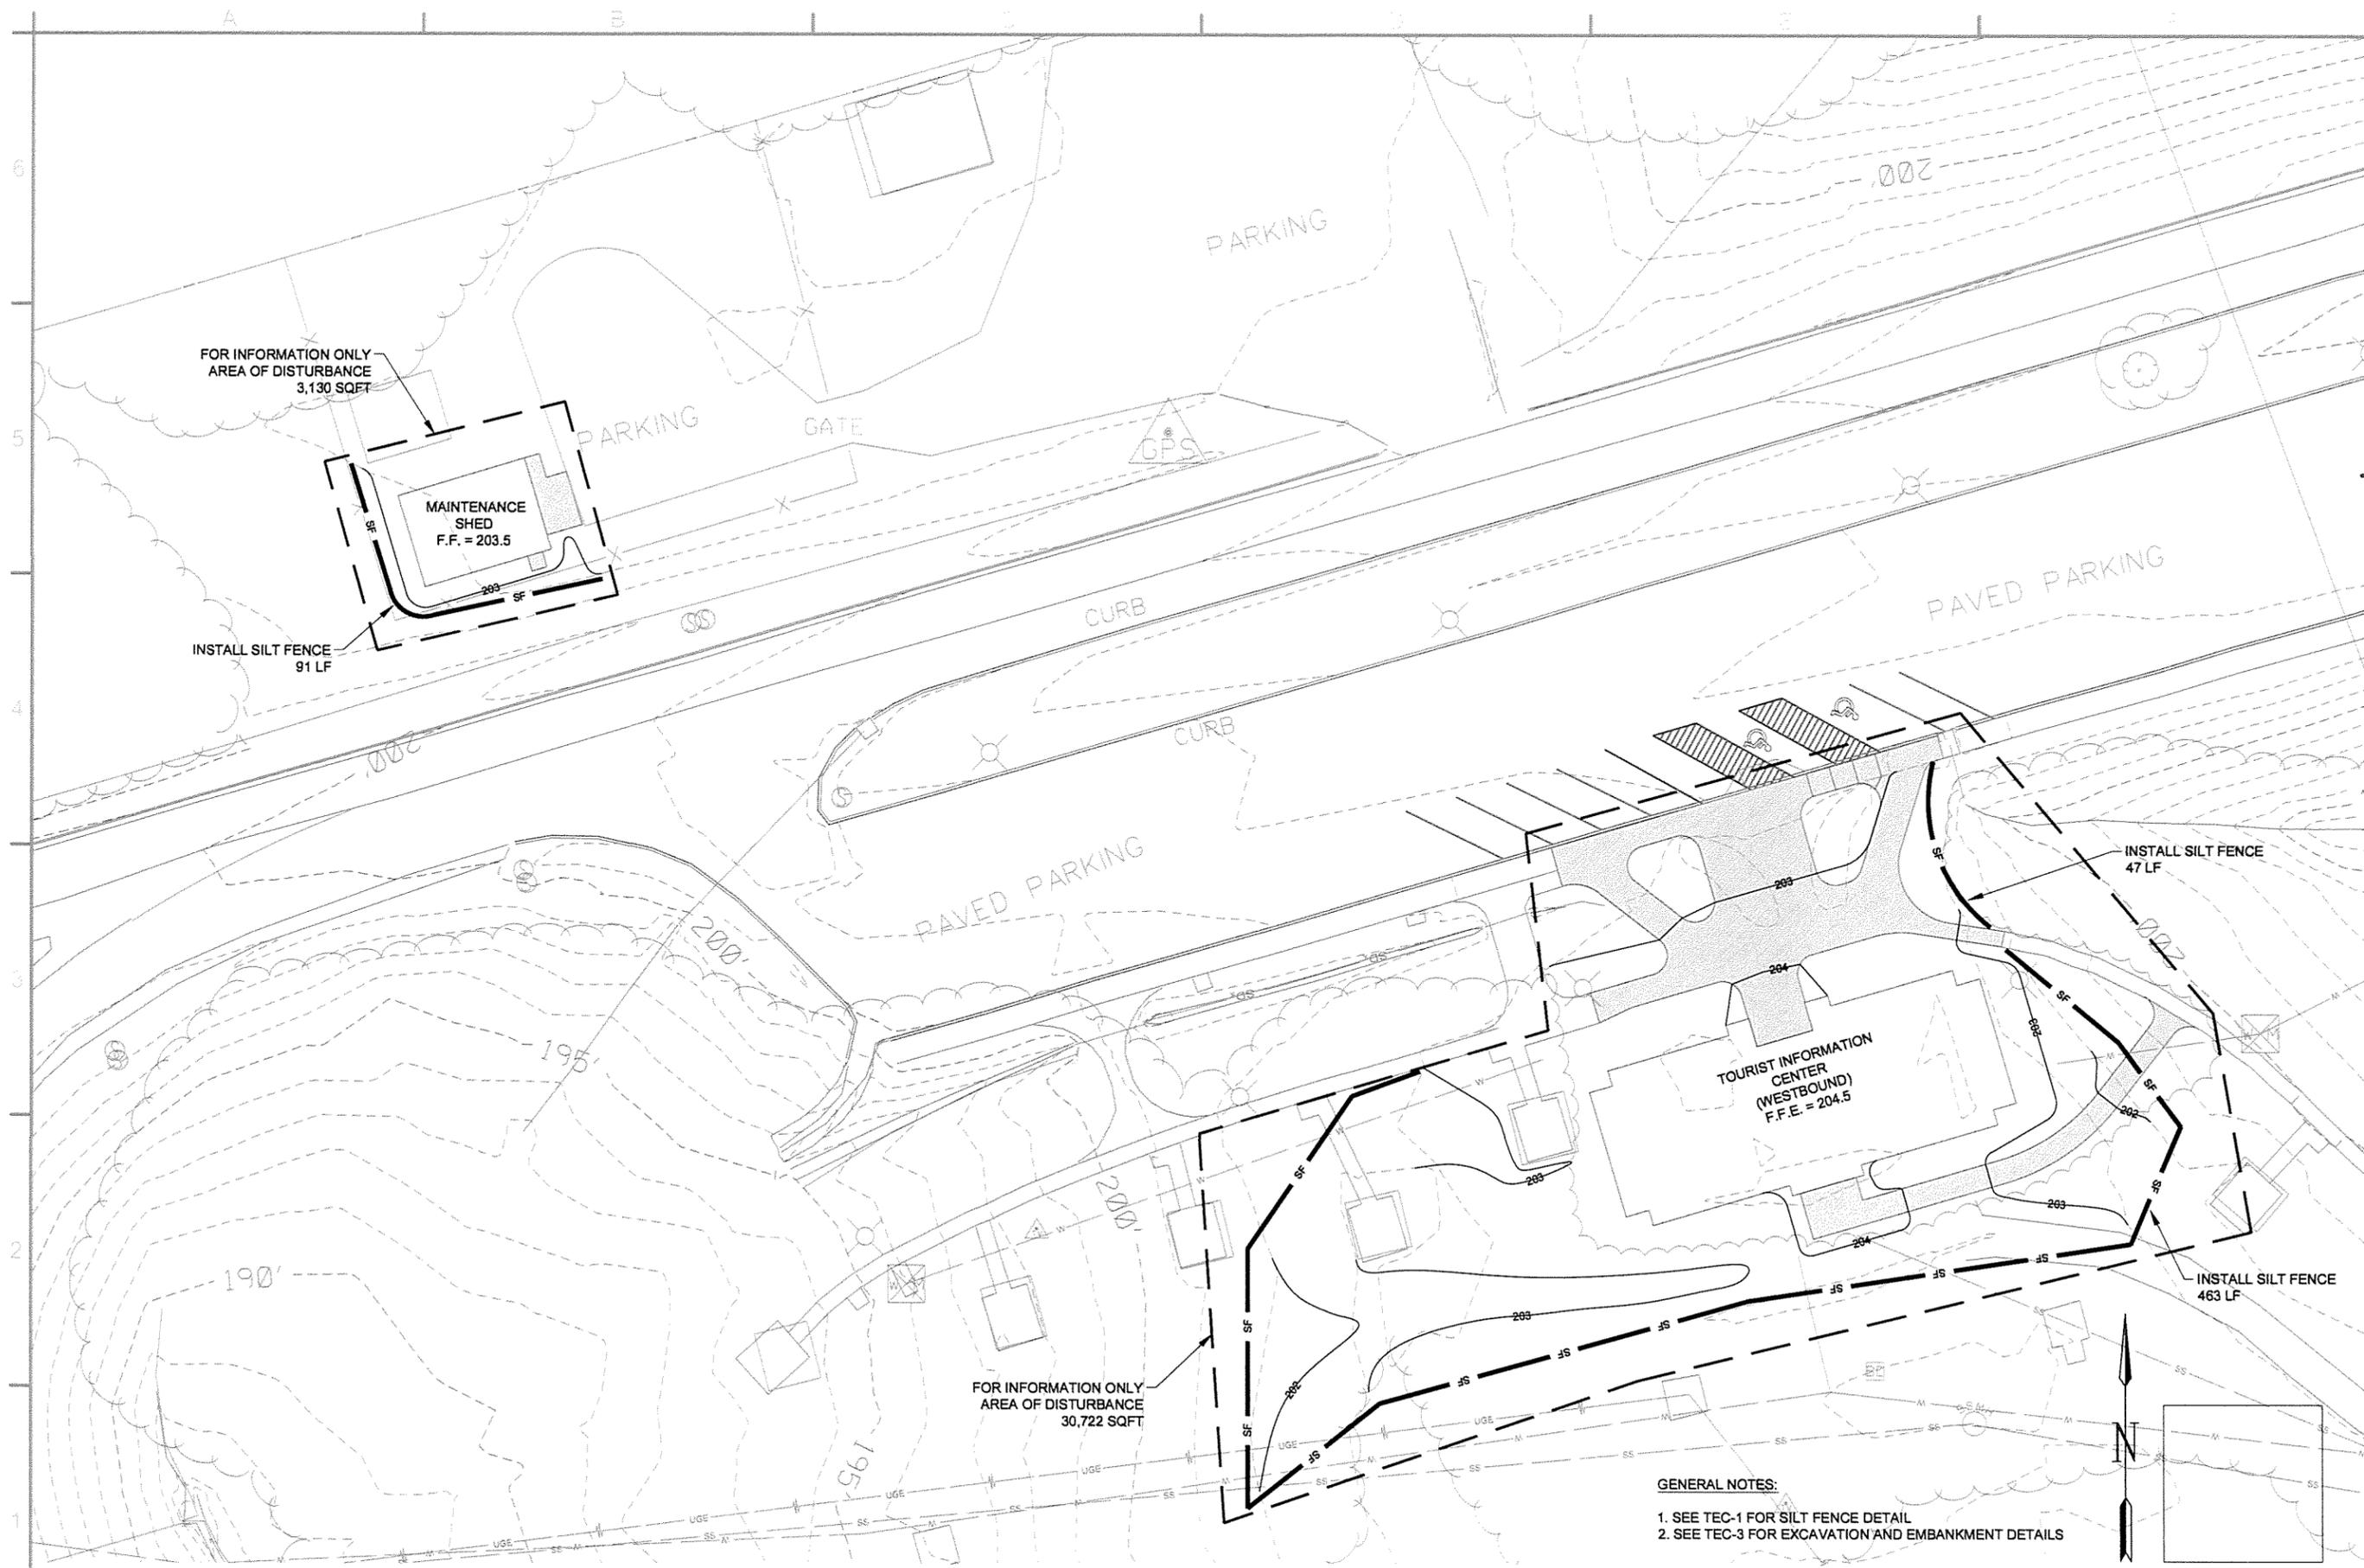

FOR INFORMATION ONLY
AREA OF DISTURBANCE
3,130 SQFT

MAINTENANCE
SHED
F.F. = 203.5

INSTALL SILT FENCE
91 LF

PARKING

PARKING

GATE

GPS

CURB

CURB

PAVED PARKING

PAVED PARKING


TOURIST INFORMATION
CENTER
(WESTBOUND)
F.F.E. = 204.5

INSTALL SILT FENCE
47 LF

INSTALL SILT FENCE
463 LF

FOR INFORMATION ONLY
AREA OF DISTURBANCE
30,722 SQFT

- GENERAL NOTES:**
1. SEE TEC-1 FOR SILT FENCE DETAIL
 2. SEE TEC-3 FOR EXCAVATION AND EMBANKMENT DETAILS

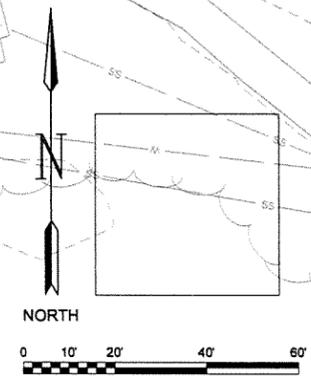

1 GRADING AND EROSION CONTROL PLAN (WESTBOUND)
SCALE: 1" = 20'






Symbol	Description	Date	Appr.
IFC	ISSUED FOR CONSTRUCTION	10/11/15	JRR

Job Number	060451	Submitted by	John T. Waldman, PE, SE Director, Federal Services	Job Scale	1:1
Drawn by	T. DARTON	Pol. Date	9/30/15	Drug Code	
Checked by	G. ARCHER	File Name	A110WR-C-103.DWG		

ARKANSAS HIGHWAY AND TRANSPORTATION DEPARTMENT
ARKANSAS TOURIST INFORMATION CENTER
(WHITE RIVER) (S)
JOB 061451

TOURIST INFORMATION CENTER AND
MAINTENANCE BUILDING GRADING AND
EROSION CONTROL PLAN (WESTBOUND)

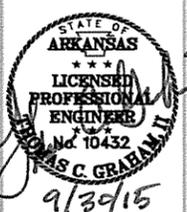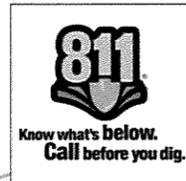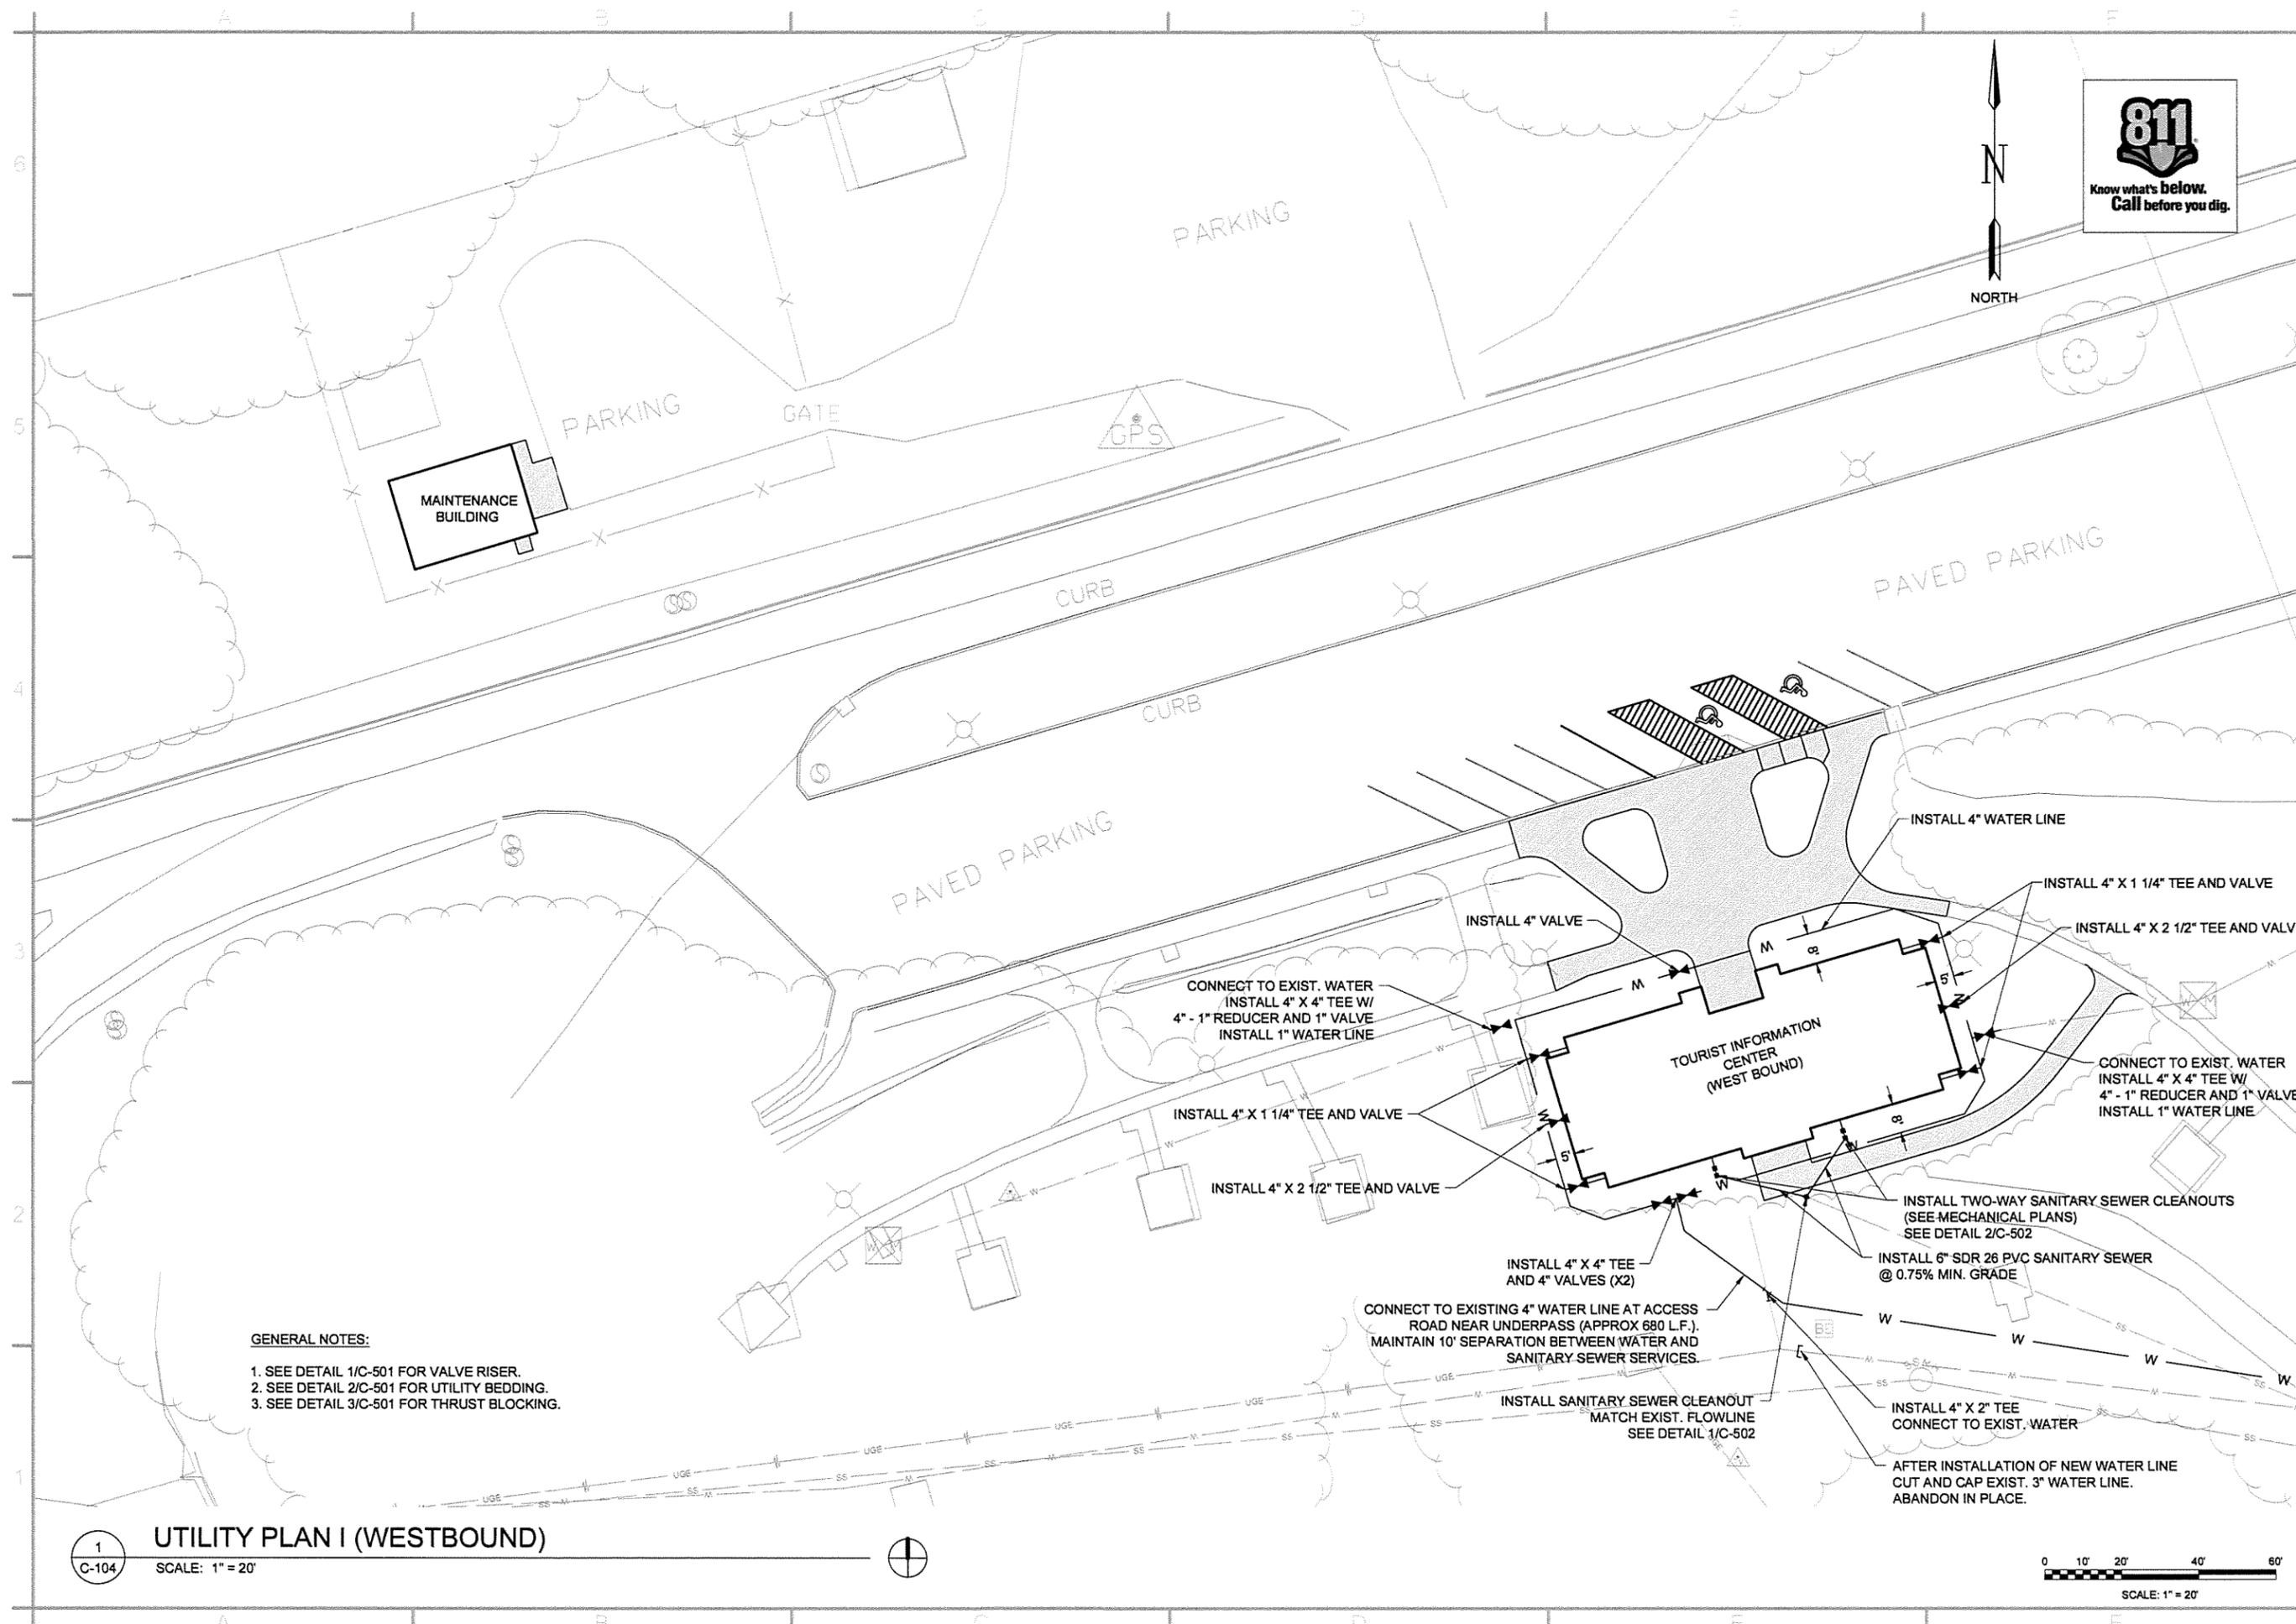

Date	By	Description
10/15	JRR	ISSUED FOR CONSTRUCTION


Submitted by	Job Number	000451
John T. Walden, P.E., SE Director, Facility Services	NA	NA
Drawn by	Plot Scale	1:1
T. G. GRAHAM	Plot Date	9/30/15
Checked by	Draw Code	NA
G. ARCHER	File Name	AR150915-C-104.DWG


ARKANSAS HIGHWAY AND TRANSPORTATION DEPARTMENT
 ARKANSAS TOURIST INFORMATION CENTER
 (WHITE RIVER) (S)
 JOB 061451

TOURIST INFORMATION CENTER
 AND MAINTENANCE BUILDING
 UTILITY PLAN I (WESTBOUND)


- GENERAL NOTES:**
1. SEE DETAIL 1/C-501 FOR VALVE RISER.
 2. SEE DETAIL 2/C-501 FOR UTILITY BEDDING.
 3. SEE DETAIL 3/C-501 FOR THRUST BLOCKING.

1
 C-104 **UTILITY PLAN I (WESTBOUND)**
 SCALE: 1" = 20'

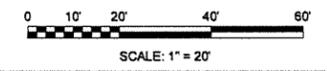

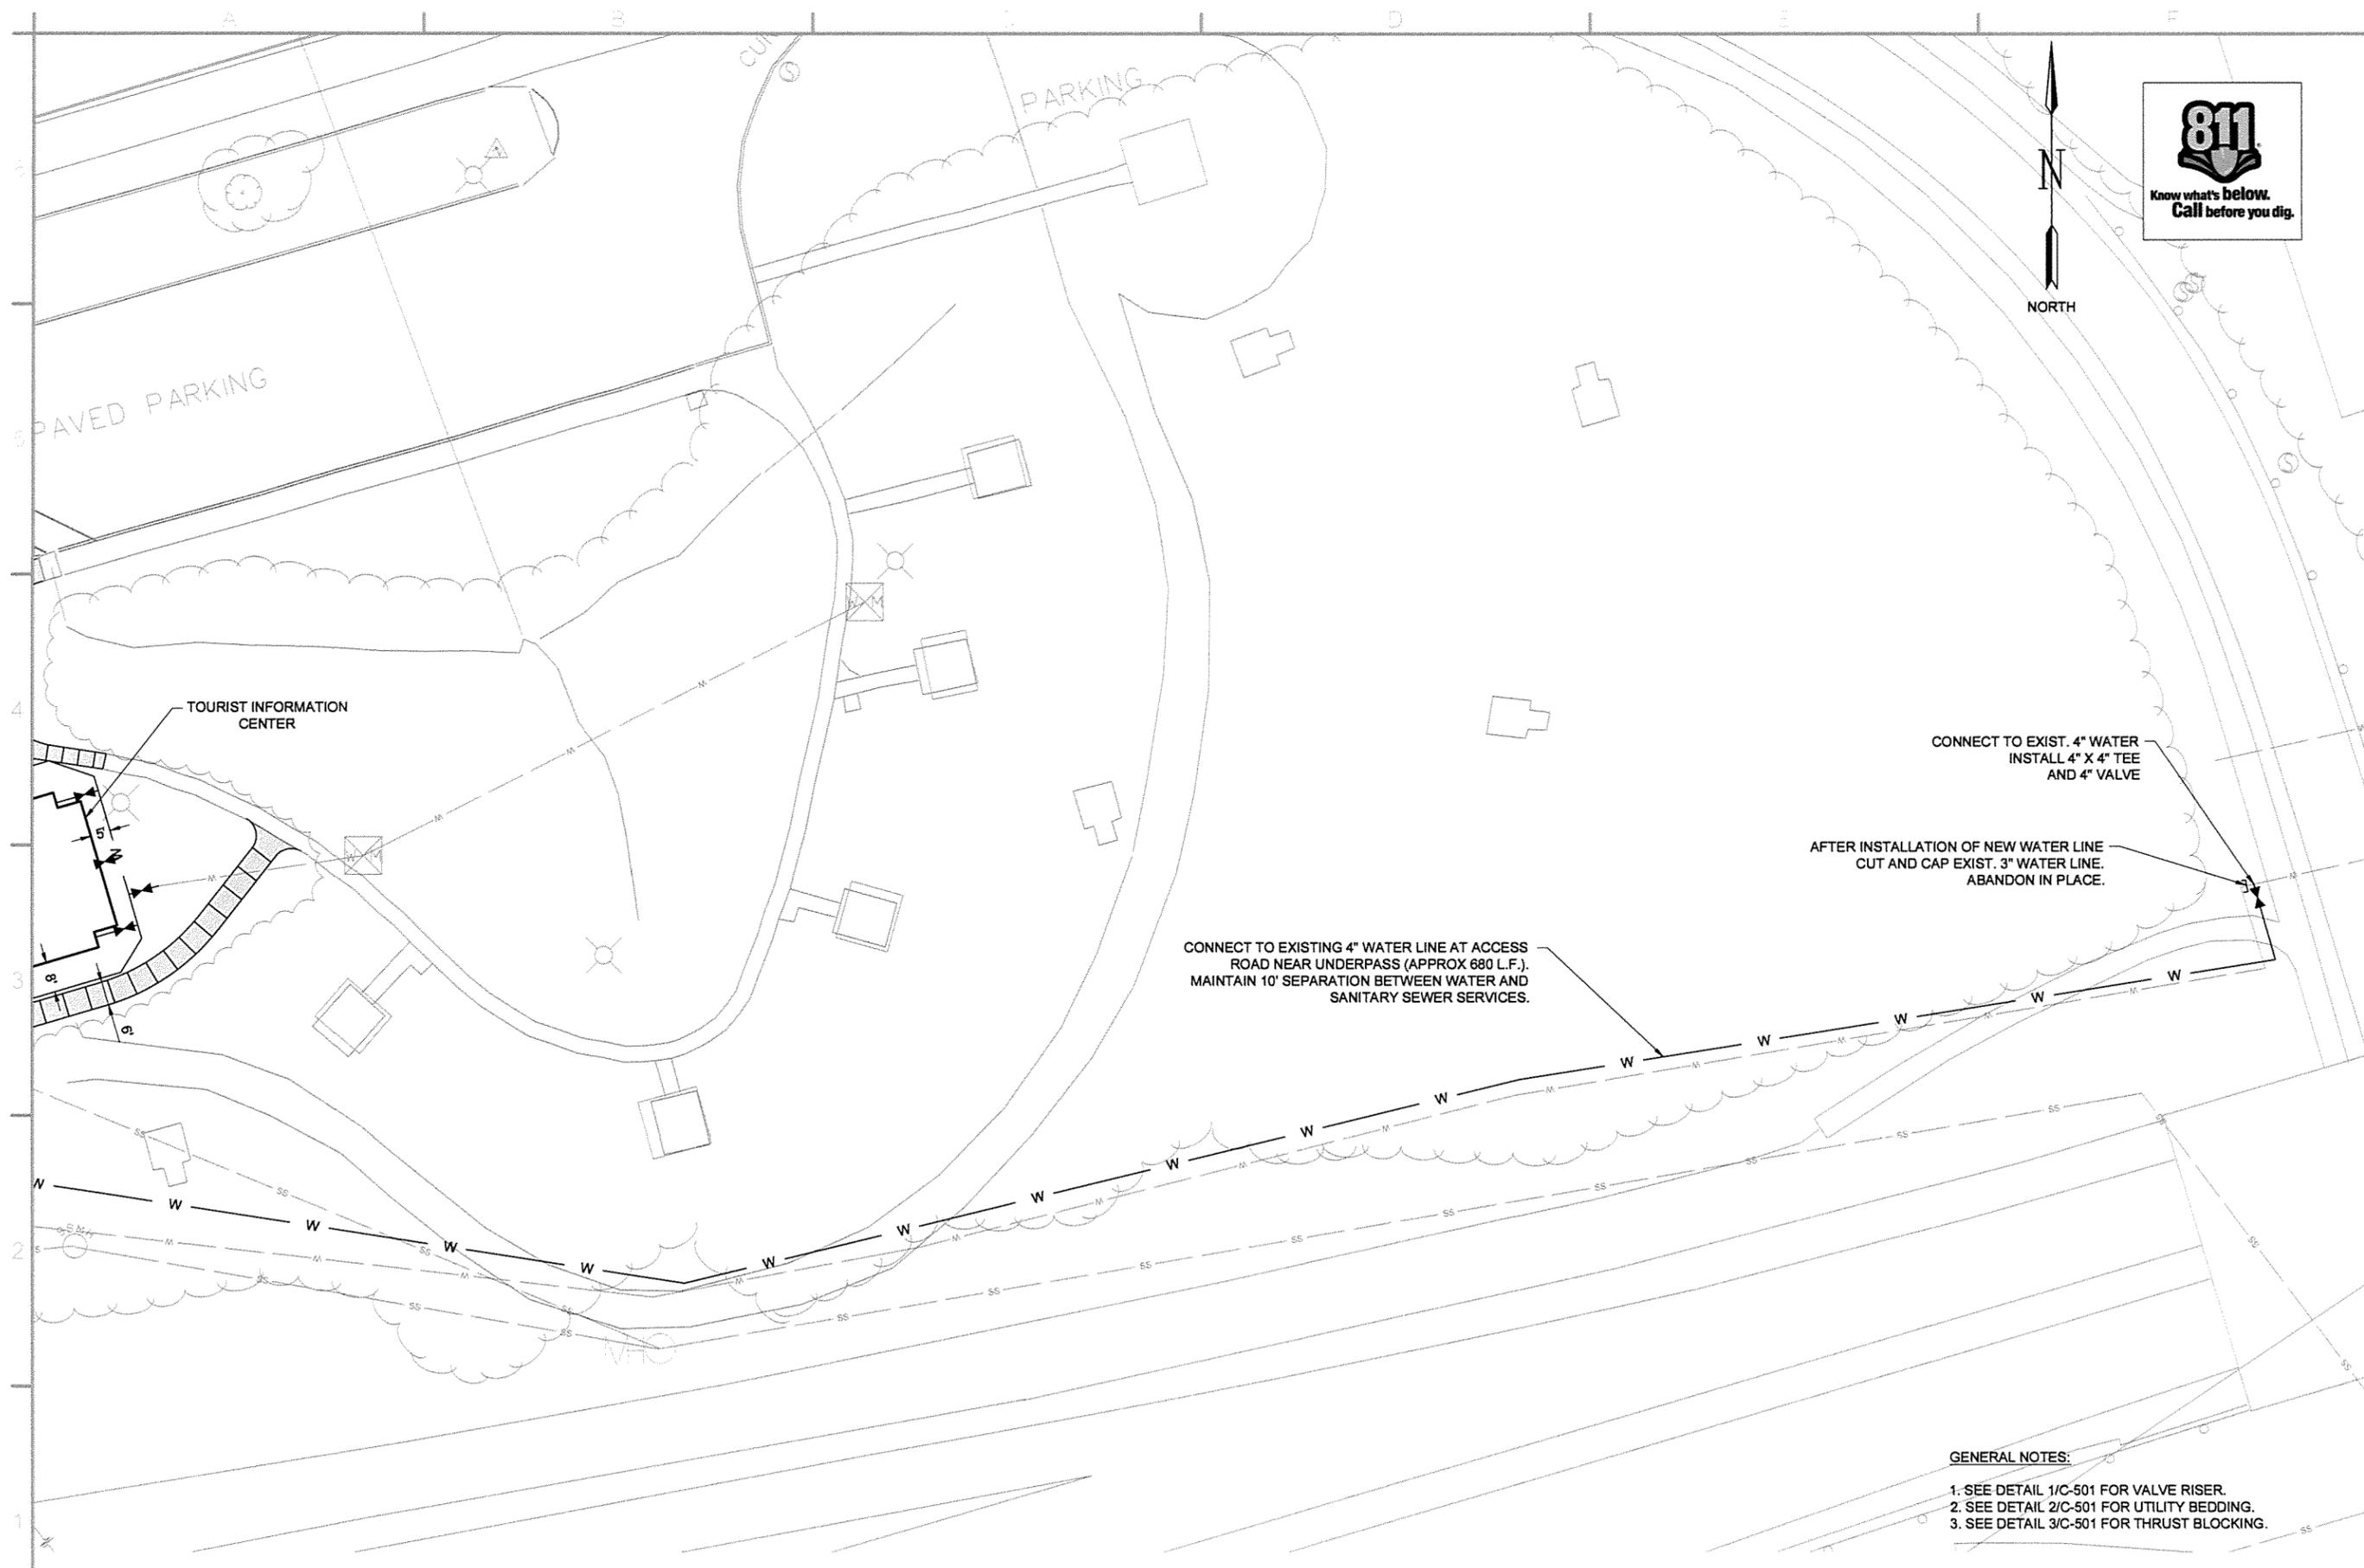

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www.GarverUSA.com

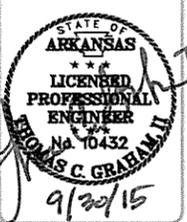

IFC Symbol	Description	Date	Appr.
	ISSUED FOR CONSTRUCTION	10/11/15	JRR


Job Number	000451		
Submitted by	SE, SE	Plot Scale:	1:1
Job Director	J. FRANSEY	Plot Date:	9/20/15
Drawn by	J. DEWANE	Dwg Code	
Checked by	G. ARCHER	File Name	AH15RR-C-105.DWG

ARKANSAS HIGHWAY AND TRANSPORTATION DEPARTMENT
ARKANSAS TOURIST INFORMATION CENTER
(WHITE RIVER) (S)
JOB 061451

TOURIST INFORMATION CENTER
AND MAINTENANCE BUILDING
UTILITY PLAN II (WESTBOUND)


- GENERAL NOTES:**
- SEE DETAIL 1/C-501 FOR VALVE RISER.
 - SEE DETAIL 2/C-501 FOR UTILITY BEDDING.
 - SEE DETAIL 3/C-501 FOR THRUST BLOCKING.

1
C-105
SCALE: 1" = 20'

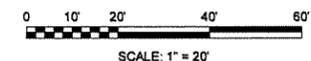

Sheet Reference Number:
C-105
Sheet 13 of 130

TOURIST INFORMATION CENTER NODE LIST (EAST BOUND)			
POINT NUMBER	NORTHING	EASTING	DESCRIPTION
200	2102074.24	1471831.81	BLEG. COR.
201	2102094.63	1471920.16	BLEG. COR.
202	2102094.54	1471881.21	EDGE OF CONC.
203	2102088.69	1471882.56	EDGE OF CONC.
204	2102085.38	1471868.21	EDGE OF CONC.
205	2102097.07	1471865.51	EDGE OF CONC.
206	2102107.84	1471912.15	EDGE OF CONC.
207	2102082.50	1471918.00	RADIUS POINT
208	2102088.35	1471943.33	EDGE OF CONC.
209	2102080.89	1471945.05	EDGE OF CONC.
210	2102084.04	1471958.69	RADIUS POINT
211	2102073.86	1471949.08	EDGE OF CONC.
212	2102066.48	1471956.89	EDGE OF CONC.
213	2102070.12	1471960.33	RADIUS POINT
214	2102066.73	1471964.00	EDGE OF CONC.
215	2102052.99	1471978.54	RADIUS POINT
216	2102072.91	1471976.71	EDGE OF CONC.
217	2102073.30	1471980.95	EDGE OF CONC.
218	2102069.32	1471981.31	EDGE OF CONC.
219	2102064.53	1471970.18	EDGE OF CONC.
220	2102051.24	1471957.63	EDGE OF CONC.
221	2102068.73	1471938.39	RADIUS POINT
222	2102043.40	1471944.24	EDGE OF CONC.
223	2102038.39	1471922.53	EDGE OF CONC.
224	2102030.60	1471924.33	EDGE OF CONC.
225	2102032.98	1471934.66	EDGE OF CONC.
226	2102012.52	1471939.38	RADIUS POINT
227	2102025.55	1471955.85	EDGE OF CONC.
228	2102016.71	1471962.84	EDGE OF CONC.
229	2102026.02	1471974.61	RADIUS POINT
230	2102011.36	1471977.77	EDGE OF CONC.
231	2102011.75	1471979.74	EDGE OF CONC.
232	2102005.89	1471981.00	EDGE OF CONC.
233	2101961.08	1471769.26	EDGE OF CONC.
234	2101966.95	1471768.01	EDGE OF CONC.
235	2101968.28	1471774.25	EDGE OF CONC.
236	2101987.84	1471770.07	RADIUS POINT
237	2101977.08	1471786.93	EDGE OF CONC.
238	2102025.62	1471817.91	EDGE OF CONC.
239	2102031.00	1471809.48	RADIUS POINT
240	2102041.00	1471809.74	EDGE OF CONC.
241	2102045.00	1471809.77	EDGE OF CONC.
242	2102035.10	1471822.87	EDGE OF CONC.
243	2102031.98	1471823.59	EDGE OF CONC.
244	2102034.23	1471833.33	RADIUS POINT
245	2102024.48	1471835.58	EDGE OF CONC.
246	2102033.59	1471875.06	EDGE OF CONC.
247	2102038.47	1471873.94	RADIUS POINT
248	2102040.57	1471878.58	EDGE OF CONC.
249	2102043.86	1471892.87	EDGE OF CONC.
250	2102044.01	1471897.97	READIUS POINT
251	2102039.14	1471899.10	EDGE OF CONC.
252	2102055.38	1471953.26	EDGE OF CONC.
253	2102058.48	1471949.34	RADIUS POINT
254	2102062.12	1471952.77	EDGE OF CONC.
255	2101990.38	1471834.57	RADIUS POINT
256	2102014.74	1471828.94	EDGE OF CONC.
257	2102018.45	1471845.03	EDGE OF CONC.
258	2102008.71	1471847.28	RADIUS POINT
259	2102010.96	1471857.02	EDGE OF CONC.
260	2102009.01	1471857.47	EDGE OF CONC.
261	2102014.11	1471879.56	EDGE OF CONC.
262	2102009.23	1471880.68	RADIUS POINT
263	2102010.36	1471885.55	EDGE OF CONC.
264	2101997.20	1471888.59	EDGE OF CONC.
265	2101996.08	1471883.72	RADIUS POINT
266	2101991.16	1471884.63	EDGE OF CONC.
269	2101974.30	1471804.67	EDGE OF CONC.
270	2101979.21	1471803.71	RADIUS POINT
271	2102014.78	1471904.72	RADIUS POINT
272	2102019.65	1471903.59	EDGE OF CONC.
273	2102027.13	1471936.01	EDGE OF CONC.
274	2102011.24	1471953.14	RADIUS POINT
275	2102006.35	1471954.18	EDGE OF CONC.
280	2101996.31	1471908.99	EDGE OF CONC.
281	2102001.18	1471907.86	RADIUS POINT
282	2102053.30	1471915.10	SIDEWALK DRAIN
283	2102049.15	1471955.48	SIDEWALK DRAIN
284	2102004.51	1471886.90	CONC. STEPS
285	2101999.64	1471888.03	CONC. STEPS
295	2101975.02	1471808.35	EDGE OF RAMP
296	2101978.72	1471825.84	EDGE OF RAMP

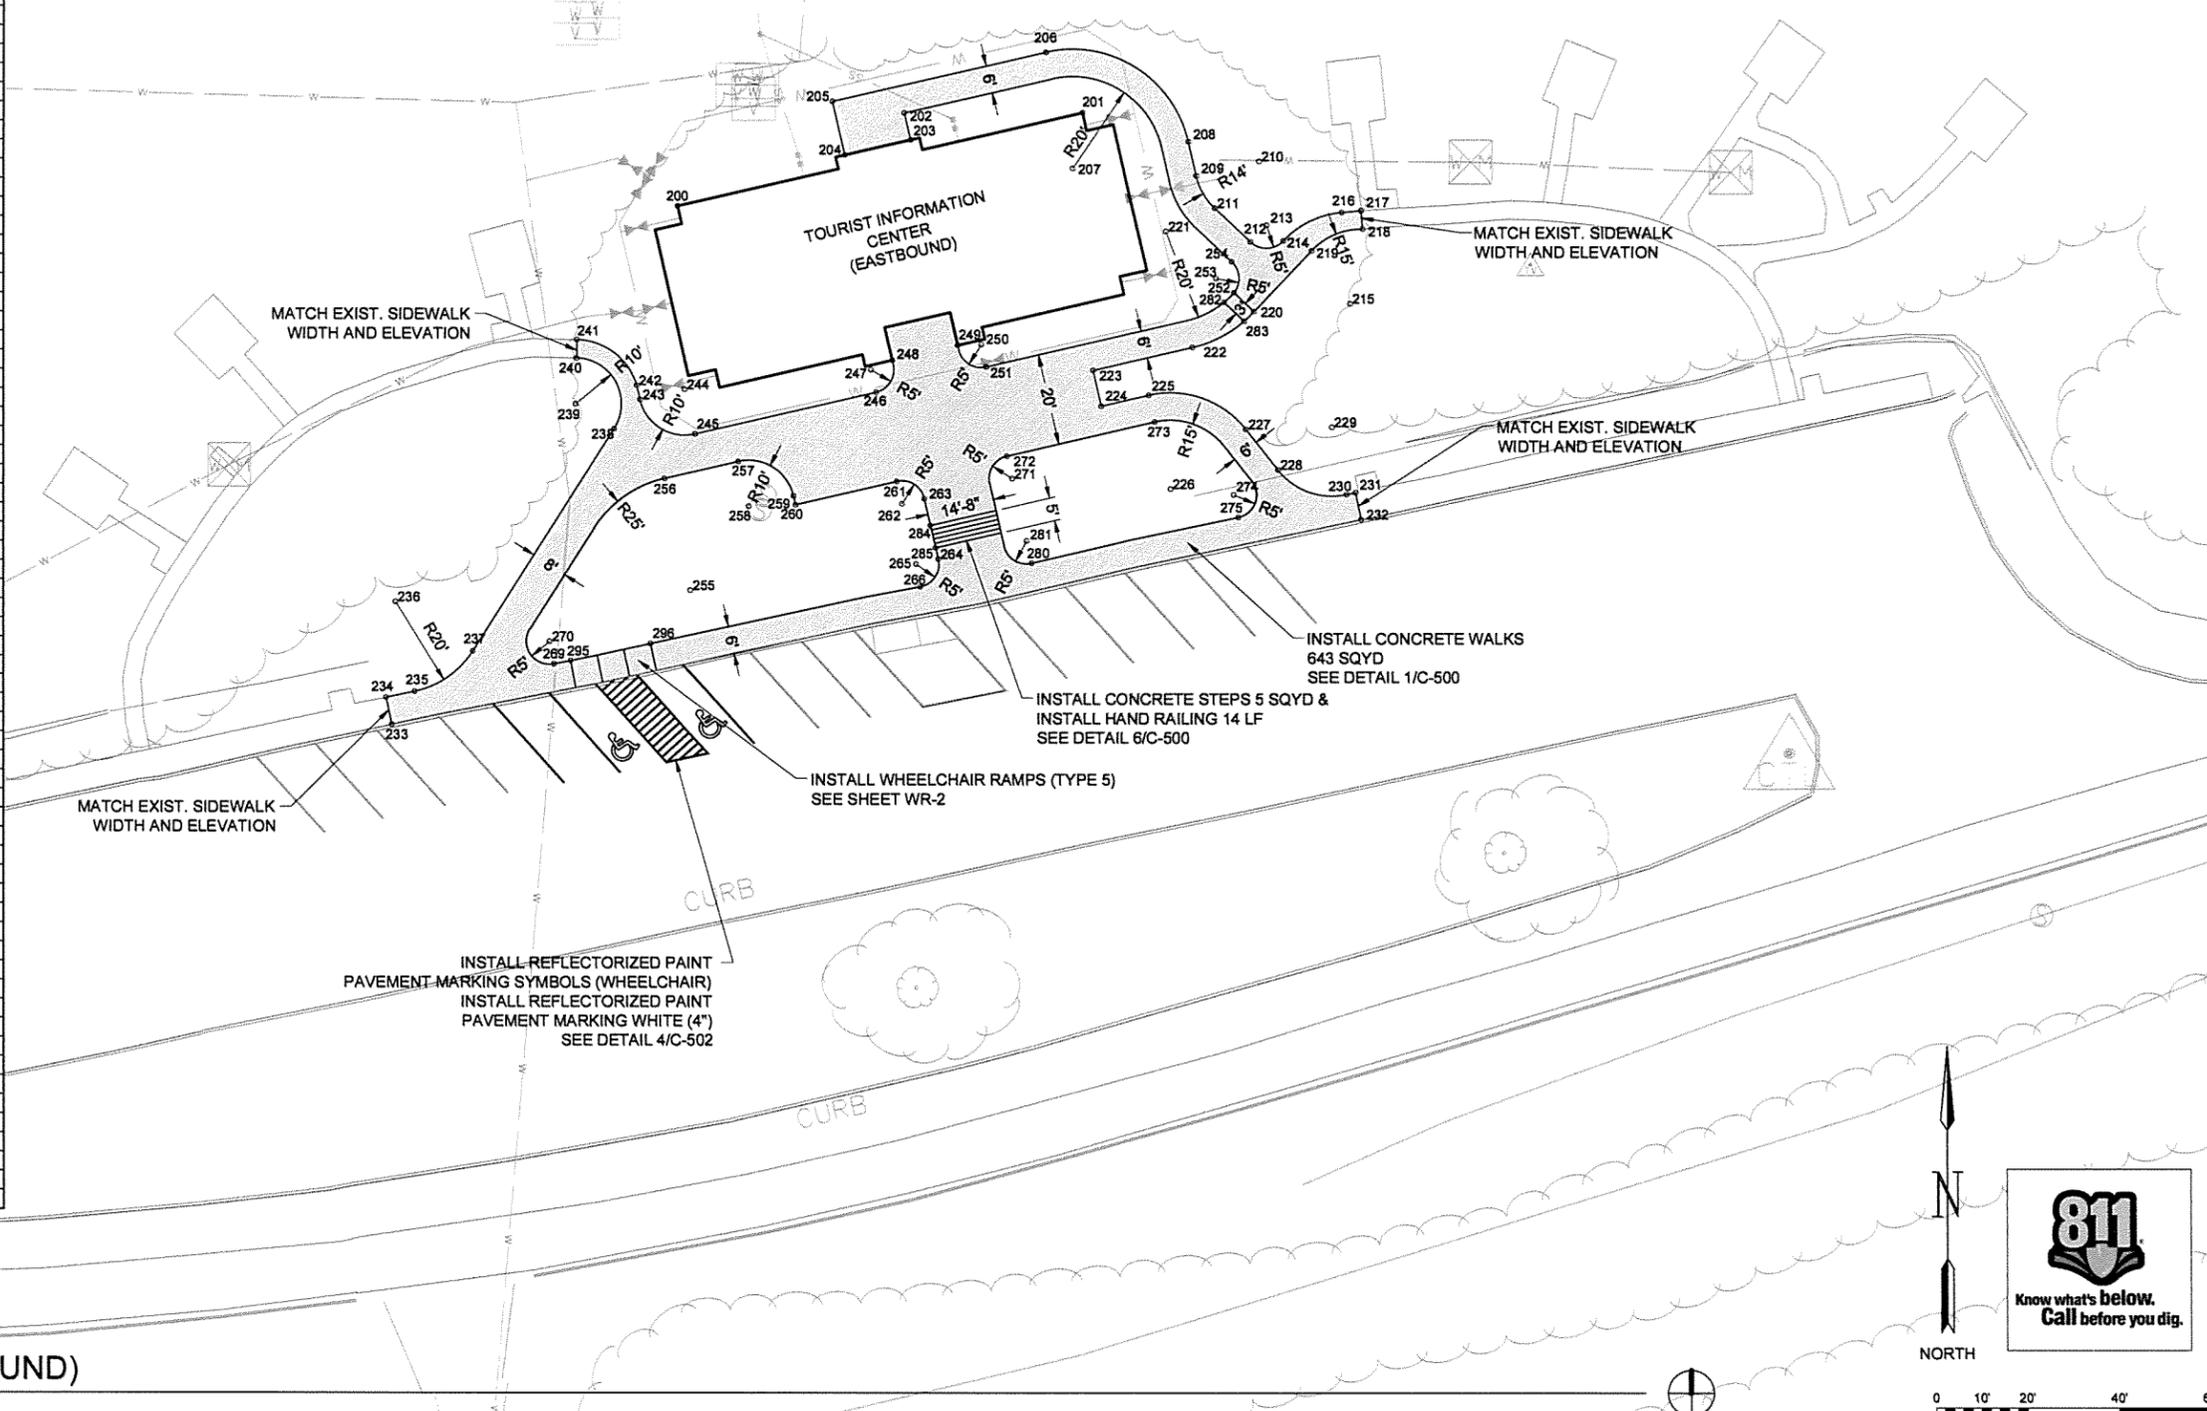

SITE PLAN (EASTBOUND)

SCALE: 1" = 20'

SCALE: 1" = 20'



Job Number	Date	Appr
000451	10/1/15	
NA		
NA		
NA		

Submitted by	Job Title	Scale	Plot Date	Plot Scale	Draw Code	Draw Date	Draw Code
T. GRAHAM	Director, Federal Services	1:1	9/30/15	1:1			
T. DARTON							
G. ARCHER							


ARKANSAS HIGHWAY AND TRANSPORTATION DEPARTMENT
 ARKANSAS TOURIST INFORMATION CENTER
 (WHITE RIVER) (S)
 JOB 061451
TOURIST INFORMATION CENTER
 SITE PLAN (EASTBOUND)

Sheet Reference Number:
C-112
 Sheet 15 of 130




NORTH


1
C-112

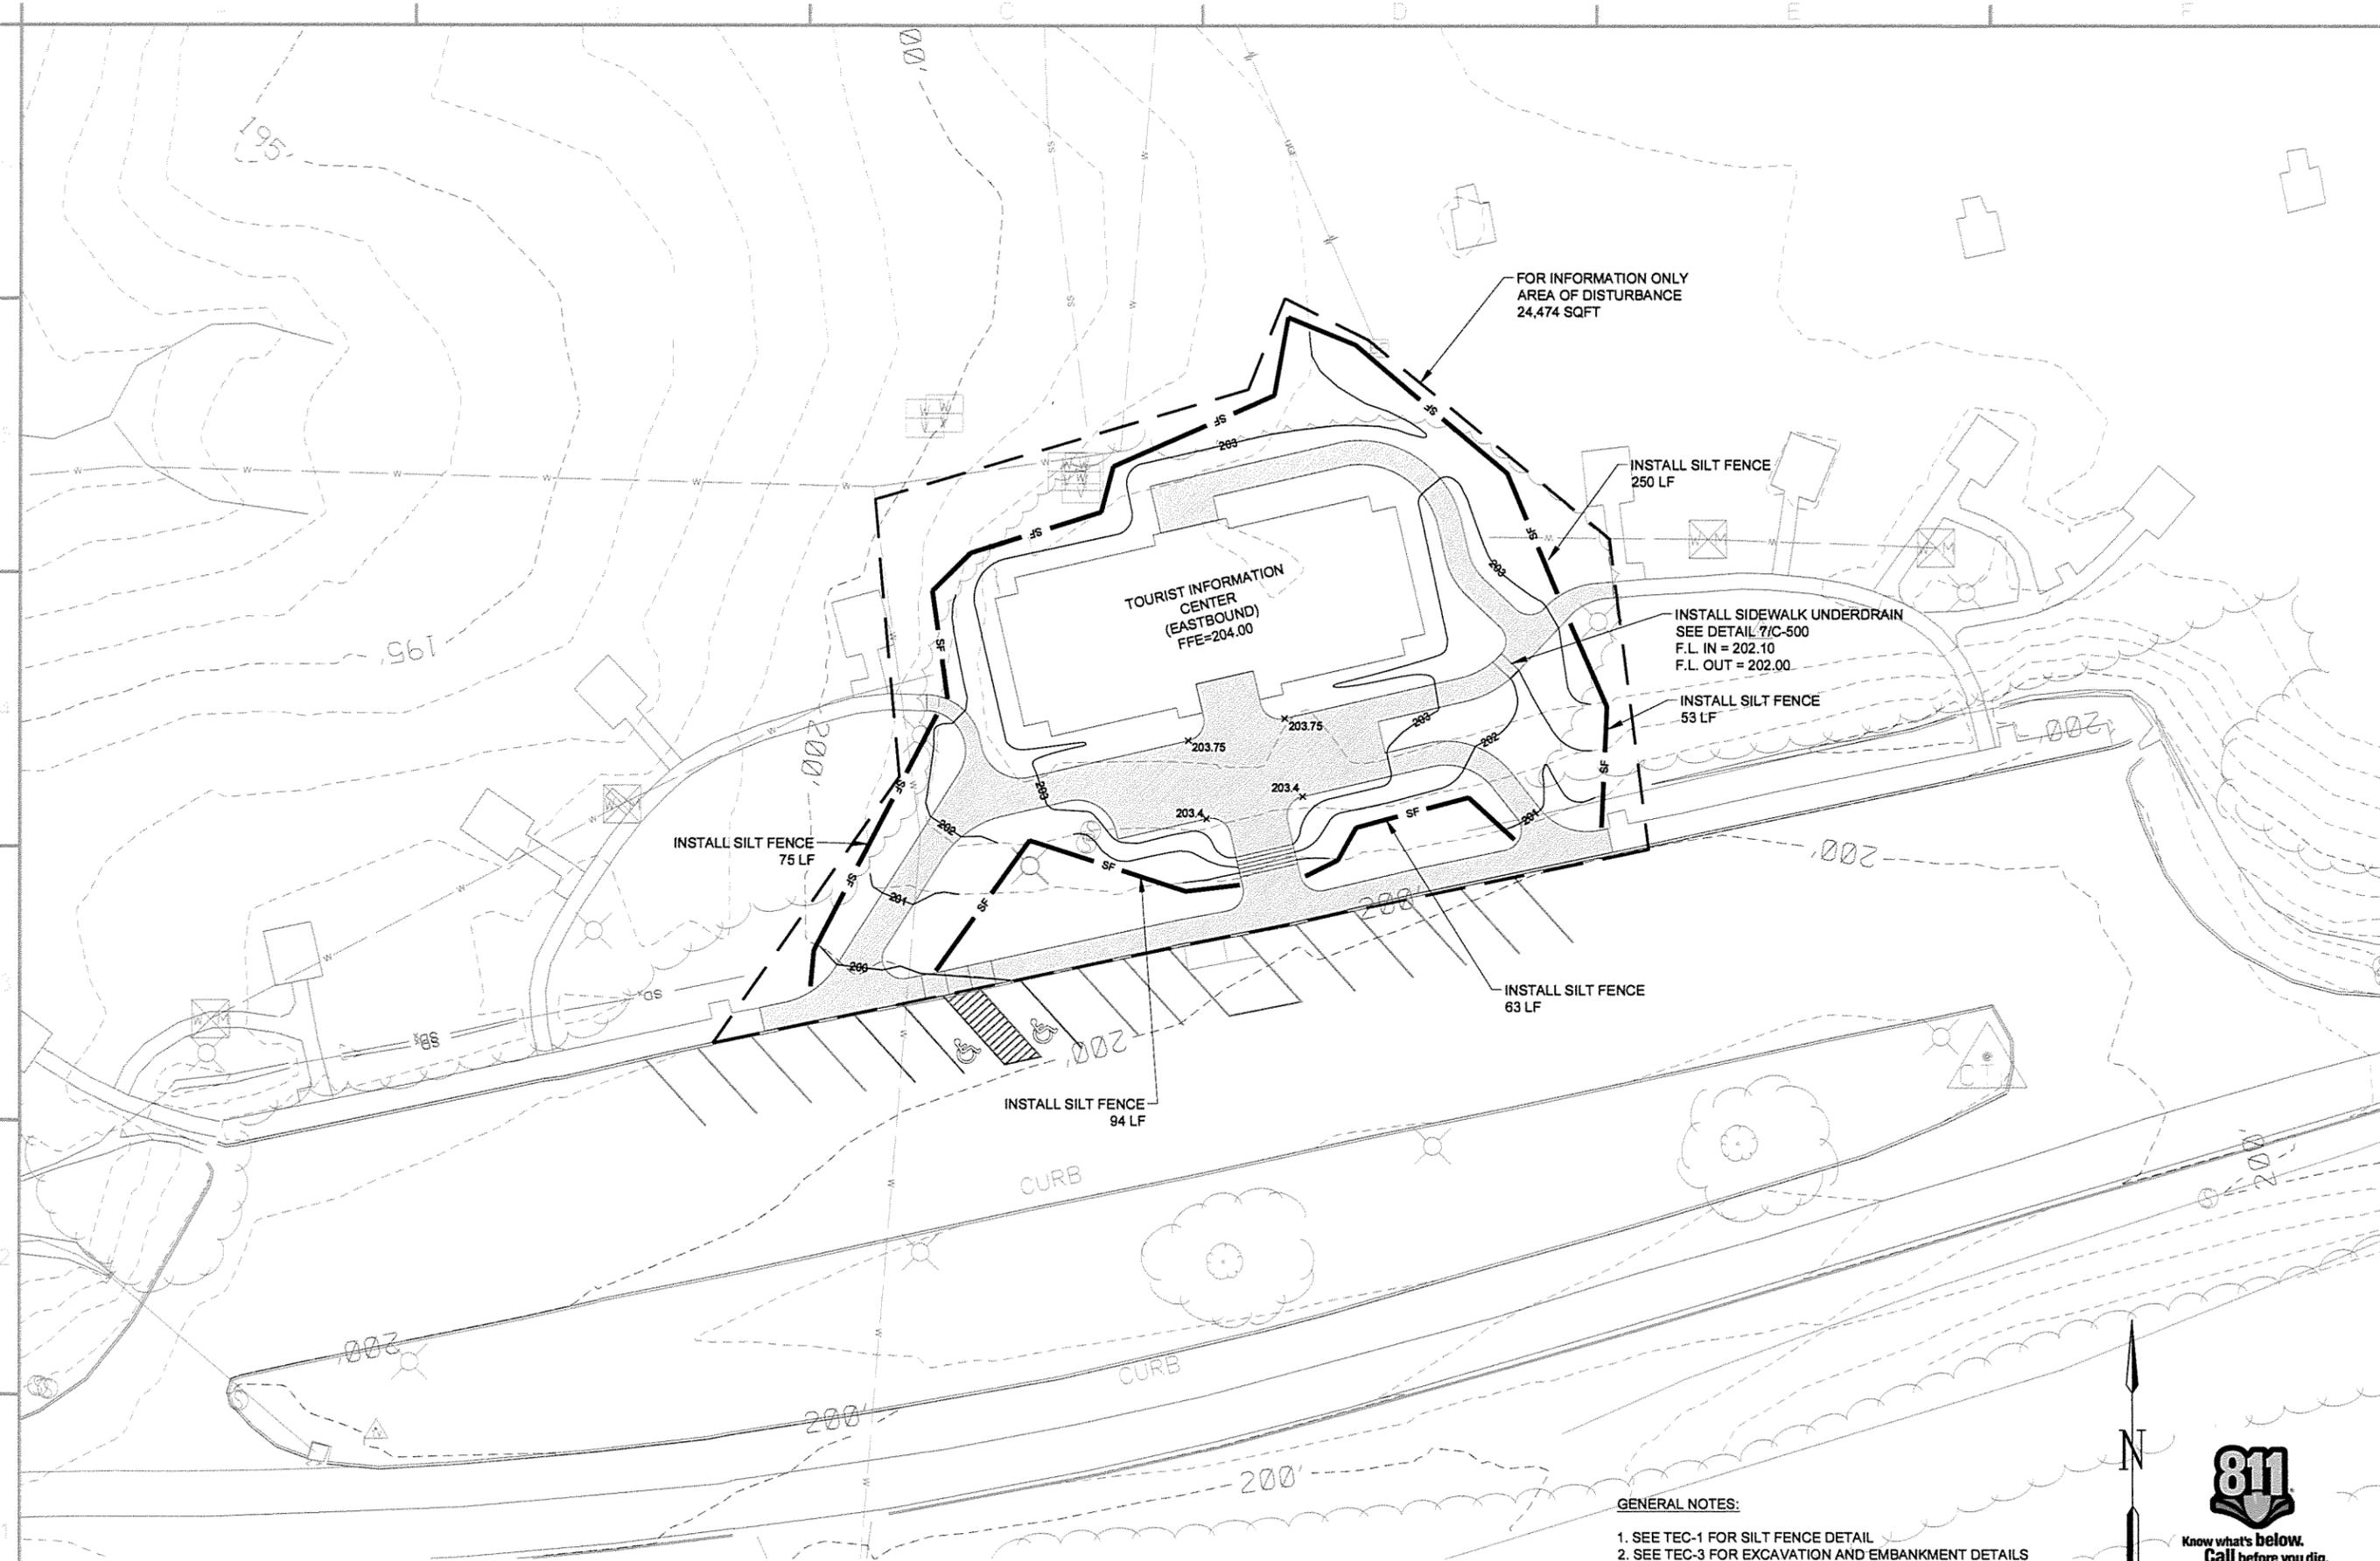

- GENERAL NOTES:**
- SEE TEC-1 FOR SILT FENCE DETAIL
 - SEE TEC-3 FOR EXCAVATION AND EMBANKMENT DETAILS

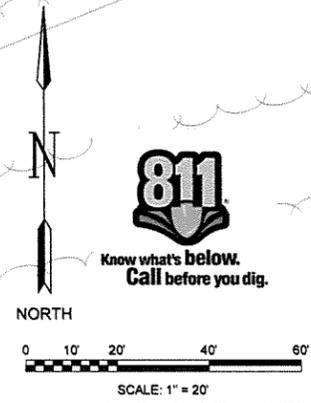

1
C-113 **GRADING AND EROSION CONTROL PLAN (EASTBOUND)**
SCALE: 1" = 20'

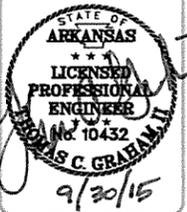


Symbol	IFC	Issued for Construction	Date	Appr

Job Number	060451
Submitted by	J.E. SE
Director, Federal Services	N/A
Plot Scale	1:1
Plot Date	9/30/15
Dwg Code	
Designed by	T. GRABAM
Drawn by	T. DARTON
Checked by	G. ARCHER
File Name	AH15HR-C-113.DWG

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TOURIST INFORMATION CENTER
 GRADING AND EROSION CONTROL PLAN
 (EASTBOUND)

Sheet Reference Number:
C-113
 Sheet 16 of 130

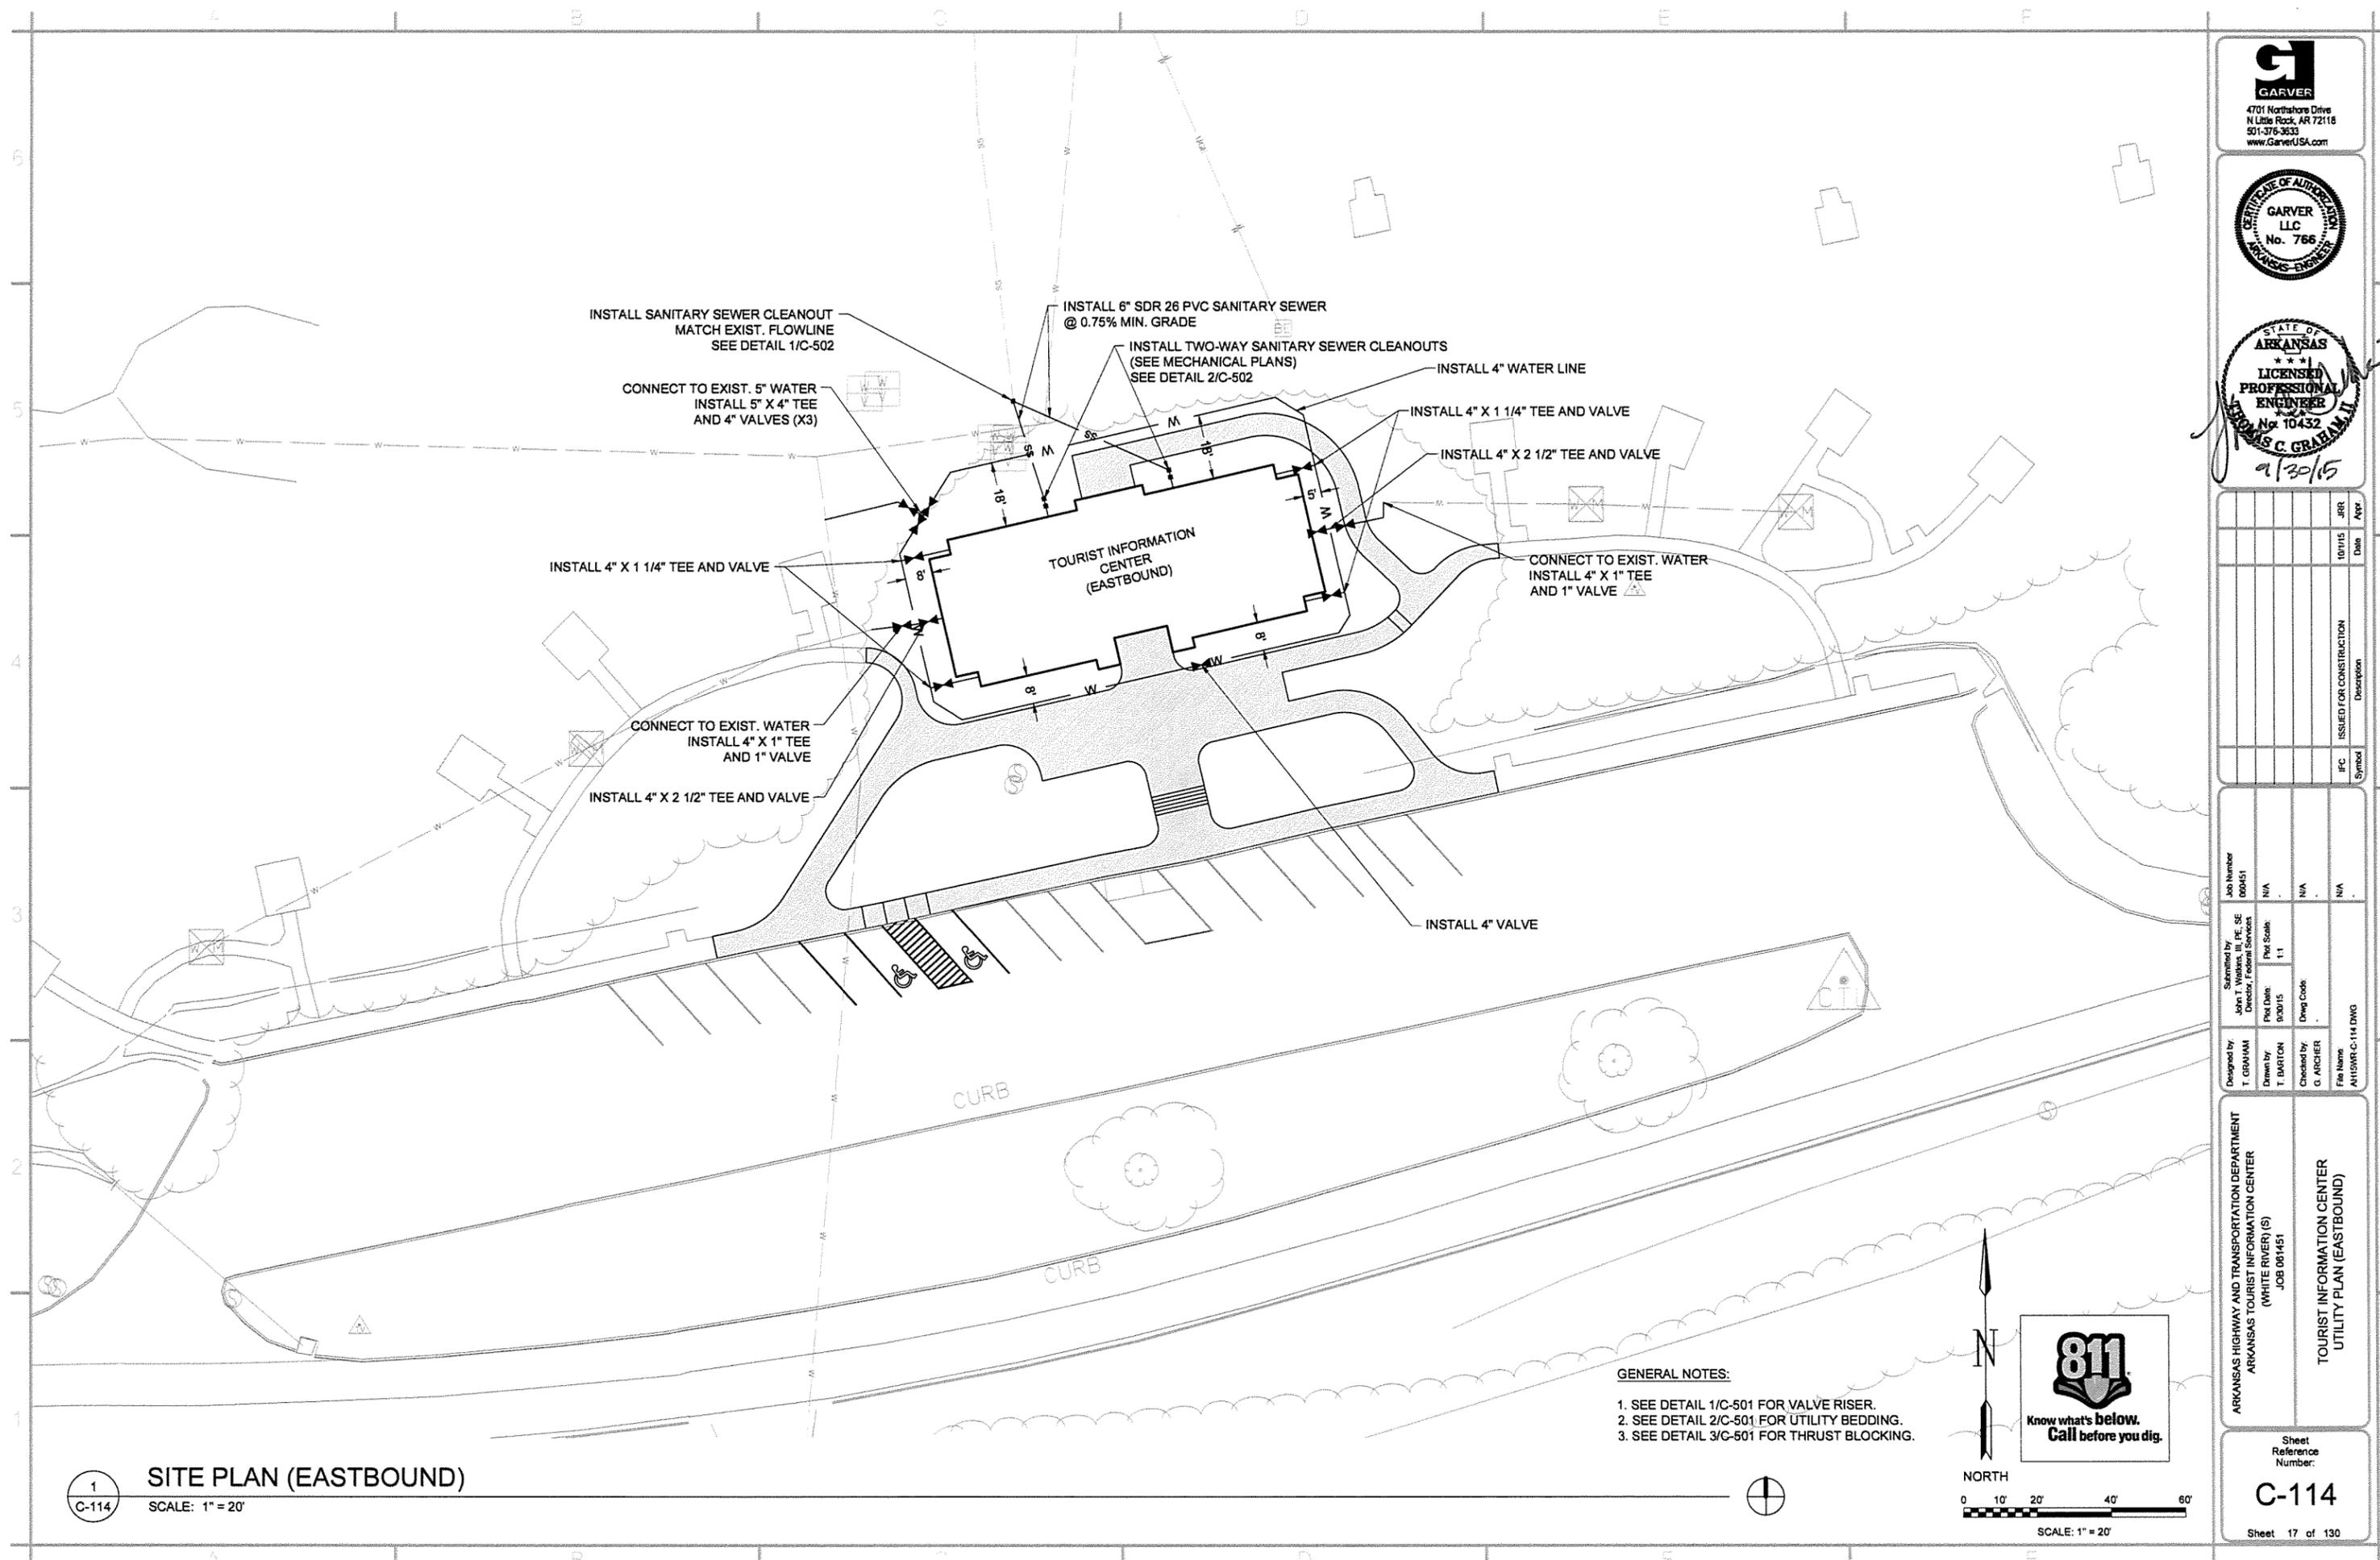

INSTALL SANITARY SEWER CLEANOUT
MATCH EXIST. FLOWLINE
SEE DETAIL 1/C-502

INSTALL 6\"/>

INSTALL TWO-WAY SANITARY SEWER CLEANOUTS
(SEE MECHANICAL PLANS)
SEE DETAIL 2/C-502

INSTALL 4\"/>

CONNECT TO EXIST. 5\"/>

INSTALL 4\"/>

INSTALL 4\"/>

INSTALL 4\"/>

CONNECT TO EXIST. WATER
INSTALL 4\"/>

CONNECT TO EXIST. WATER
INSTALL 4\"/>

INSTALL 4\"/>

INSTALL 4\"/>

GENERAL NOTES:


1. SEE DETAIL 1/C-501 FOR VALVE RISER.
2. SEE DETAIL 2/C-501 FOR UTILITY BEDDING.
3. SEE DETAIL 3/C-501 FOR THRUST BLOCKING.

NORTH

SCALE: 1" = 20'

1
C-114 **SITE PLAN (EASTBOUND)**
SCALE: 1" = 20'

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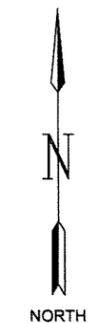
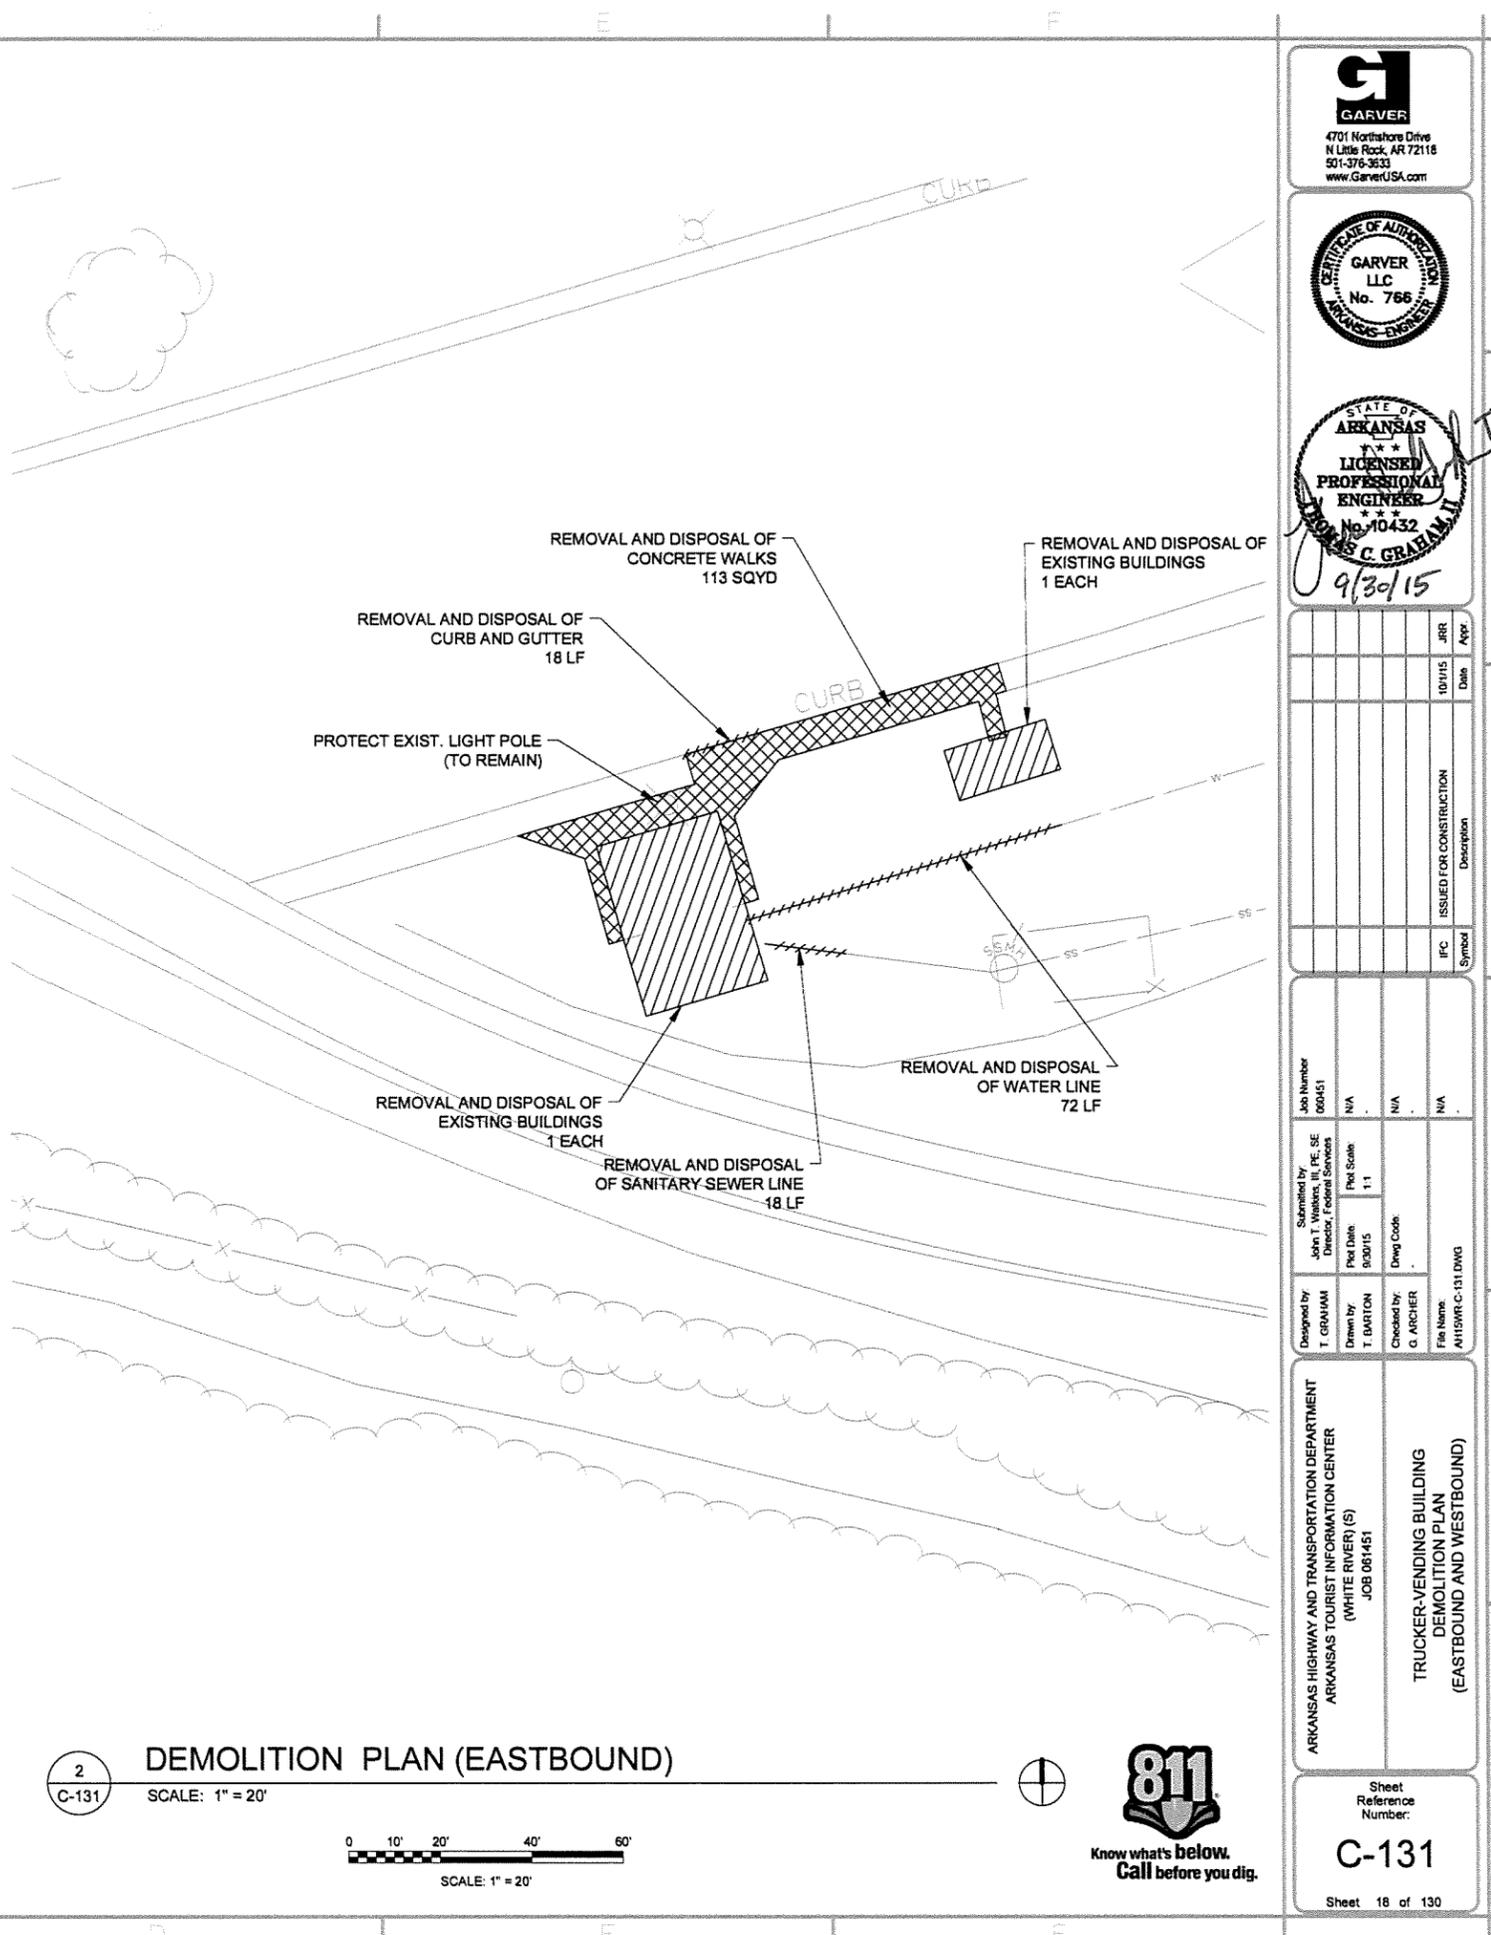
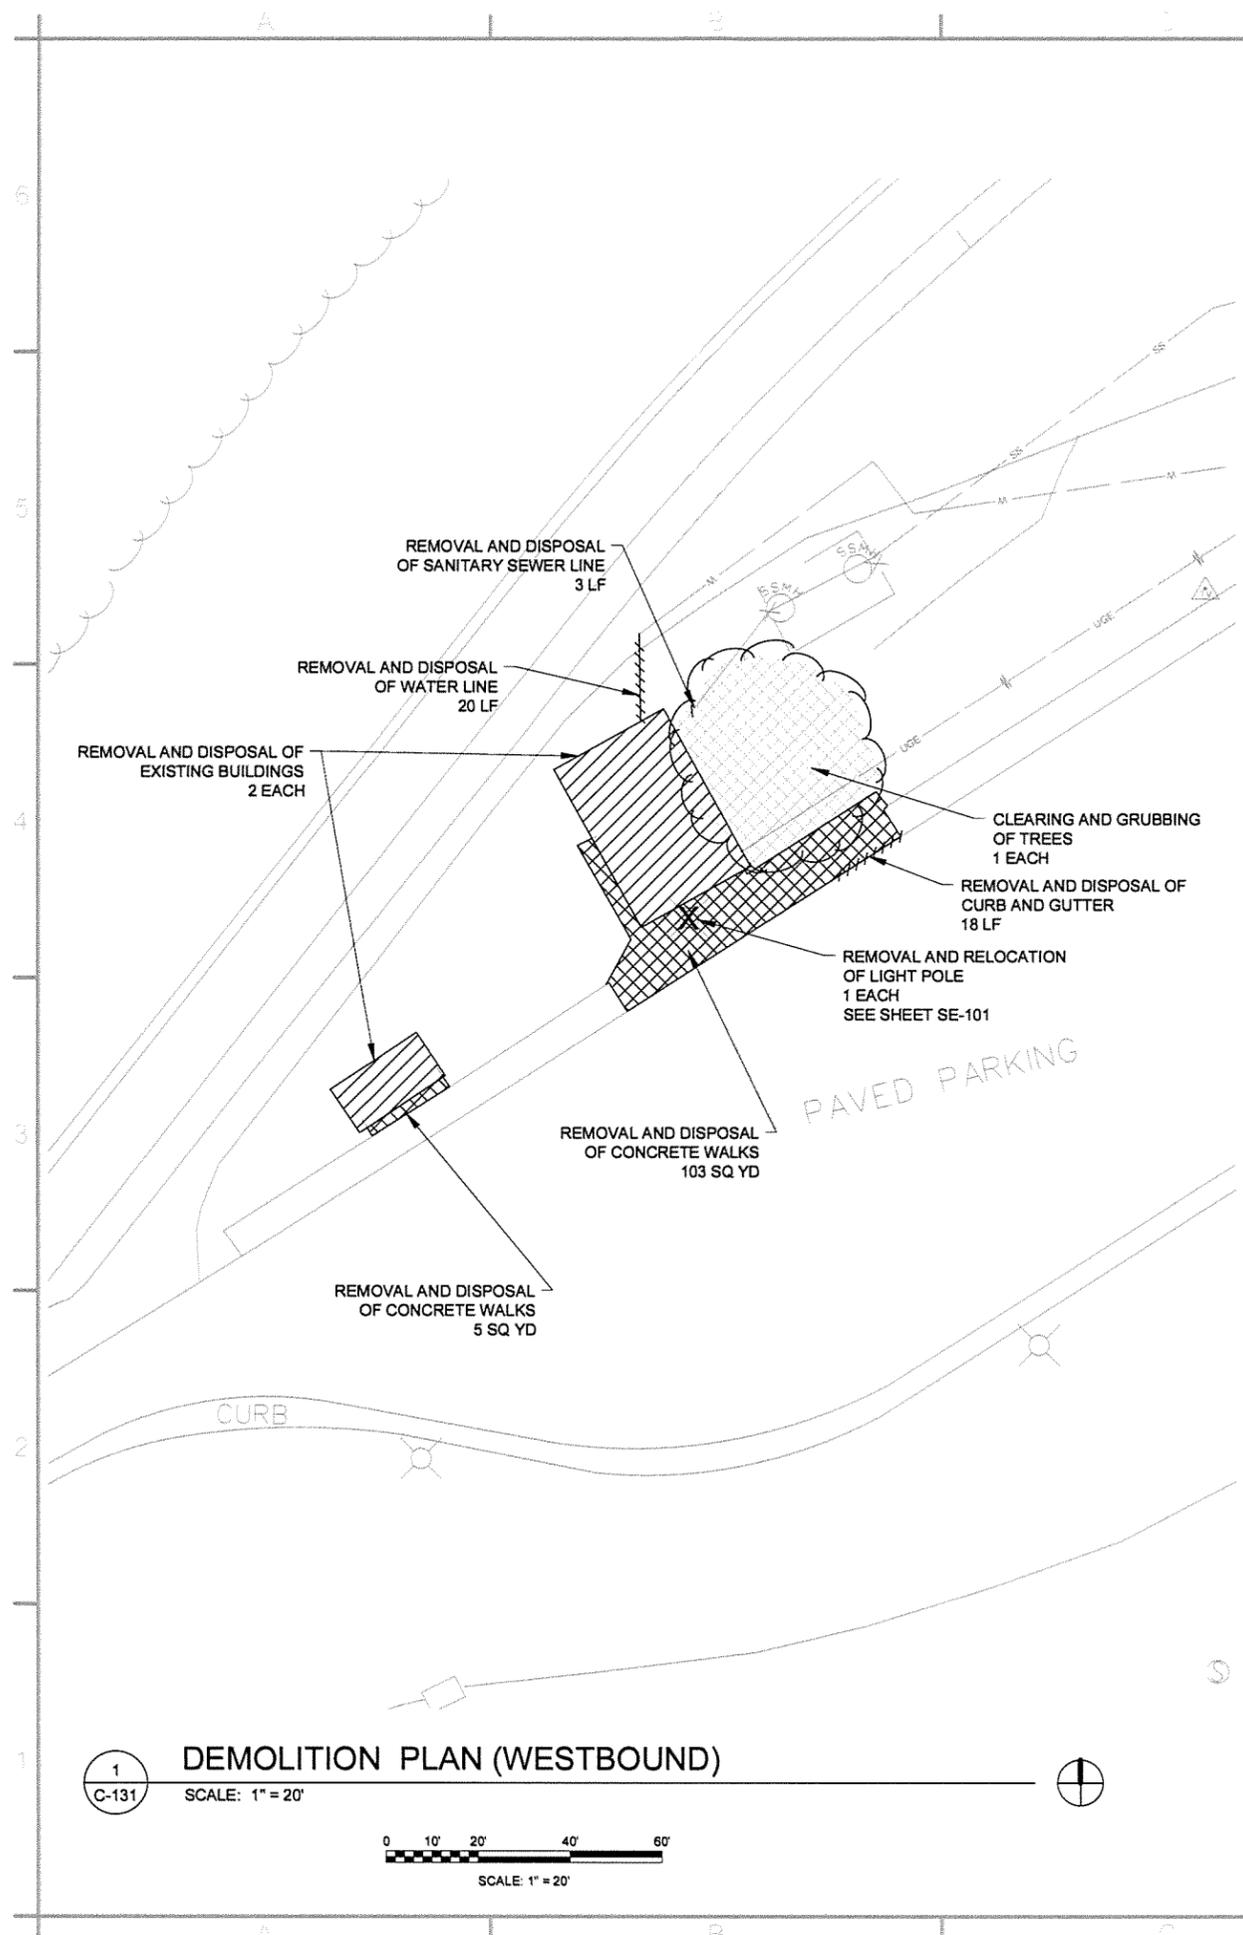
Date	Appr	JRR	Symbol	Description
10/1/15			IFC	ISSUED FOR CONSTRUCTION

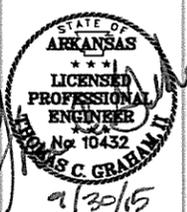Submitted by John P. Winters, P.E., SE Director, Program Services	Job Number 000451
Drawn by T. BARTON	Plot Scale: 1:1
Checked by G. ARCHER	Plot Date: 09/30/15
File Name: A1151WR-C-114.DWG	Draw Code: N/A
	Job Code: N/A
	Job Description: N/A


ARKANSAS HIGHWAY AND TRANSPORTATION DEPARTMENT
ARKANSAS TOURIST INFORMATION CENTER
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JOB 061451

**TOURIST INFORMATION CENTER
UTILITY PLAN (EASTBOUND)**

Sheet Reference Number:
C-114
Sheet 17 of 130



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Date	Appr.	Issued For	Description
10/1/15	JRR	ISSUED FOR CONSTRUCTION	
		IFC	Symbol


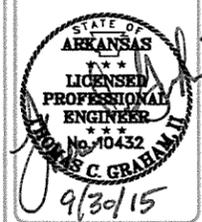
Job Number	000451
Submitted by	SE
Job Title	Director, Federal Services
Plot Date	9/30/15
Plot Scale	1:1
Drawn by	T. BARTON
Checked by	G. ARCHER
File Name	A1151WR-C-131.DWG

ARKANSAS HIGHWAY AND TRANSPORTATION DEPARTMENT
 ARKANSAS TOURIST INFORMATION CENTER
 (WHITE RIVER) (S)
 JOB 061451

TRUCKER-VENDING BUILDING
 DEMOLITION PLAN
 (EASTBOUND AND WESTBOUND)



Sheet Reference Number:
C-131
 Sheet 16 of 130



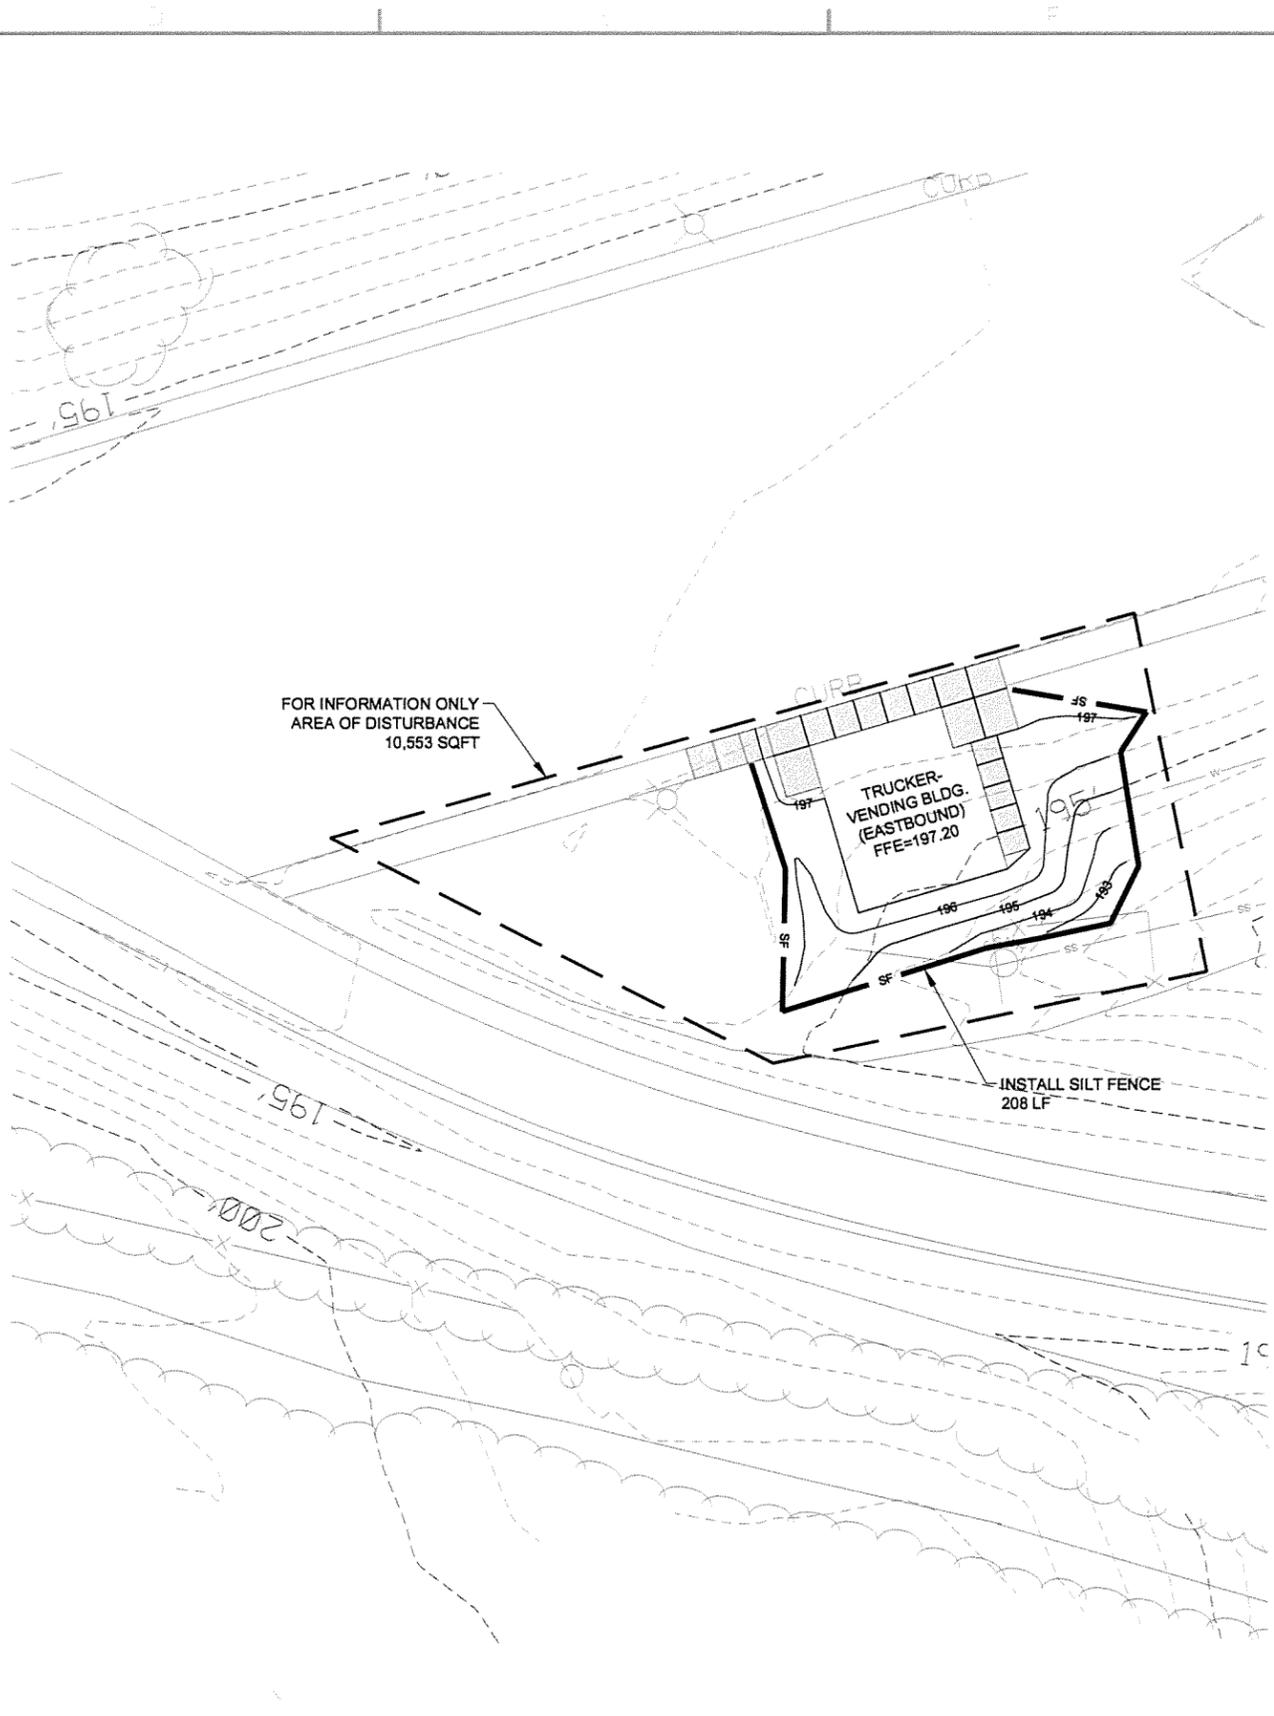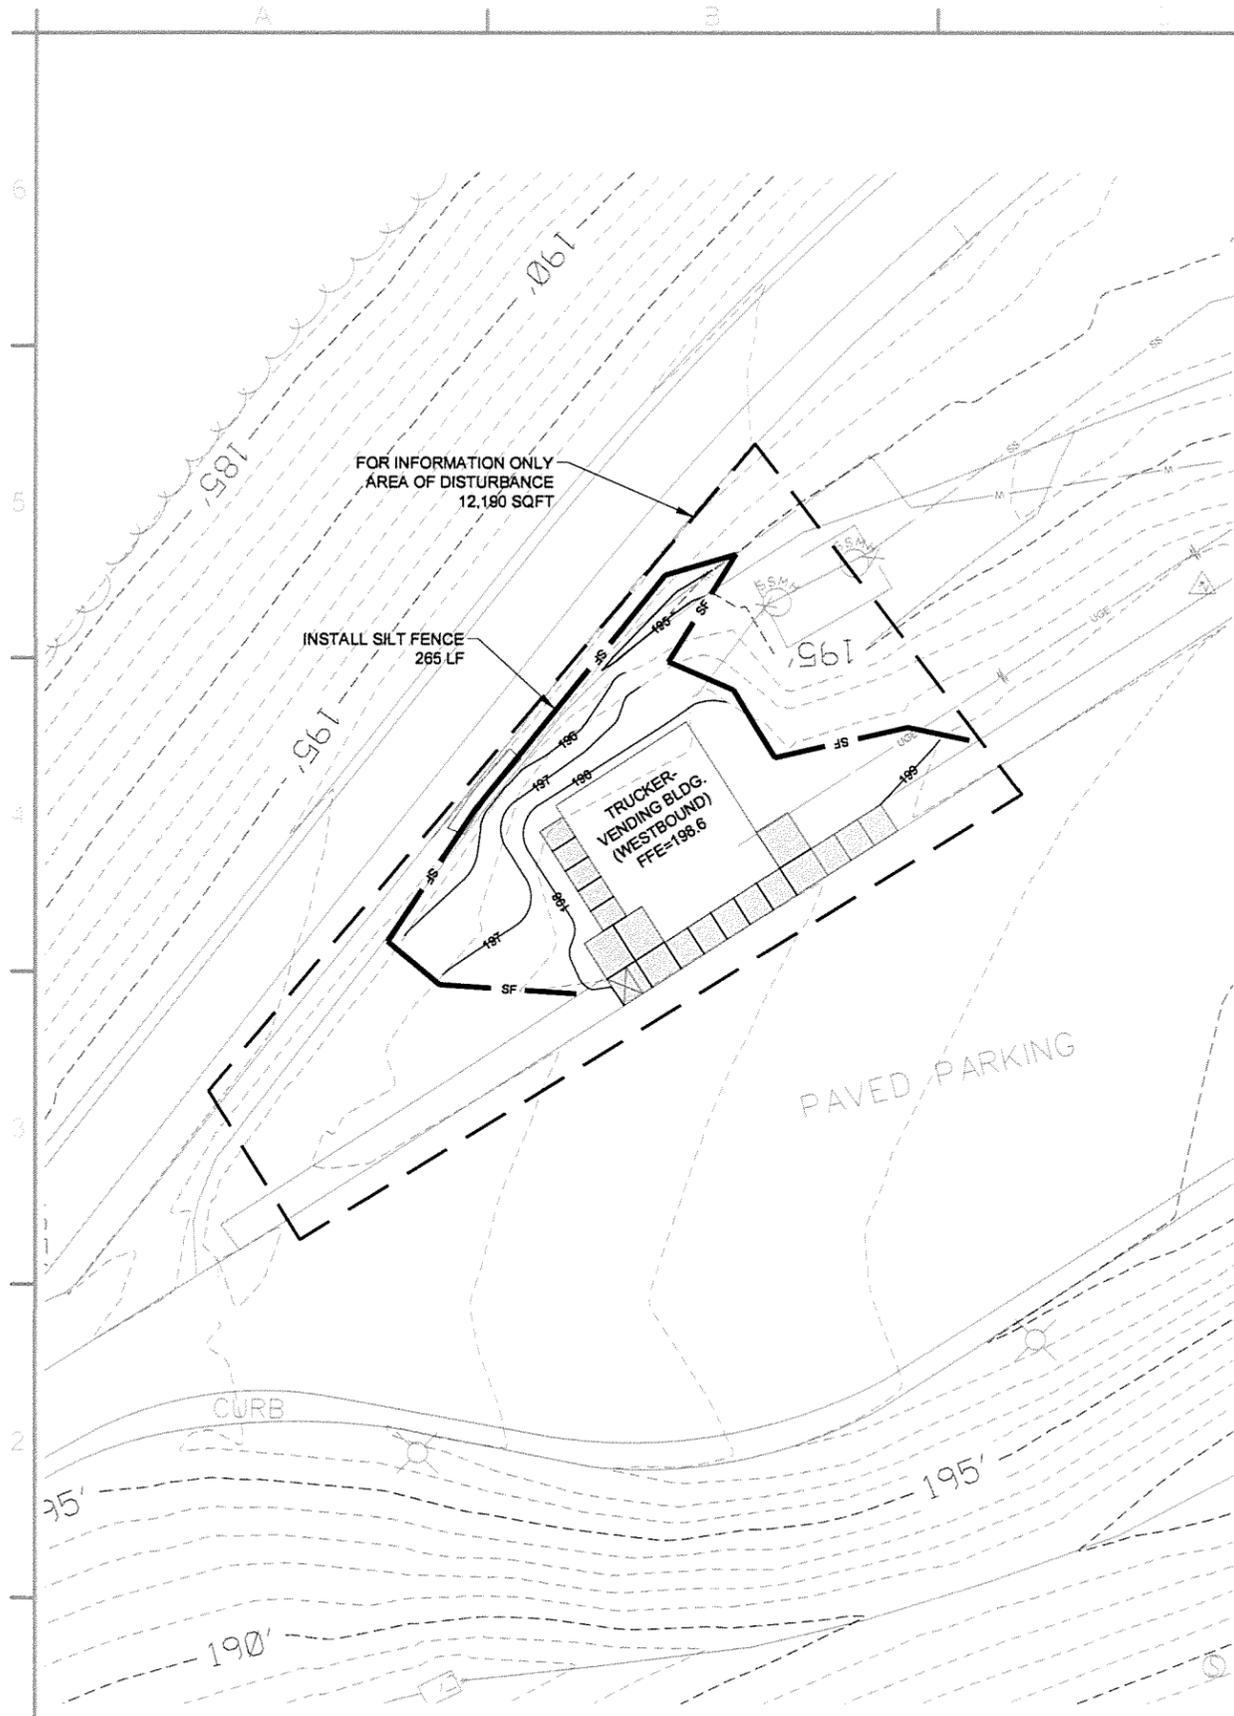


1 GRADING AND EROSION CONTROL PLAN (WEST BOUND)

2 GRADING AND EROSION CONTROL PLAN (EAST BOUND)

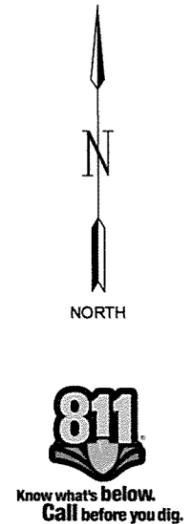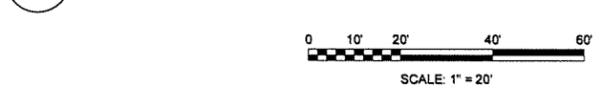

GENERAL NOTES:
 1. SEE TEC-1 FOR SILT FENCE DETAIL
 2. SEE TEC-3 FOR EXCAVATION AND EMBANKMENT DETAILS

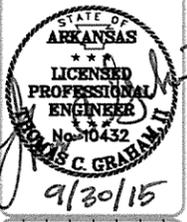


Symbol	Description	Date	Appr
IFC	ISSUED FOR CONSTRUCTION	10/15	JRR

Job Number	06051
Submitted by	SE
Job Director	SE
Plot Scale	N/A
Plot Date	9/30/15
Plot Scale	1:1
Drawn by	T. BARTON
Checked by	G. ARCHER
File Name	AR151RR-C-133 DWG


ARKANSAS HIGHWAY AND TRANSPORTATION DEPARTMENT
 ARKANSAS TOURIST INFORMATION CENTER
 (WHITE RIVER) (S)
 JOB 061451

TRUCKER-VENDING BUILDING
 GRADING AND EROSION CONTROL PLAN
 (EASTBOUND AND WESTBOUND)

Sheet Reference Number:
C-133
 Sheet 20 of 130

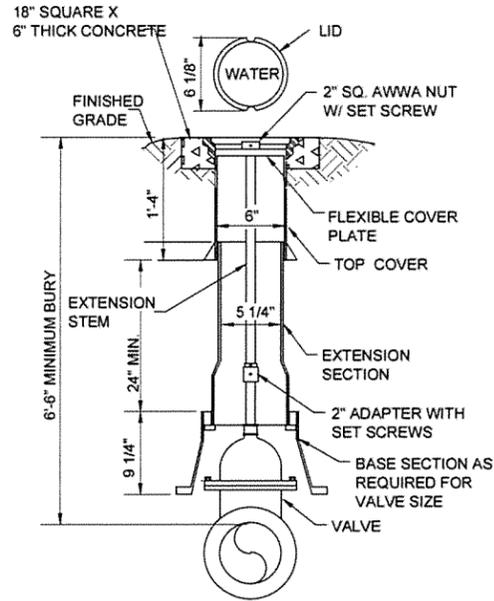

1 VALVE RISER DETAIL
SCALE: NONE

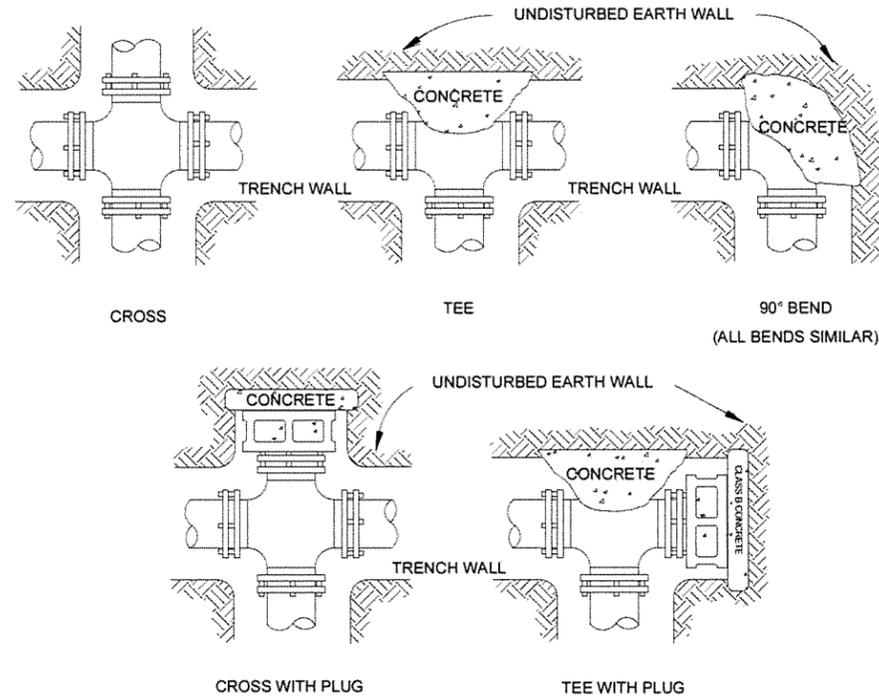

HORIZONTAL FITTINGS

HORIZONTAL THRUST BLOCKING TABLE					
SIZE	REQUIRED SQ. FT. OF UNDISTURBED EARTH WALL FOR REACTION BACKING				
	TYPE OF FITTINGS				
	TEE	90°	45°	2 1/2°	1 1/4°
2"	1	1	1	1	1
3"	1	1	1	1	1
4"	1	1	1	1	1
6"	1.5	2	1	1	1
8"	2.5	3.5	1.8	1	1
10"	4	5.5	2.8	1.5	1
12"	6	8	4	2	1.5
14"	8	11	5.5	3	2
16"	10	14.2	7	4	3
18"	21	21	12	6	4
20"	26	26	14	7	5
24"	38	38	20	10	7
30"	59	59	32	16	9
36"	85	85	46	23	12


MINIMUM CONCRETE VOLUMES FOR UPWARD THRUST BLOCKING

PIPE SIZE inches	11.25 DEGREE BEND				22.5 DEGREE BEND				45 DEGREE BEND				90 DEGREE BEND			
	ANCHOR STRAPS		Concrete VOLUME cu.yd.	ANCHOR STRAPS		Concrete VOLUME cu.yd.	ANCHOR STRAPS		Concrete VOLUME cu.yd.	ANCHOR STRAPS		Concrete VOLUME cu.yd.	ANCHOR STRAPS		Concrete VOLUME cu.yd.	
	NO.	SIZE		NO.	SIZE		NO.	SIZE		NO.	SIZE					
2.0	1	#4Ø	0.04	1	#4Ø	0.08	1	#4Ø	0.16	1	#4Ø	0.30				
3.0	1	#4Ø	0.09	1	#4Ø	0.18	1	#4Ø	0.36	1	#4Ø	0.67				
4.0	1	#4Ø	0.16	1	#4Ø	0.33	1	#4Ø	0.64	1	#4Ø	1.19				
6.0	1	#4Ø	0.37	1	#4Ø	0.74	1	#4Ø	1.44	1	#4Ø	2.67				
8.0	1	#4Ø	0.66	1	#4Ø	1.31	1	#4Ø	2.57	2	#4Ø	4.74				
10.0	1	#4Ø	1.03	1	#4Ø	2.04	2	#4Ø	4.01	2	#4Ø	7.40				
12.0	1	#4Ø	1.48	1	#4Ø	2.94	2	#4Ø	5.77	2	#5Ø	10.65				
14.0	1	#4Ø	2.01	2	#4Ø	4.01	2	#4Ø	7.86	2	#6Ø	14.52				
16.0	1	#4Ø	2.63	2	#4Ø	5.23	2	#5Ø	10.26	3	#5Ø	18.95				


NOTE: 18" AND LARGER REQUIRES SPECIFIC DESIGN

NOTES:

- DO NOT COVER BELLS OR FLANGES WITH CONCRETE.
- WRAP ALL FITTINGS WITH VISQUEEN.
- BACK ALL TEES ACCORDING TO SIZE OF BRANCH.
- BACKING FUTURE LINE EXTENSIONS SHALL BE SUCH THAT LATER REMOVAL IS POSSIBLE.
- ALL BENDS WHERE FITTINGS ARE USED, BOTH HORIZONTAL OR VERTICAL SHALL BE BACKED.
- REACTION BACKING TABLE IS BASED ON 100 P.S.I. AND SOIL BEARING PRESSURE OF 2,500 P.S.F. ADDITIONAL BACKING MAY BE REQUIRED IN SOME AREAS AS DIRECTED BY ENGINEERS.
- ALL CONCRETE SHALL BE 2,500 P.S.I.

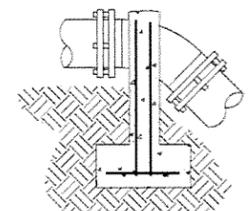


UPWARD THRUST BLOCKING

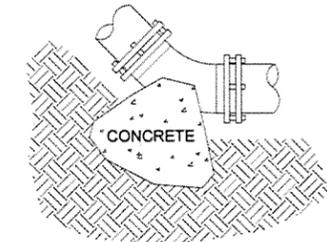

DOWNWARD THRUST BLOCKING
(SEE HORIZONTAL TABLE)

45° BENDS
(ALL BENDS SIMILAR)

VERTICAL FITTINGS

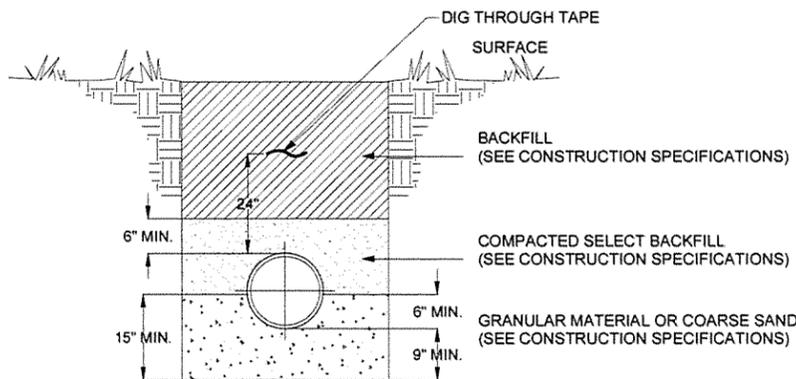

2 UTILITY BEDDING DETAIL
SCALE: NONE

3 THRUST BLOCKING
SCALE: NONE

NOTE:
ALL ITEMS SHOWN ON THIS PAGE WILL BE PAID AS "SITE UTILITIES" BY THE LUMP SUM.



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9/30/15

Date	By	Description
10/1/15	JRR	APR
		ISSUED FOR CONSTRUCTION
		Symbol


Submitted by John T. Wilson, III, PE, SE Director, Federal Services	Job Number 000451		
Drawn by T. BARTON	Plot Scale 1" = 1'		
Checked by G. ARCHER	Draw Code		
File Name A1151WR-C-501.DWG			

ARKANSAS HIGHWAY AND TRANSPORTATION DEPARTMENT
ARKANSAS TOURIST INFORMATION CENTER
WHITE RIVER (S)
JOB 081451

DETAILS II

EXTERIOR AREA LIGHTING PLAN


SCALE: 1" = 100'

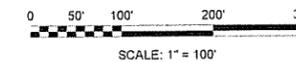

SCALE: 1" = 100'

FOR INFORMATION ONLY	
TYPE SA	14 LOCATIONS
TYPE SB	12 LOCATIONS

- KEYED NOTES**
- 1 REPLACE EXISTING LIGHT FIXTURE WITH FIXTURE TYPE SA, REFER TO LIGHT FIXTURE SCHEDULE SHEET ON E-603 FOR FIXTURE DETAILS. REUSE EXISTING POLE, CONDUIT, AND WIRE.
 - 2 REPLACE EXISTING LIGHT FIXTURE WITH FIXTURE TYPE SB, REFER TO LIGHT FIXTURE SCHEDULE SHEET ON E-603 FOR FIXTURE DETAILS. REUSE EXISTING POLE, CONDUIT, AND WIRE.
 - 3 RELOCATE EXISTING LIGHTING STANDARD TO NEW LOCATION. REPLACE EXISTING LIGHT FIXTURE WITH FIXTURE TYPE SA. REFER TO LIGHT FIXTURE SCHEDULE SHEET ON E-602 FOR FIXTURE DETAILS. EXTEND EXISTING CONDUIT, AND WIRE AS REQUIRED.
 - 4 EXTEND EXISTING LIGHTING CIRCUIT TO NEW PANEL TR.

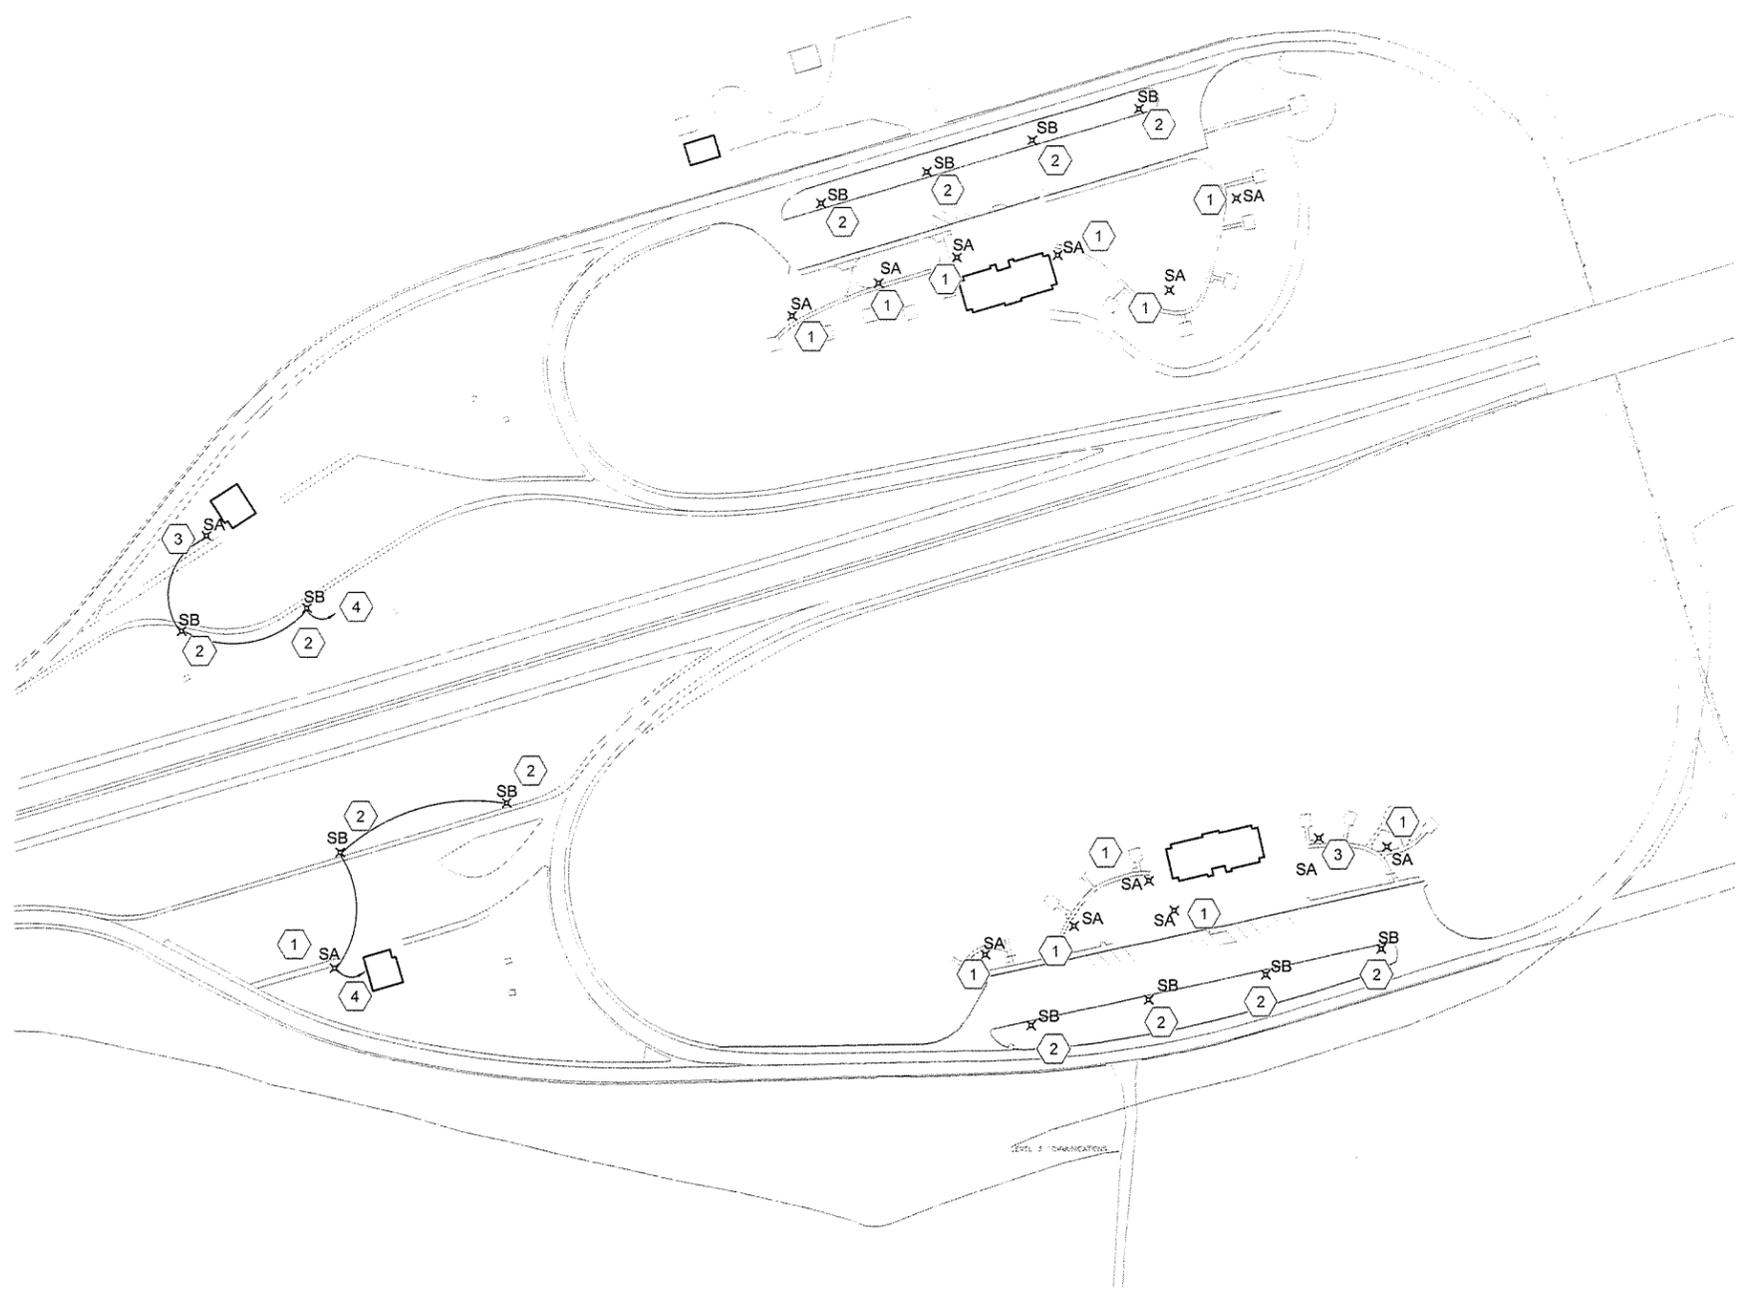


JRR	Appr.
10/1/15	Date
ISSUED FOR CONSTRUCTION	Description
IPC	Symbol


Job Number 000451	N/A	N/A	N/A
Submitted by John T. Watkins, III, PE, SE Director, Federal Services	Plot Scale: 1:1	Draw Code: S FEZOR	File Name: AR101WRSE101.DWG
Designed by B. MELTON	Drawn by H. HOOVER	Checked by S. FEZOR	
Plot Date 9/30/15			

ARKANSAS HIGHWAY AND TRANSPORTATION DEPARTMENT
 ARKANSAS TOURIST INFORMATION CENTER
 (WHITE RIVER) (S)
 JOB 061451
 EXTERIOR AREA LIGHTING PLAN


GENERAL NOTES
INSTALL A MINIMUM OF 2 UPSLOPE STAKES AND 4 DOWNSLOPE STAKES AT AN ANGLE TO WEDGE WATTLE TO BOTTOM OF DITCH.

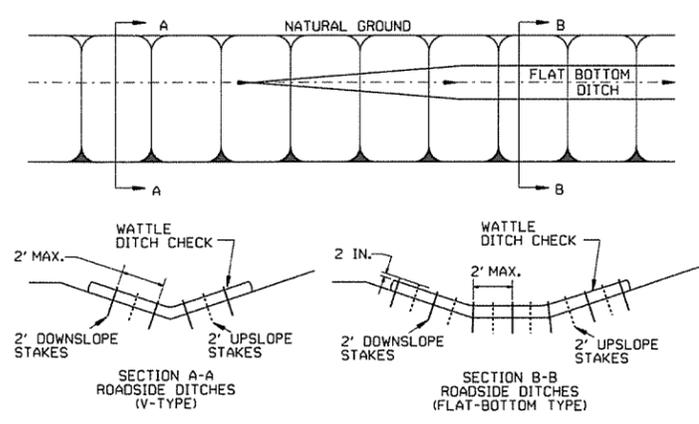

WATTLE DITCH CHECK (E-1)

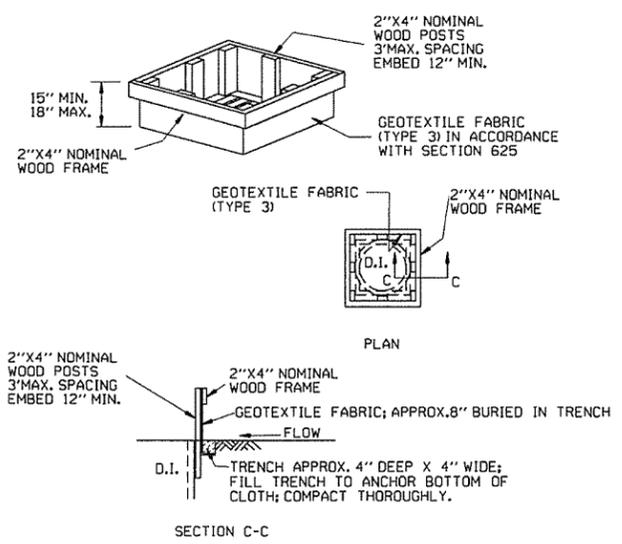


DROP INLET SILT FENCE (E-7)

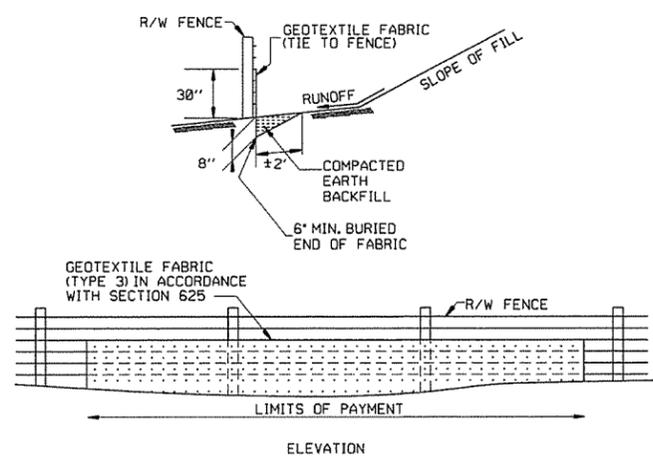


SILT FENCE ON R/W FENCE (E-4)

GENERAL NOTES
GEOTEXTILE FABRIC SHALL BE SPLICED TOGETHER WITH A SEWN SEAM ONLY AT A SUPPORT POST, OR TWO SECTIONS OF FENCE MAY BE OVERLAPPED INSTEAD. PAYMENT OF ADDITIONAL MATERIAL FOR OVERLAP WILL NOT BE MADE.


GENERAL NOTES
1. STRAW BALES SHALL BE INSTALLED SO THAT THE BINDINGS ARE ORIENTED AROUND THE SIDES RATHER THAN ALONG THE TOPS AND BOTTOMS OF THE BALES. THE BALES SHALL BE A MINIMUM OF 30 INCHES IN LENGTH.
2. NO GAPS SHALL BE LEFT BETWEEN BALES.
3. BALED STRAW FILTER BARRIERS COMPLETED AND ACCEPTED WILL BE MEASURED BY THE BALE IN PLACE AS AUTHORIZED BY THE ENGINEER AND WILL BE PAID FOR AT THE CONTRACT UNIT PRICE BID PER BALE FOR BALED STRAW DITCH CHECKS.

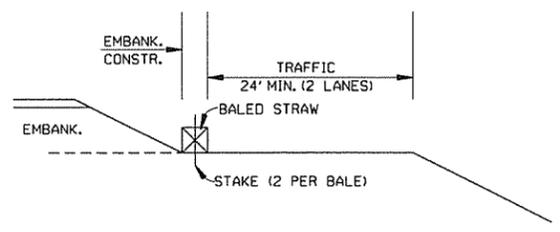

BALED STRAW FILTER BARRIER (E-2)

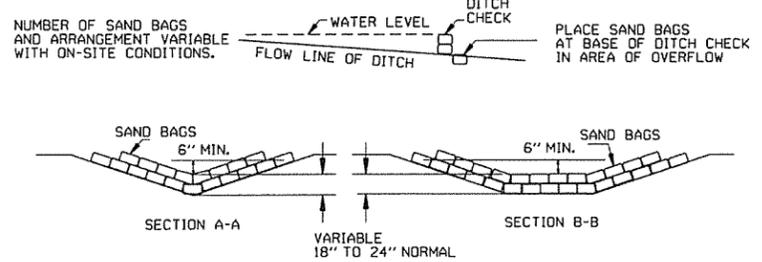


SAND BAG DITCH CHECK (E-5)

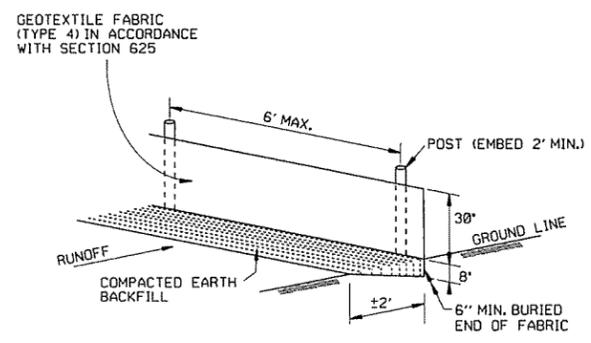

SILT FENCE (E-11)

GENERAL NOTES
GEOTEXTILE FABRIC SHALL BE SPLICED TOGETHER WITH A SEWN SEAM ONLY AT A SUPPORT POST OR TWO SECTIONS OF FENCE MAY BE OVERLAPPED INSTEAD. PAYMENT OF ADDITIONAL MATERIAL FOR OVERLAP WILL NOT BE MADE.

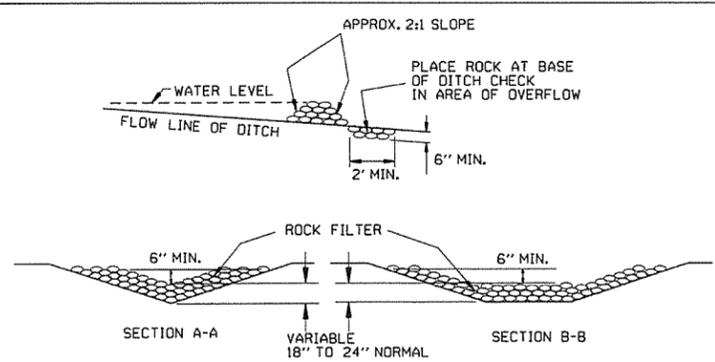

ROCK DITCH CHECK (E-6)


12-15-11	DELETED BALED STRAW DITCH CHECK & ADDED WATTLE DITCH CHECK		ARKANSAS STATE HIGHWAY COMMISSION
11-18-98	ADDED NOTES		
7-02-98	ADDED BALED STRAW FILTER BARRIER (E-2)		
7-20-95	REVISED SILT FENCE E-4 AND E-11	7-20-95	
7-15-94	REV. E-4 & E-11 MIN. 13" BURIED END OF FABRIC		
6-2-94	REVISED E-1, 4, 7 & 11; DELETED E-2 & 3	6-2-94	
4-1-93	REDRAWN		
10-1-92	REDRAWN		
8-2-76	ISSUED R.D.M.	298-7-28-76	
DATE	REVISION	FILMED	STANDARD DRAWING TEC-1

CLEARING AND GRUBBING

CONSTRUCTION SEQUENCE

1. PLACE PERIMETER CONTROLS (I.E. SILT FENCES , DIVERSION DITCHES, SEDIMENT BASINS, ETC.)
2. PERFORM CLEARING AND GRUBBING OPERATION.

EXCAVATION

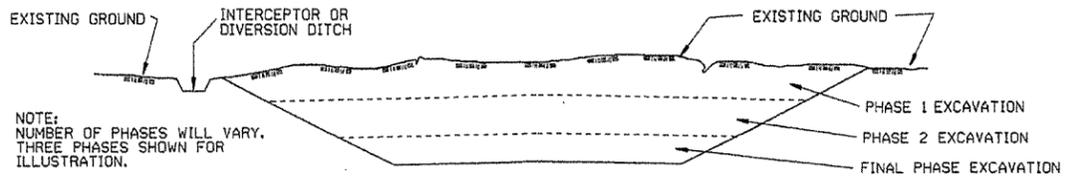

NOTE:
NUMBER OF PHASES WILL VARY.
THREE PHASES SHOWN FOR
ILLUSTRATION.


GENERAL NOTE

ALL CUT SLOPES SHALL BE DRESSED, PREPARED, SEEDED, AND MULCHED AS THE WORK PROGRESSES. SLOPES SHALL BE EXCAVATED AND STABILIZED IN EQUAL INCREMENTS NOT TO EXCEED 25 FEET, MEASURED VERTICALLY.

CONSTRUCTION SEQUENCE

1. EXCAVATE AND STABILIZE INTERCEPTOR AND/OR DIVERSION DITCHES.
2. PERFORM PHASE 1 EXCAVATION. PLACE PERMANENT OR TEMPORARY SEEDING.
3. PERFORM PHASE 2 EXCAVATION. PLACE PERMANENT OR TEMPORARY SEEDING.
4. PERFORM FINAL PHASE OF EXCAVATION. PLACE PERMANENT OR TEMPORARY SEEDING. STABILIZE DITCHES, CONSTRUCT DITCH CHECKS, DIVERSION DITCHES, SEDIMENT BASINS, OR OTHER EROSION CONTROL DEVICES AS REQUIRED.

EMBANKMENT

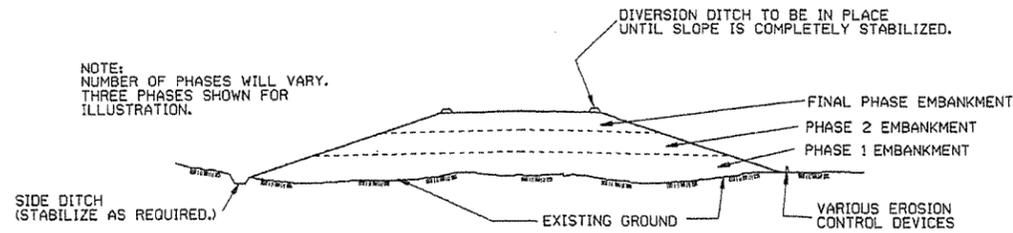

NOTE:
NUMBER OF PHASES WILL VARY.
THREE PHASES SHOWN FOR
ILLUSTRATION.





GENERAL NOTE

ALL EMBANKMENT SLOPES SHALL BE DRESSED, PREPARED, SEEDED, AND MULCHED AS THE WORK PROGRESSES. SLOPES SHALL BE CONSTRUCTED AND STABILIZED IN EQUAL INCREMENTS NOT TO EXCEED 25 FEET, MEASURED VERTICALLY.

CONSTRUCTION SEQUENCE

1. CONSTRUCT DIVERSION DITCHES, DITCH CHECKS, SEDIMENT BASINS, SILT FENCES, OR OTHER EROSION CONTROL DEVICES AS SPECIFIED.
2. PLACE PHASE 1 EMBANKMENT WITH PERMANENT OR TEMPORARY SEEDING. PROVIDE DIVERSION DITCHES AND SLOPE DRAINS IF EMBANKMENT CONSTRUCTION IS TO BE TEMPORARILY ABANDONED FOR A PERIOD OF GREATER THAN 21 DAYS.
3. PLACE PHASE 2 EMBANKMENT WITH PERMANENT OR TEMPORARY SEEDING. PROVIDE DIVERSION DITCHES AND SLOPE DRAINS IF EMBANKMENT CONSTRUCTION IS TO BE TEMPORARILY ABANDONED FOR A PERIOD OF GREATER THAN 21 DAYS.
4. PLACE FINAL PHASE OF EMBANKMENT WITH PERMANENT OR TEMPORARY SEEDING. PLACE DIVERSION DITCHES AND SLOPE DRAINS AND MAINTAIN UNTIL ENTIRE SLOPE IS STABILIZED.

ARKANSAS STATE HIGHWAY COMMISSION		
TEMPORARY EROSION CONTROL DEVICES		
11-03-94	CORRECTED SPELLING	
6-2-94	Drawn & Issued	6-2-94
DATE	REVISION	FILMED
STANDARD DRAWING TEC-3		

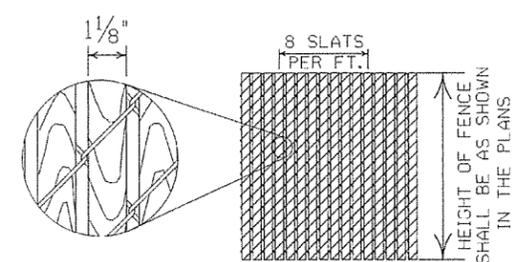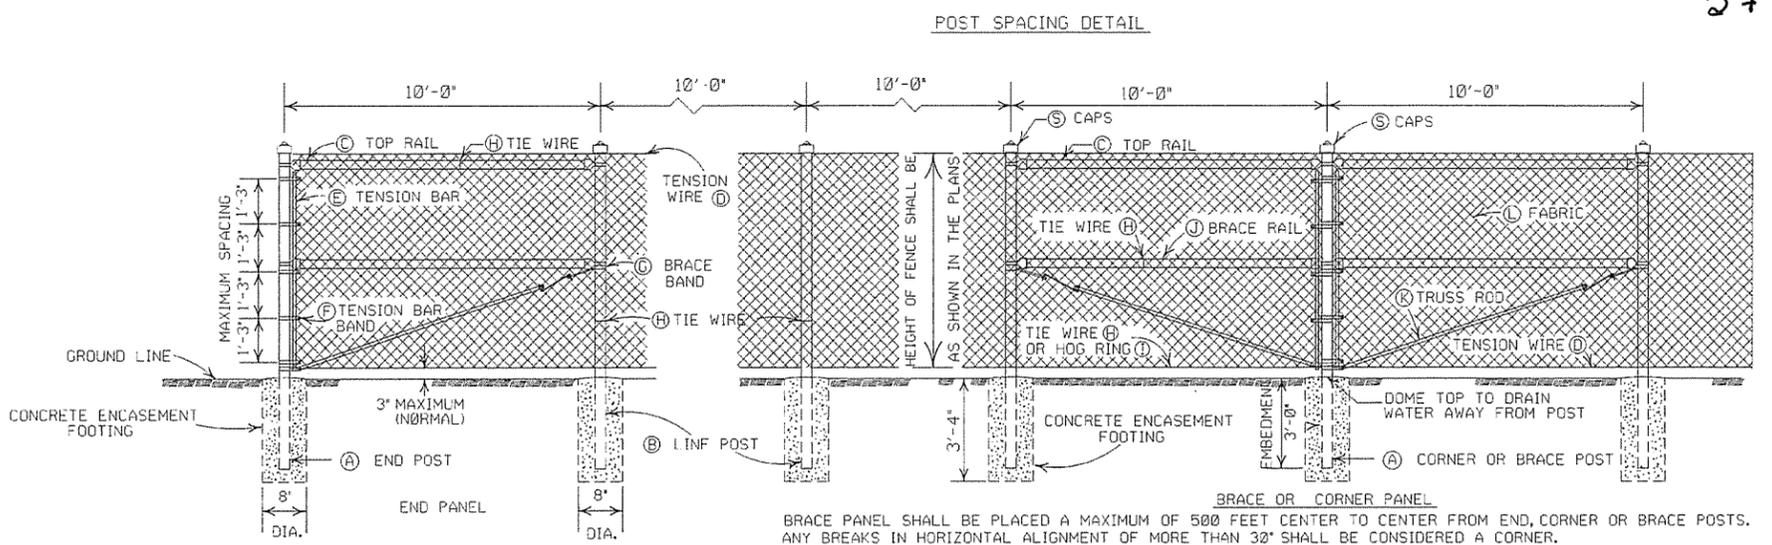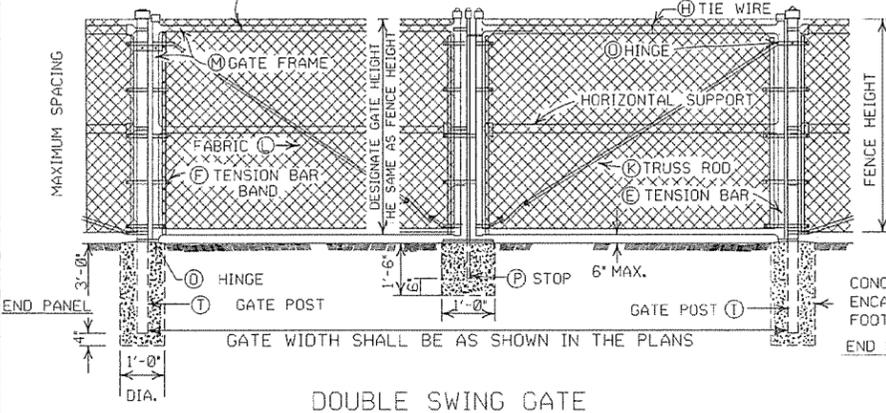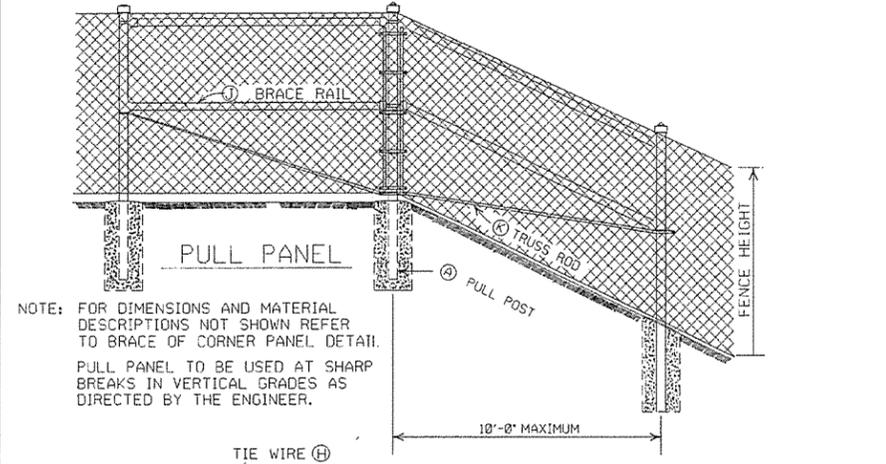

- GENERAL NOTES:**
- (C) CHAIN LINK FENCE BEING PLACED ON PRIVATE PROPERTY SHALL INCLUDE A TOP RAIL. ALL LABOR, MATERIALS, EQUIPMENT, TOOLS, AND INCIDENTALS NECESSARY TO COMPLETE THE WORK WILL BE PAID FOR AT THE CONTRACT UNIT PRICE BID PER LIN. FT. OF CHAIN LINK FENCE.
 - (D) TENSION WIRE: SHALL BE SECURED TO ALL TERMINAL, PULL, BRACE OR CORNER POSTS WITH TENSION BAR BANDS.
 - (J) BRACE RAIL: BRACE RAILS SHALL BE PROVIDED AT ALL TERMINAL, PULL, BRACE OR CORNER POSTS HALF WAY BETWEEN THE TOP RAIL AND GROUND LEVEL WHEN TOPRAIL IS SPECIFIED AND TWELVE INCHES (12") DOWN FROM TOP OF FABRIC WHEN TOP TENSION WIRE IS SPECIFIED. BRACE RAIL SHALL EXTEND FROM SUCH POST TO THE FIRST ADJACENT LINE POST.
 - (L) FABRIC: SHALL CONFORM TO THE SPECIFICATIONS.

HEIGHT OF FENCE FABRIC	(A) END, PULL CORNER OR BRACE POST		(B) LINE POSTS		(C) TOP RAIL			(D) TENSION WIRE		(E) TENSION BAR		(F) TENSION BAR BAND			(G) BRACE BAND	
	SIZE	TIE SPACING	SIZE	TIE SPACING	SIZE	TIE SPACING	MIN. LENGTH	SIZE	TIE SPACING	SIZE	LENGTH	SIZE	BOLT SIZE	SPACING	SIZE	BOLT SIZE
6' AND LESS	2 1/2" O.D.	2' O.D.	1 TIE EVERY 1'-2" OF FABRIC HEIGHT	1 1/2" O.D.	1 TIE EVERY 2'-0"	10'-0"	7 GAUGE COIL SPRING WIRE	1 TIE EVERY 1'-0"	3/16" x 3/4"	MIN. OF 2" LESS THAN FABRIC HEIGHT	3/4" x 3/4"	MIN. OF 0.074	1 BAND AT TOP AND BOTTOM OF 15" MAX. INTERVAL BETWEEN BANDS	3/4" x 3/4"	3/16" x 1 1/4"	0.105
OVER 6' TO 12' INCL.	3" O.D.	2 1/2" O.D.	1 TIE EVERY 2'-0"	1 1/2" O.D.	1 TIE EVERY 2'-0"	10'-0"	7 GAUGE COIL SPRING WIRE	1 TIE EVERY 1'-0"	3/16" x 3/4"	MIN. OF 2" LESS THAN FABRIC HEIGHT	3/4" x 3/4"	MIN. OF 0.074	1 BAND AT TOP AND BOTTOM OF 15" MAX. INTERVAL BETWEEN BANDS	3/4" x 3/4"	3/16" x 1 1/4"	0.105

HEIGHT OF FENCE FABRIC	(H) TIE WIRE	(I) HOG RING	(J) BRACE RAIL		(K) TRUSS ROD	(L) FABRIC		(M) GATE FRAME	(N) HORIZONTAL SUPPORT		(O) HINGE TYPE	(P) GATE POST	
	SIZE	TIE SPACING	SIZE	TIE SPACING	MIN. OF 3/4" ROUND WITH TIGHTENERS AND FITTINGS	SIZE	MESH SELVAGE	SIZE	TIE SPACING	SIZE	TIE SPACING	180° SWING	GATE WIDTH OVER 12' AND LESS 12' TO 24' INCL.
6' AND LESS	MIN. OF 12 GA. STEEL OR 9 GA. ALUM.	SAME GAUGE AS FABRIC	1 1/2" O.D.	1 TIE EVERY 2'-0"	MIN. OF 3/4" ROUND WITH TIGHTENERS AND FITTINGS	9 GA.	2"	2" O.D.	1 TIE EVERY 1'-0"	2" O.D.	1 TIE EVERY 1'-0"	OFFSET	3' O.D.
OVER 6' TO 12' INCL.	MIN. OF 12 GA. STEEL OR 9 GA. ALUM.	SAME GAUGE AS FABRIC	1 1/2" O.D.	1 TIE EVERY 2'-0"	MIN. OF 3/4" ROUND WITH TIGHTENERS AND FITTINGS	9 GA.	2"	2" O.D.	1 TIE EVERY 1'-0"	2" O.D.	1 TIE EVERY 1'-0"	OFFSET	4' O.D.

NOTE: POST SIZES SHOWN ARE FOR STEEL. WHERE ALUMINUM IS PROVIDED, LINE POSTS SHALL HAVE AN OUT SIDE DIAMETER OF 2 1/2" FOR FENCE HEIGHT OF 6' AND LESS, AN OUTSIDE DIAMETER OF 3" FOR FENCE HEIGHT OF 6' TO 12'. END, PULL, CORNER OR BRACE POSTS SHALL HAVE AN OUTSIDE DIAMETER OF 3" FOR FENCE HEIGHT OF 6' AND LESS; AN OUTSIDE DIAMETER OF 3 1/2" FOR FENCE HEIGHTS OF 6' TO 12'. GATE POSTS WHERE GATE WIDTH IS 12' AND LESS SHALL HAVE AN OUTSIDE DIAMETER OF 3 1/2" FOR FENCE HEIGHT OF 6' AND LESS. ALUMINUM TENSION WIRE SHALL BE 0.192" IN DIAMETER. MINIMUM THICKNESS OF MATERIAL FROM WHICH EXPANSION SLEEVES SHALL BE MADE WILL BE 0.078". POSTS AND RAILS MAY HAVE ANY CROSS-SECTIONAL SHAPE THAT WILL MEET THE SPECIFICATIONS.

OTHER DETAILS APPLY TO BOTH STEEL AND ALUMINUM FENCE.


ALL MISCELLANEOUS FITTINGS AND HARDWARE SHALL MEET THE REQUIREMENTS AND PRODUCTION TOLERANCES AS SET FORTH IN THE SPECIFICATIONS. 9 GAUGE ALUMINUM WIRE SHALL BE ACCEPTABLE FOR TIEING FABRIC TO TUBULAR AND ROLL FORMED MEMBERS OF STEEL FENCE.

- (M) GATE FRAMES: SHALL BE CONSTRUCTED OF TUBULAR MEMBERS ASSEMBLED BY USE OF HEAVY PRESSED STEEL, MALLEABLE FITTINGS OR BY WELDING. ALL GATES SHALL HAVE ONE HORIZONTAL SUPPORT EXTENDING THE WIDTH OF THE GATE AT THE MIDPOINTS OF VERTICAL FRAME MEMBERS. THE COMPLETE FRAME SHALL BE RIGID AND HAVE AMPLE STRENGTH TO BE FREE FROM SAG AND TWIST.
- (O) HINGES: SHALL BE OF HEAVY PATTERN, OF ADEQUATE STRENGTH FOR GATE, AND WITH LARGE BEARING SURFACES FOR CLAMPING IN POSITION. THE HINGE SHALL BE OF THE PROPER TYPE TO ALLOW FOR THE DESIGNATED DEGREE OF SWING. THE HINGE SHALL NOT TWIST OR TURN UNDER THE ACTION OF THE GATE. THE GATES SHALL BE CAPABLE OF BEING OPENED AND CLOSED EASILY BY ONE PERSON.
- (P) LATCHES AND STOPS: SHALL BE PROVIDED FOR ALL GATES. GATES SHALL HAVE A DROP BAR LATCH. LATCHES SHALL BE ARRANGED FOR LOCKING. THE STOP FOR DROP BAR LATCHES SHALL BE SET IN CONCRETE AND ENGAGE THE PLUNGER OF THE BAR LATCH.
- (S) CAPS: ALL POSTS, EXCEPT ROLL FORMED POSTS AND "T" POSTS SHALL BE CAPPED OVER THE EXTERIOR OF THE POST, AND SHALL CONFORM TO ASTM F626.

CONCRETE REQUIRED FOR THE EMBEDMENT OF ALL POSTS SHALL NOT BE PAID FOR DIRECTLY BUT SHALL BE INCLUDED IN THE CONTRACT UNIT PRICE BID FOR CHAIN LINK FENCE.

POSTS SHALL BE SPACED EQUIDISTANT ON A MAXIMUM OF 10' CENTERS.

EXCAVATION FOR POSTS: IN OTHER THAN ROCK SHALL BE OF THE DIMENSIONS INDICATED. IF ROCK IS ENCOUNTERED BEFORE REACHING THE REQUIRED DEPTH, THE EXCAVATION SHALL BE CONTINUED TO THE DEPTH INDICATED OR 1'-6" INTO THE ROCK, WHICHEVER IS LESS, AND SHALL BE A MINIMUM OF 8 INCHES IN DIAMETER.

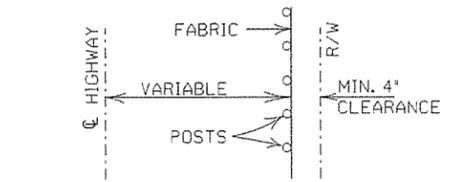

INSTALLATION MAY BE MODIFIED AS SHOWN IN THE PLANS

POSTS AND RAILS

SIZE O.D.	GRADE 1 AND ALUMINUM ALLOY				GRADE 2		
	O.D. INCHES	WALL THICKNESS	STEEL LBS. PER LINEAR FT.	ALUMINUM LBS. PER LINEAR FT.	O.D. INCHES	WALL THICKNESS	LBS. PER LINEAR FT.
1 1/2"	1.660	0.140	2.27	0.786	1.660	0.111	1.84
2"	1.900	0.145	2.72	0.940	1.900	0.120	2.28
2 1/2"	2.375	0.154	3.65	1.264	2.375	0.130	3.11
3"	2.875	0.203	5.79	2.004	2.875	0.160	4.64
3 1/2"	3.500	0.216	7.56	2.621	3.500	0.160	5.71
4"	4.000	0.226	9.11	3.151	4.000	0.160	6.56

TOLERANCES ON DIMENSIONS AND WEIGHTS ACCORDING TO AASHTO M 181


DATE	REVISION	FILMED
11-17-10	REVISED TRUSS ROD	
12-10-09	REVISED POSTS & RAILS TABLE	
5-21-09	ADDED TABLE & GEN. NOTE (C)	
8-22-02	REVISED NOTES, REMOVED TABLE, & REMOVED FENCE ALTERNATE	
4-3-97	REVISED BRACE RAIL NOTE	
10-18-96	REVISED AASHTO & ASTM REF.	
11-3-94	REVISED NOTE (L)	
10-1-92	DELETED ALTERNATE POST	10-1-92
8-15-91	DELETED ROLL FORMED POST DETAIL & ADDED NOTE	8-15-91
8-15-91	DELETED CLASS CONCRETE	8-15-91
11-30-89	DELETED CLASS CONCRETE	11-30-89
11-17-88	REVISED O.D. SIZES	668-11-17-88
10-30-87	GENERAL REVISIONS	548-10-30-87
4-20-79	REVISED TOP RAIL & TENSION WIRE	695-4-20-79
10-2-72	REVISED AND REDRAWN	530-10-2-72

ARKANSAS STATE HIGHWAY COMMISSION

CHAIN LINK FENCE

STANDARD DRAWING WF-3

GENERAL NOTES FOR DETECTABLE WARNING DEVICES
 THE DETECTABLE WARNING DEVICE SHALL BE LOCATED SO THAT THE NEAREST EDGE OF THE DEVICE IS 6 TO 8 INCHES FROM THE FACE OF THE CURB. TRUNCATED DOMES IN THE DETECTABLE WARNING SURFACE SHALL MEET THE REQUIREMENTS OF THE GEOMETRIC CONFIGURATION SHOWN. DOMES SHALL BE ALIGNED ON A SQUARE GRID IN THE PREDOMINANT DIRECTION OF TRAVEL TO PERMIT WHEELS TO ROLL BETWEEN DOMES. DETECTABLE WARNING DEVICE SHALL BE 24 INCHES IN THE DIRECTION OF TRAVEL AND EXTEND THE FULL WIDTH OF THE CURB RAMP OR FLUSH SURFACE. DETECTABLE WARNING DEVICE SHALL BE ON THE AHTD QUALIFIED PRODUCTS LIST FOR CAST-IN-PLACE TACTILE PANELS (ADA DETECTABLE WARNING).

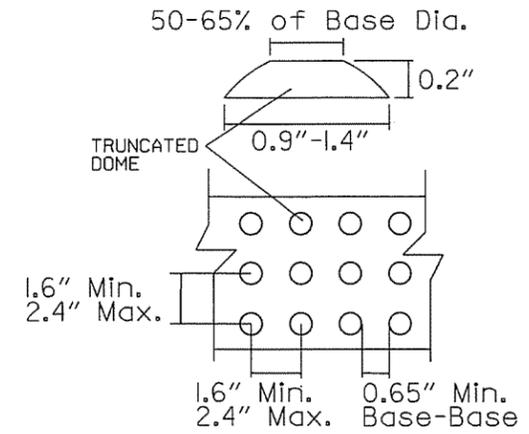

DETECTABLE WARNING DEVICE DETAIL

GENERAL NOTES:
 IN ALTERATIONS WHEELCHAIR RAMPS ARE TO BE PROVIDED AT CURBED STREET INTERSECTIONS WITH PEDESTRIAN TRAFFIC AND MID-BLOCK CROSSWALK LOCATIONS. THE LENGTH OF THE RAMP SHALL BE SUCH THAT THE SLOPE DOES NOT EXCEED 12:1. THE SURFACE TEXTURE OF THE RAMP SHALL CONFORM TO A CLASS 6 FINISH ACCORDING TO SECTION 802.19. THE NORMAL GUTTER GRADE SHALL BE MAINTAINED THROUGH THE AREA OF THE RAMP. ALL PAVEMENT MARKINGS SHALL BE IN ACCORDANCE WITH THE LATEST EDITION OF THE MANUAL OF UNIFORM TRAFFIC CONTROL DEVICES PUBLISHED BY THE FEDERAL HIGHWAY ADMINISTRATION. THE MINIMUM THICKNESS OF THE RAMP, WALK, & LANDING SHALL BE 4". THE MINIMUM WIDTH OF THE RAMPS SHALL BE THE EXISTING WALK WIDTH OR 36", WHICHEVER IS GREATER. MINOR MODIFICATIONS OF THESE DETAILS, AS APPROVED BY THE ENGINEER, MAY BE MADE TO ADJUST TO LOCAL CONDITIONS.


NOTE: THE CROSS SLOPE OF THE RAMPS AND SIDEWALKS SHALL NOT EXCEED 2.0% UNLESS REQUIRED TO MATCH STREET LONGITUDINAL GRADE.

RAMP SELECTION CRITERIA


FIRST CHOICE	TYPE 1	CORNER LOCATIONS WITH THE WALK ADJACENT TO THE CURB (BOTH NEW CONSTRUCTION AND ALTERATIONS).
	TYPE 2	CORNER LOCATIONS WITH THE WALK OFFSET FROM THE CURB A DISTANCE INSUFFICIENT TO ALLOW THE REQUIRED RAMP SLOPE (BOTH NEW CONSTRUCTION AND ALTERATIONS).
	TYPE 3	CORNER LOCATIONS WITH THE WALK OFFSET FROM THE CURB A DISTANCE SUFFICIENT TO ALLOW THE REQUIRED RAMP SLOPE (BOTH NEW CONSTRUCTION AND ALTERATIONS).
	TYPE 4	TANGENT LOCATIONS (BOTH NEW CONSTRUCTION AND ALTERATIONS).
SECOND CHOICE	TYPE 5	TANGENT LOCATIONS (ALTERATIONS ONLY).
THIRD CHOICE	TYPE 6	CORNER LOCATIONS (ALTERATIONS ONLY). THIS RAMP MAY BE USED ONLY IF THE TYPE 5 RAMPS CANNOT BE PLACED AT THE ENDS OF THE RADIUS.
FOURTH CHOICE		IF SITE CONSTRAINTS PREVENT THE CONSTRUCTION OF ANY OF THE TYPES LISTED, THEN AND ONLY THEN CAN THE 12:1 MAX. SLOPE ON THE RAMP BE EXCEEDED TO PROVIDE ACCESS TO THE STREET LEVEL (ALTERATIONS ONLY). THE SLOPE CAN BE STEEPENED TO A 10:1 MAX. FOR A MAX. LENGTH OF 5' OR A 8:1 MAX. FOR A MAX. LENGTH OF 2'. SLOPES STEEPER THAN 8:1 ARE NOT ALLOWED UNDER ANY CIRCUMSTANCES.

NOTE: IN ALTERATIONS, THE SELECTION OF THE TYPE OF WHEELCHAIR RAMP TO BE CONSTRUCTED SHALL BE BASED ON THE AMOUNT OF RIGHT-OF-WAY AVAILABLE, AND ON THE PRESENCE OF OTHER SITE CONSTRAINTS (UTILITIES, BUILDINGS, ETC.). THE TABLE ABOVE LISTS THE ORDER IN WHICH THE RAMPS ARE TO BE CONSIDERED.

AN ALTERATION IS DEFINED AS A PROJECT THAT CHANGES OR AFFECTS THE USE OF A PEDESTRIAN PATHWAY (OVERLAYS, SIGNALIZATION PROJECTS, ETC.) BUT DOES NOT REQUIRE THE PURCHASE OF ADDITIONAL RIGHT-OF-WAY. ALL PROJECTS THAT REQUIRE THE PURCHASE OF ADDITIONAL RIGHT-OF-WAY WILL USUALLY BE CONSIDERED NEW CONSTRUCTION FOR THE PURPOSES OF THE CHART ABOVE.

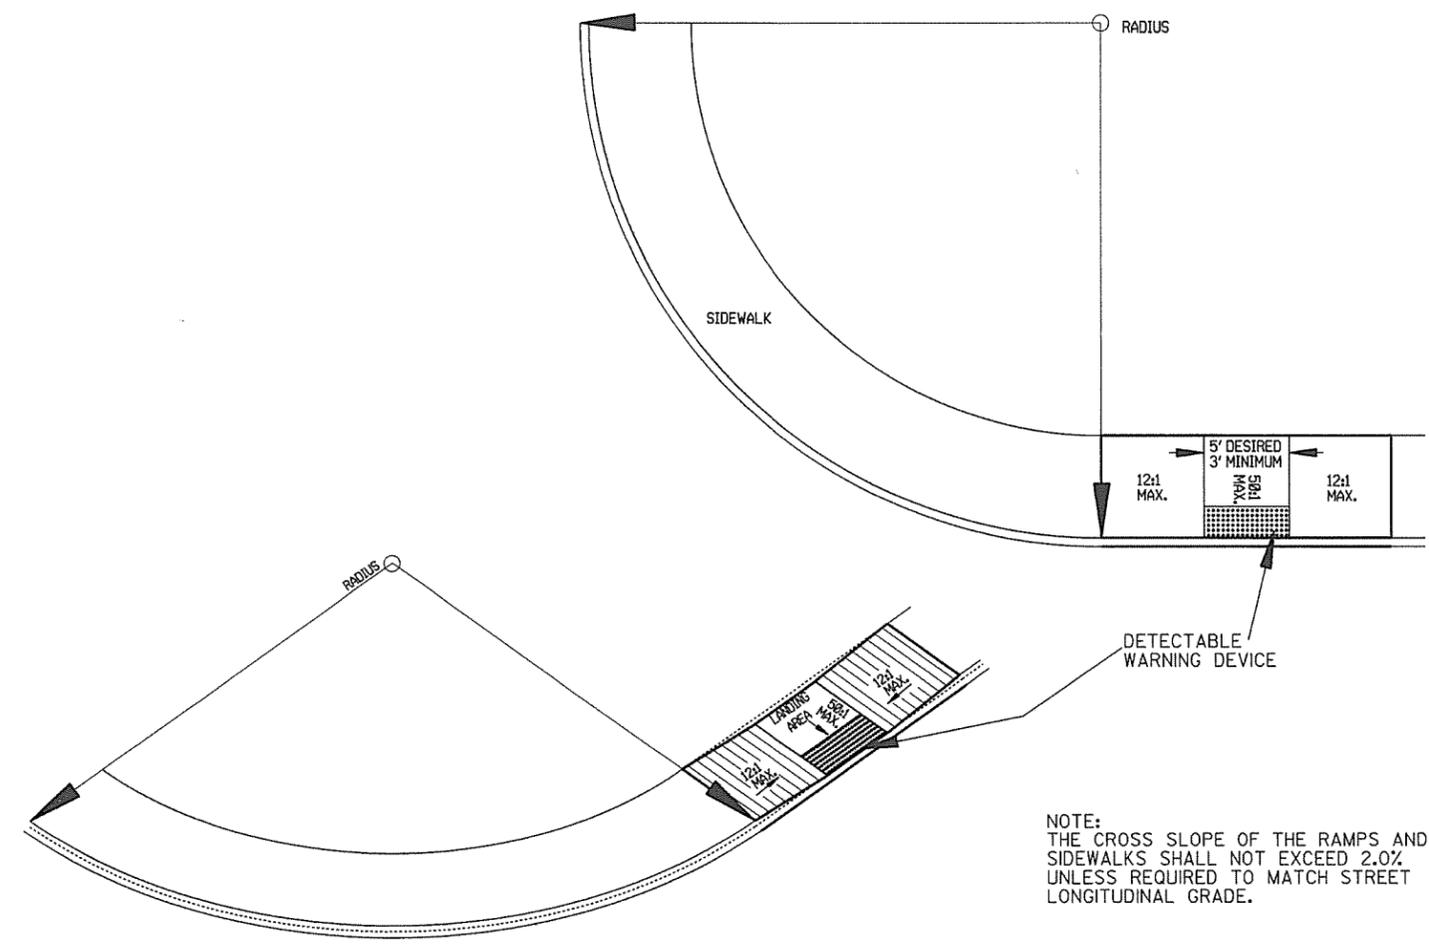

TYPE 5 RAMP

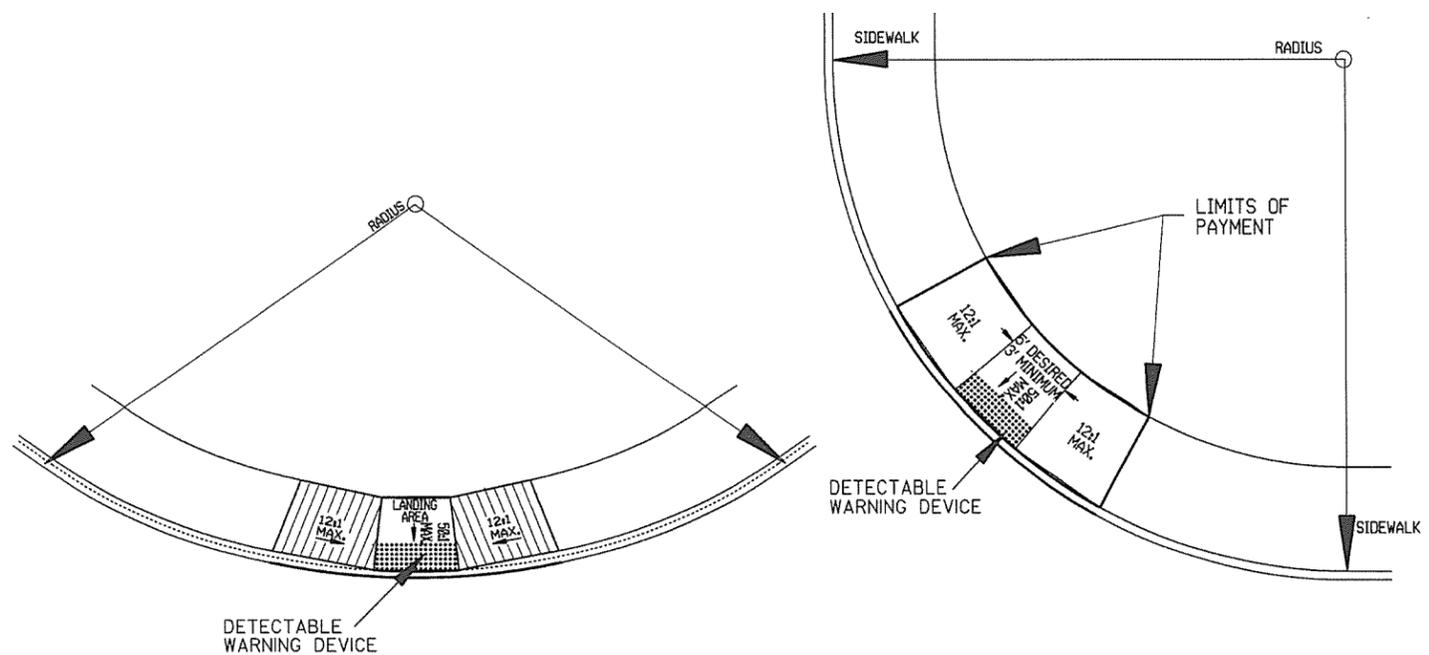

TYPE 6 RAMP

			ARKANSAS STATE HIGHWAY COMMISSION
10-9-03	REVISED GENERAL NOTES & ADDED NOTE.	10-07-03	WHEELCHAIR RAMPS ALTERATIONS ONLY
4-10-03	REVISED DETECTABLE WARNING DEVICE DETAIL		
8-22-02	ADDED DETECTABLE WARNING DEVICES DETAILS		STANDARD DRAWING WR-2
11-18-98	REV. FOURTH CHOICE NOTE		
8-12-98	REVISED TEXTURE		
7-02-98	ISSUED		
DATE	REVISION	DATE	FILM


ABBREVIATIONS

& - AND
 ∟ - ANGLE
 @ - AT
 A.B. - ANCHOR BOLT
 A/C - AIR CONDITIONING
 AC., ACOUS. - ACOUSTICAL - ACOUST.
 ACT - ACOUSTICAL CEILING TILE
 AT - ACOUSTICAL TILE
 ADJ., - ADJUST - ADJUSTABLE
 A.F.F. - ABOVE FLOOR FINISH
 AL. - ALUM. - ALUMINUM
 ALT. - ALTERNATE
 AP - ACCESS PANEL
 APPROX. - APPROXIMATELY
 B., BOT - BOTTOM
 BD. - BOARD
 BITUM - BITUMINOUS
 BL. - BUILDING LINE
 BLDG. - BUILDING
 BLK. - BLOCK, BLKG. - BLOCKING
 BM., B.M. - BEAM, BENCH MARK
 B.O.F. - BOTTOM OF FOOTING
 BOT. - BOTTOM
 B.P. - BASE PLATE
 BR. - BEDROOM
 BRKT. - BRACKET
 B.S. - BOTH SIDES
 B/U., B.U. - BUILT UP
 B.W. - BOTH WAYS
 [- CHANNEL
 CL - CENTERLINE
 CAB. - CABINET
 CAP. - CAPACITY
 CEM. - CEMENT
 CER. - CERAMIC
 C.F./C.I. - CONTRACTOR FURNISHED/
 CONTRACTOR INSTALLED
 C.H. - COAT HOOK
 CHAM. - CHAMFER
 CHAN. - CHANNEL
 C.I. - CAST IRON
 C.I.P. - CAST IRON PIPE
 C.J. - CONTROL JOINT
 C.L. - CENTER LINE
 CLR. - CLEAR, COLOR
 CLEAN'G. - CLEANING
 CLG. - CEILING
 CLK. - CLOCK
 CLKG. - CAULKING
 C.M.U. - CONCRETE MASONRY UNIT
 C.O. - CLEANOUT
 COL. - COLUMN
 CONC. - CONCRETE
 CONST. - CONSTRUCTION
 CONT. - CONTINUOUS
 CONTR. - CONTRACT (OR CONTRACTION)
 CPT. - CARPET
 C.T. - CERAMIC TILE
 CTG. - COATING
 C.W. - COLD WATER
 DET. - DETAIL
 DIA. - DIAMETER
 DIAG. - DIAGONAL, DIAGRAM
 DIM. - DIMENSION
 DISP. - DISPENSER
 D.L. - DEAD LOAD
 DN. - DOWN
 DR. - DOOR
 D.S. - DOWNSPOUT
 DBL. - DOUBLE
 EA. - EACH
 E.F. - EACH FACE
 E.J., EXP. JT. - EXPANSION JOINT
 EL. - ELEVATION
 ELAST. - ELASTOMERIC
 ELEC. - ELECTRICAL
 ELEV. - ELEVATION "VIEW", ELEVATOR
 EQ. - EQUAL
 EQUIP. - EQUIPMENT
 E.W. - EACH WAY
 E.W.C. - ELECTRIC WATER COOLER
 E.W.H. - ELECTRIC WATER HEATER
 EXH. - EXHAUST
 EXIST. - EXISTING
 EXP. - EXPANSION
 EXT. - EXTERIOR
 F.A. - FRESH AIR
 F.A.P. - FIRE ALARM PANEL
 F.C.U. - FAN COIL UNIT
 F.D. - FLOOR DRAIN, FIRE DAMPER
 FDN., FOUND - FOUNDATION
 F.E. - FIRE EXTINGUISHER
 F.E.C. - FIRE EXTINGUISHER CABINET
 FED. - FEDERAL
 F.F.EL. - FINISH FLOOR ELEVATION
 F.G. - FINISH GRADE
 F.H.C. - FIRE HOSE CABINET
 FIG. - FIGURE
 FIN. - FINISH (ED) (ES)
 FL., FLR. - FLOOR
 FL., FLASH'G - FLASHING
 FLUOR. - FLUORESCENT
 F.O.B. - FACE OF BRICK
 FR. - FRAME
 FT. - FOOT, FEET, FT. - SQ. FT.
 FTG. - FOOTING
 FUR. - FURNACE
 FURN. - FURNITURE
 FURRG. - FURRING
 G - GAS
 G.A. - GAGE
 GALV. - GALVANIZED, GALVD. - GALVANIZED
 G.B. - GRAB BARS - GYPSUM WALLBOARD
 GL. - GLASS
 GF/CI - GOVERNMENT FURNISHED/CONTRACTOR INSTALLED
 GF/GI - GOVERNMENT FURNISHED/GOVERNMENT INSTALLED
 GR. - GRADE
 GRD. - GROUND
 G.T. - GREASE TRAP
 G.W.B. - GYPSUM WALL BOARD
 GYP. - GYPSUM
 GYP. BD. - GYPSUM BOARD
 G.B. - GYPSUM BOARD
 GAL. - GALLON
 H., HGT., HT. - HEIGHT
 H.B. - HOSE BIBB
 H.M. - HOLLOW METAL
 HORIZ. - HORIZONTAL
 HR. - HOUR
 HTG. - HEATING
 H.W. - HOT WATER
 HW., HDW., H'DWARE - HARDWARE
 HDWE. - HARDWARE
 I.D. - INSIDE DIAMETER, INSIDE DIMENSION, IDENTIFICATION
 IN. - INCH
 INS., INSUL. - INSULAT (ION), (ED)
 INT. - INTERIOR
 INV. - INVERT
 JAN. - JANITOR'S CLOSET
 JT. - JOINT
 JST. - JOIST
 JSTS. - JOISTS
 K.O. - KNOCKOUT
 K.P.L. - KICK PLATE
 L. - ANGLE
 LOUV., LVR. - LOUVRE (R), (RED)
 LAV. - LAVATORY
 LBS. - POUNDS, LB. - POUND
 LG. - LONG, LENGTH
 L.H. - LEFT HAND
 L.L. - LIVE LOAD
 LT. - LIGHT
 LTG. - LIGHTING
 m - METER
 mm - MILLIMETER
 MACH. - MACHINE
 MAINT. - MAINTENANCE
 MAS. - MASONRY
 MAT., MAT'L - MATERIAL
 MAX. - MAXIMUM
 M.C. - MEDICINE CABINET
 M.D.P. - MAIN DISTRIBUTION PANEL
 MECH. - MECHANICAL, MECHL. - MECHANICAL
 MEZZ. - MEZZANNE
 MET., MAT'L - METAL
 MFR. - MANUFACTURER, MFG. - MANUFACTURER
 MFRD. - MANUFACTURED
 M.G. - MIRROR GLASS
 J.H. - MANHOLE
 MIN. - MINIMUM, MINUTE
 MISC. - MISCELLANEOUS
 MK. - MARK
 M.O. - MASONRY OPENINGS
 M.T. - METAL THRESHOLD
 MULL. - MULLION
 M.W.P. - MEMBRANE WATERPROOFING
 N. - NORTH
 N.C. - NON-CORROSIVE
 N.I.C. - NOT IN CONTRACT
 NO. - NUMBER
 NOM. - NOMINAL
 N.T.S. - NOT TO SCALE
 O.A. - OUTSIDE AIR
 O.C. - ON CENTER (S)
 O.C.E.W. - ON CENTER EACH WAY
 O.D. - OUTSIDE DIAMETER
 OFF. - OFFICE
 O.H. - OVERHEAD, OPPOSITE HAND
 OHE - OVERHEAD ELECTRIC
 O.J. - OPEN JOISTED
 OP'G., OPNG. - OPENING
 OPP. - OPPOSITE
 O.R. - OUTSIDE RADIUS
 OZ. - OUNCES
 P. - POLE, PHASE, PIPE
 PARA. - PARAGRAPH
 PART (N) - PARTITION, PTN. - PARTITION
 PCT. - PERCENT
 P. LAM - PLASTIC LAMINATE
 PL., P - PLATE, PLACE
 PLAS. - PLASTER, PLAST., - PLASTER
 PLAS. LAM. - PLASTIC LAMINATE
 PLYWD. - PLYWOOD
 PNL. - PANEL, PNLS. - PANELS
 PR. - PAIR
 PREC. - PRECAST
 PRELIM. - PRELIMINARY
 P.S.F. - POUNDS PER SQUARE FOOT
 P.S.I. - POUNDS PER SQUARE INCH
 P.T.D. - PAPER TOWEL DISPENSER
 QTR. - QUARTER
 QTY. - QUANTITY
 R. - RADIUS, RISER
 R.A. - RETURN AIR
 RAD. - RADIUS
 R.A.G. - RETURN AIR GRILLE
 R.C.P. - REINFORCED CONCRETE PIPE
 R.D. - ROOF DRAIN
 RECP. - RECEPTACLE
 REF. - REFERENCE
 REG. - REGULATOR, REGISTER
 REINF. - REINFORCE (D), (MENT)
 REQ'D. - REQUIRED
 RES. - RESILIENT TILE
 RESIL. - RESILIENT
 RET. - RETAINING
 REV. - REVISION
 R.H. - ROUND HEAD, ROUND HOLE, ROBE HOOK,
 RIGHT HAND
 RM.(S) - ROOM (S)
 R.O. - ROUGH OPENING
 SAN. - SANITARY
 S.B. - SPLASH BLOCK
 S.C. - SOLID CORE, SHOWER CURTAIN
 SCH., SCHED. - SCHEDULE
 SCR., S.C.R. - SCREEN, SHOWER CURTAIN RAIL
 S.D. - SOAP DISPENSER
 SECT. - SECTION
 SEP. - SEPARATE
 SERV. - SERVICE
 S.G. - SEMI GLOSS
 S.G.R. - SOAP AND GRAB BAR COMBINATION ON
 (RECESSED)
 S.G.S. - SOAP AND GRAB BAR COMBINATION (SURFACE)
 S.H. - SOAP HOLDER
 SH. - SHEET
 SHV. - SHELF, SHELVES
 SIM. - SIMILAR
 S.N.D. - SANITARY NAPKIN DISPENSER
 S.N.T.D. - SANITARY NAPKIN & TAMPON DISPOSER
 SP. - SPACES
 SPEC. (S) - SPECIFICATIONS
 SQ. - SQUARE
 S.S. - SANITARY SEWER, STAINLESS STEEL
 STA. - STATION
 STC - SOUND TRANSMISSION CLASS
 STL. - STEEL
 STOR., ST. - STORAGE
 STD. - STANDARD
 STRUCT. - STRUCTURAL - STRUCT'L
 STS - STORM SEWER
 SUS., SUSP. - SUSPENDED
 SYM. - SYMBOL
 SYS. - SYSTEM
 SHT. - SHEET
 SSMR - STANDING SEAM METAL ROOF
 T. - TILE, TOP, TANGENT, TREAD, TOILET, TELEPHONE
 T & B - TOP AND BOTTOM
 T & G - TONGUE AND GROOVE
 T.B. - TOWEL BAR
 T.C. - TOP OF CURB
 T.D. - TILE DRAIN
 TEL. - TELEPHONE
 TEMP. - TEMPERATURE, TEMPORARY, TEMPERED
 THK. - THICK
 THRSLD. - THRESHOLD
 T.O.B. - TOP OF BEAM
 T.O.M. - TOP OF MASONRY
 T.O.S. - TOP OF STEEL
 T.S. - TOP OF STEEL, TOP OF STONE
 T.T.D. - TOILET TISSUE DISPENSER
 T.V.B. - TELEVISION BRACKET
 T.W. - TOP OF WALL
 TYP. - TYPICAL
 U.G. - UNDERGROUND
 UGT - UNDERGROUND TELEPHONE
 U.H. - UNIT HEATER
 U.N.O. - UNLESS NOTED OTHERWISE
 V. - VENT
 V.C.T. - VINYL COMPOSITION TILE
 VENT. - VENTILATING
 VERT. - VERTICAL (LY)
 VEST. - VESTIBULE
 V.T.R. - VENT THROUGH ROOF
 V.W.C. - VINYL WALL COVERING
 W. - WITH
 W/O - WITHOUT
 W. - WIDTH, WATER
 WAINS. - WAINSCOT
 W.C. - WATER CLOSET
 W.D. - WOOD DOOR, WINDOW DIMENSION, WOOD
 W.I.F.S. - WALL INSUL. & FINISH SYSTEM (S)
 WDW. - WINDOW
 W.G. - WIRE GLASS
 W.P. - WATERPROOF, WEATHERPROOF
 WT. - WEIGHT
 WTR. - WATER
 W.W.F. - WELDED WIRE FABRIC
 W.M.P. - WIRE MESH PARTITION

GENERAL NOTES

- EACH TRADE IS ADVISED THAT INFORMATION PERTINENT TO ITS WORK MAY OCCUR IN VARIOUS SECTIONS OF THE CONTRACT DOCUMENTS. REFER TO EVERY SHEET OF DRAWINGS FOR NOTES, ABBREVIATIONS AND SYMBOLS. NOTES SHALL BE REVIEWED AND APPLIED TO RELATED BUILDING COMPONENTS REGARDLESS OF THEIR LOCATIONS IN THE DRAWINGS AND SPECIFICATIONS.
- UNLESS NOTED OTHERWISE, ANY NOTE, DETAILS, OR FEATURE INDICATED FOR ONE CONDITION SHALL BE APPLICABLE FOR ALL ALIKE AND SIMILAR CONDITIONS.
- THE CONTRACTOR SHALL FURNISH AND INSTALL ALL STIFFENERS, BRACING, BACKING PLATES AND SUPPORTING BRACKETS REQUIRED FOR THE PROPER INSTALLATION OF ALL BUILDING COMPONENTS AS RECOMMENDED BY THE MANUFACTURER AND REQUIRED BY CODE.
- ALL DISSIMILAR METALS SHALL BE EFFECTIVELY ISOLATED FROM EACH OTHER TO AVOID MOLECULAR BREAKDOWN.
- ALL EXTERIOR JOINTS AROUND WINDOW AND DOOR FRAMES, BETWEEN WALLS AND FOUNDATION, BETWEEN WALLS AND ROOF, BETWEEN WALL PANELS, AT PENETRATION OF UTILITIES THROUGH THE ENVELOPE, SHALL BE SEALED OR WEATHER-STRIPPED TO PREVENT AIR AND MOISTURE LEAKAGE AND INFILTRATION.
- INTERIOR PARTITIONS ARE DIMENSIONED TO FACE OF STUD, UNLESS NOTED OTHERWISE. DO NOT SCALE DRAWINGS. QUESTIONS REGARDING DIMENSIONS SHALL BE REPORTED TO ARCHITECT.


DRAFTING SYMBOLS

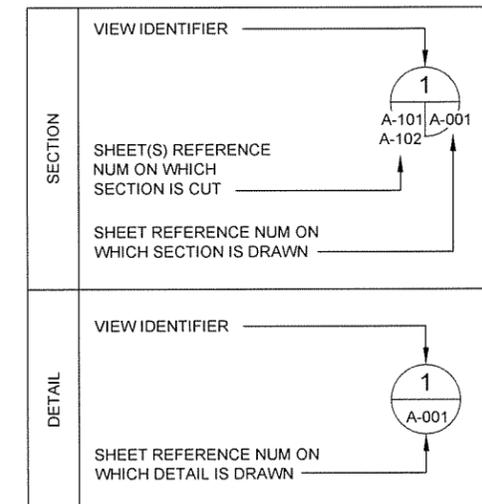

MATERIAL LEGEND

- COMPACTED FILL
- EARTH (EXISTING GRADE)
- STONE, RUBBLE, GRAVEL
- CONCRETE
- BRICK
- CONCRETE MASONRY UNIT
- THERMAL INSULATION
- ACOUSTICAL MATERIAL
- BATT INSULATION
- RIGID INSULATION
- SAND
- WOOD (FINISH)
- METAL
- WOOD (DIMENSIONED LUMBER AND BLOCKING)
- PLASTER, CEMENT AND GROUT
- PLYWOOD
- FIRE RATED GYPSUM BOARD CEILING

REFERENCE SYMBOLS

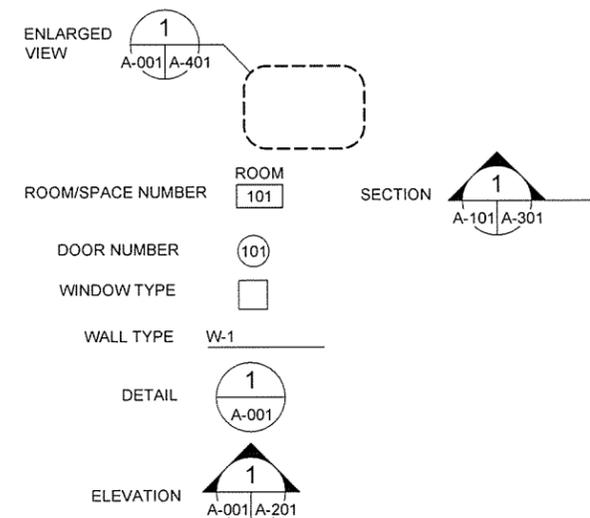

JRR	Appr.
10/1/15	Date
ISSUED FOR CONSTRUCTION	Description
IFC	Symbol

Job Number	060451	N/A	N/A	N/A
Submitted by	John T. Watkins, III, PE, SE Director, Federal Services	Plot Scale	1:1	Draw Date
Drawn by	J. RAMSEY	Plot Date	10/1/15	Draw Code
Checked by	G. ARCHER	File Name	AHS15VR-A-001.DWG	

ARKANSAS HIGHWAY AND TRANSPORTATION DEPARTMENT
 ARKANSAS TOURIST INFORMATION CENTER
 (WHITE RIVER) (S)
 JOB 061451
 GENERAL NOTES & LEGEND

Sheet Reference Number:
A-001
 Sheet 29 of 130

AHTD TOURIST INFORMATION CENTER ROOM FINISH SCHEDULE														
RM NO.	ROOM NAME	FLOOR		WALL (NORTH)		WALL (EAST)		WALL (SOUTH)		WALL (WEST)		CEILING		REMARKS (SEE NOTES BELOW)
		MAT		MAT	FIN	MAT	FIN	MAT	FIN	MAT	FIN	MAT	FIN	
TOURIST INFORMATION CENTER														
101	LOBBY	T1	T2	TILE	T2	TILE	T2	STORE FRONT	N/A	TILE	T2	GYP BD	PT5	18' - 0" (+)
102	VENDING	T1	T2	TILE	T2	TILE	T2	TILE	T2	TILE	T2	GYP BD	PT5	18' - 0" (+)
103	CHASE	CONC/CS1	NONE	CMU	EXPOSED	CMU	EXPOSED	CMU	EXPOSED	CMU	EXPOSED	EXPOSED	NONE	N/A
104	WOMEN	CONC	ECS3	CMU	ECS1,ECS2	CMU	ECS1,ECS2	CMU	ECS1,ECS2	CMU	ECS1,ECS2	GYP BD	ECS4	9' - 1 7/8" VARIES AT VAULTED CLG
105	CHASE	CONC/CS1	NONE	CMU	PT1	CMU	PT1	CMU	PT1	CMU	PT1	EXPOSED	NONE	N/A
106	MEN	ECS3	ECS3	CMU	ECS1,ECS2	CMU	ECS1,ECS2	CMU	ECS1,ECS2	CMU	ECS1,ECS2	GYP BD	ECS4	9' - 1 7/8" VARIES AT VAULTED CLG
107	CHASE	CONC/CS1	NONE	CMU	PT1	CMU	PT1	CMU	PT1	CMU	PT1	EXPOSED	NONE	N/A
108	CORRIDOR	T1	N/A	CMU	WV1	CMU	T2	CMU	WV1	CMU	WV1	GYP BD	PT4	9' - 1 7/8"
109	CORRIDOR	T1	N/A	CMU	WV1	CMU	WV1	CMU	WV1	CMU	T2	GYP BD	PT4	9' - 1 7/8"
110	CHASE	CONC/CS1	NONE	CMU	WV1	CMU	PT1	CMU	PT1	CMU	PT1	EXPOSED	NONE	N/A
111	MEN	ECS3	ECS3	CMU	ECS1,ECS2	CMU	ECS1,ECS2	CMU	ECS1,ECS2	CMU	ECS1,ECS2	GYP BD	ECS4	9' - 1 7/8" VARIES AT VAULTED CLG
112	CHASE	CONC/CS1	NONE	CMU	PT1	CMU	PT1	CMU	PT1	CMU	PT1	EXPOSED	NONE	N/A
113	COMM	CONC	NONE	CMU	PT1	CMU	PT1	CMU	PT1	CMU	PT1	GYP BD	PT4	9' - 1 7/8"
114	WOMEN	ECS3	ECS3	CMU	ECS1,ECS2	CMU	ECS1,ECS2	CMU	ECS1,ECS2	CMU	ECS1,ECS2	GYP BD	ECS4	9' - 1 7/8" VARIES AT VAULTED CLG
115	CHASE	CONC/CS1	NONE	CMU	PT1	CMU	PT1	CMU	PT1	CMU	PT1	EXPOSED	NONE	N/A
MAINTENANCE BUILDING														
201	MAINTENANCE	CONC/CS1	NONE	CMU	PT1	CMU	PT1	CMU	PT1	CMU	PT1	GYP BD	PT4	9' - 10 1/2"
202	FLAM. STORAGE	CONC/CS1	NONE	CMU	PT1	CMU	PT1	CMU	PT1	CMU	PT1	GYP BD	PT4	9' - 10 1/2"
TRUCKER- VENDING BUILDING														
301	WOMEN	ECS3	ECS3	CMU	ECS1,ECS2	CMU	ECS1,ECS2	CMU	ECS1,ECS2	CMU	ECS1,ECS2	GYP BD	ECS4	9' - 10 1/2"
302	CHASE	CONC/CS1	NONE	CMU	PT1	CMU	PT1	CMU	PT1	CMU	PT1	EXPOSED	NONE	N/A
303	MEN	ECS3	ECS3	CMU	ECS1,ECS2	CMU	ECS1,ECS2	CMU	ECS1,ECS2	CMU	ECS1,ECS2	GYP BD	ECS4	9' - 10 1/2"
304	VENDING	N/A	N/A	N/A	N/A	N/A	N/A	N/A	N/A	N/A	N/A	N/A	N/A	N/A
305	COVERED ENTRY	N/A	N/A	N/A	N/A	N/A	N/A	N/A	N/A	N/A	N/A	N/A	N/A	N/A

AHTD TOURIST INFORMATION CENTER EXTERIOR MATERIAL FINISH AND COLOR LEGEND					
SYMBOL	MATERIAL	*BASIS OF DESIGN MANUFACTURER	MODEL NO. SIZE	MODEL NAME	COLOR
EPT1	HM DOOR PAINT	SHERWIN WILLIAMS	N/A	PRO INDUSTRIAL ACRYLIC	DORIAN GRAY SW 7019
EPT2	HM DOOR FRAME PAINT	SHERWIN WILLIAMS	N/A	PRO INDUSTRIAL ACRYLIC	RIPE OLIVE SW 6209
SW1	MANUFACTURED STONE WAINSCOT	ARRISCRAFT	VARIES	OLD COUNTRY	SMOKEY MOUNTAIN
SW2	MANUFACTURED STONE ACCENT CAP	ARRISCRAFT	6-1/2" x 4-5/8" - SEE DETAIL 2/A-006	OLD COUNTRY	GRAY
GL1	GLAZING	PPG	N/A	SOLARBAN 60	SOLARGRAY
GL2	GLAZING-OBSURE	PPG	N/A	SOLARBAN 60	SOLARGRAY
MOR1	MORTAR FOR STONE WAINSCOT/WALL	LAFARGE	GRAY	TYPE N PORTLAND	NATURAL GRAY
OHD1	OVERHEAD SECTIONAL DOOR	OVERHEAD DOOR	SERIES 418	SERIES 418 FLUSH	WHITE
MT1	METAL TRIM, FASCIA	BERRIDGE	N/A	N/A	HARTFORD GREEN
MT2	METAL TRIM, PANEL	CENTRIA	W-10A	FLUOROFINISH (PVDF)	133 SANDSTONE
MS1	METAL SIDING	BERRIDGE	12" PANEL, 24 GA.	HS-12	PARCHMENT
RP1	ROOF PANEL	BERRIDGE	16" PANEL, 24 GA.	DOUBLE ZEE-LOCK	HARTFORD GREEN
SF1	ALUMINUM STOREFRONT	EFCO	8" X 2-1/2"	5600 SERIES	CLEAR ANODIZED
SP1	METAL SOFFIT PANEL- PERFORATED	BERRIDGE	12 PANEL, 24 GA	FW-12- VENTED	HARTFORD GREEN
VG1	VENDING GATE	SHERWIN WILLIAMS	N/A	PRO INDUSTRIAL ACRYLIC	URBAN BRONZE 7048
WD1	ALUMINUM WINDOWS	EFCO	5" x 2-1/2"	5600 SERIES	CLEAR ANODIZED
* OR APPROVED EQUAL					

AHTD TOURIST INFORMATION CENTER MATERIAL FINISH AND COLOR LEGEND					
SYMBOL	MATERIAL	*BASIS OF DESIGN MANUFACTURER	MODEL NO. SIZE	MODEL NAME	COLOR
CS1	CONCRETE SEALER	H&C	N/A	HIGH PERFORMANCE	CLEAR
ECS1	COATING SYSTEM-WALL	NOTE 1.	NOTE 1.	NOTE 1.	NOTE 1.
ECS2	COATING SYSTEM-WALL	NOTE 1.	NOTE 1.	NOTE 1.	NOTE 1.
ECS3	COATING SYSTEM-FLOOR	NOTE 1.	NOTE 1.	NOTE 1.	NOTE 1.
ECS4	COATING SYSTEM-CEILING	NOTE 1.	NOTE 1.	NOTE 1.	NOTE 1.
G1	FLOOR GROUT	CUSTOM BUILDING PROD	N/A	FUSION	TRUFFLE #540
G2	WALL GROUT	CUSTOM BUILDING PROD	N/A	FUSION	DRIFTWOOD #543
PT1	WALL PAINT	SHERWIN WILLIAMS	N/A	PRO INDUSTRIAL ACRYLIC	DORIAN GRAY SW 7019
PT2	HM DOOR PAINT	SHERWIN WILLIAMS	N/A	PRO INDUSTRIAL ACRYLIC	GAUNTLET GRAY SW 7019
PT3	HM FRAME PAINT	SHERWIN WILLIAMS	N/A	PRO INDUSTRIAL ACRYLIC	URBAN BRONZE SW 7048
PT4	CEILING PAINT	SHERWIN WILLIAMS	N/A	PRO INDUSTRIAL ACRYLIC	ROCK CANDY SW 6231
PT5	CEILING PAINT	SHERWIN WILLIAMS	N/A	PRO INDUSTRIAL ACRYLIC	URBAN BRONZE SW 7048
PT6	METAL DOOR & FRAME PAINT	SHERWIN WILLIAMS	N/A	PRO INDUSTRIAL ACRYLIC	URBAN BRONZE SW 7048
T1	FLOOR TILE	DALTILE	8" x 48"	IMAGICA	MIDNIGHT IG98
T2	FLOOR TILE	DALTILE	4" x 48"	IMAGICA	MIDNIGHT IG98
T3	WALL TILE	DALTILE	12" x 24"	EXHIBITION	STARK WHITE EX01
T4	WALL TILE	DALTILE	12" x 24"	EXHIBITION	MODE BEIGE EX06
T5	WALL TILE	DALTILE	12" x 24"	EXHIBITION	TAILOR BEIGE EX07
TP1	TOILET PARTITION DOOR	SCRANTON	HDPE	HINY HIDERS	SHALE
TS1	TRANSITION STRIP	SCHLUETER	N/A	SCHIENE	CLEAR ANODIZED
TS2	TRANSITION STRIP	SCHLUETER	N/A	RENO-U	CLEAR ANODIZED
WV1	WALL VINYL	NOTE 2.	NOTE 2.	NOTE 2.	NOTE 2.
*OR APPROVED EQUAL					

MATERIAL AND FINISH COLOR LEGEND NOTES:

- 1.) FLOOR, WALL AND CEILING COATING SYSTEM, SEE ALLOWANCE NO. 3, SECTION 012100 ALLOWANCES
- 2.) WALL VINYL. SEE ALLOWANCE NO. 1; SECTION 012100 - ALLOWANCES




Job Number 060-051	Submitted by John T. Walters, III, P.E., SE Director, Federal Services	Plot Scale 1:1	Plot Date 10/1/15	Drwg Code	Job Name AHTDWR-4-002 DWG
IFC Symbol	ISSUED FOR CONSTRUCTION	Date	10/1/15	JRR	Apr

Designed by J. RAMSEY	Drawn by J. RAMSEY	Checked by G. ARCHER	File Name AHTDWR-4-002 DWG
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ARKANSAS HIGHWAY AND TRANSPORTATION DEPARTMENT
 ARKANSAS TOURIST INFORMATION CENTER
 (WHITE RIVER) (S)
 JOB 061451
 FINISH SCHEDULE AND MATERIAL LEGENDS


AHTD TOURIST INFORMATION CENTER - WHITE RIVER - DOOR AND FRAME SCHEDULE

DR NO.	ROOM NAME	RM NO.	SIZE	DR TYPE	DOOR		FRAME		DETAILS			STC	ATFP	FIRE LABEL	UNDE RCUT	EXIT HDW	HDW SET	REMARKS
					MAT	FIN	TYPE	MAT	FIN	HEAD	JAMB							
TOURIST INFORMATION CENTER																		
101A	LOBBY	101	6'0" x 8'0"	A	ALUM	SF1	A	ALUM	SF1	2/A-005	3/A-005	4/A-005	N/A	N/A	N/A	N/A	N/A	1
101B	LOBBY	101	7'4" x 8'0"	F	MTL	PT6	E	MTL	PT6	11/A-005	N/A	N/A	N/A	N/A	N/A	N/A	N/A	3
101C	LOBBY	101	7'4" x 8'0"	F	MTL	PT6	E	MTL	PT6	11/A-005	N/A	N/A	N/A	N/A	N/A	N/A	N/A	3
102A	VENDING	102	3'0" x 7'0"	B	ALUM	SF1	B	ALUM	SF1	6/A-007	5/A-007	8/A-007	N/A	N/A	N/A	N/A	N/A	2
102B	VENDING	102	4'4-1/4" x 7'0"	H	MTL	PT6	N/A	MTL	PT6	N/A	N/A	N/A	N/A	N/A	N/A	N/A	N/A	5
102C	VENDING	102	4'4-1/4" x 7'0"	H	MTL	PT6	N/A	MTL	PT6	N/A	N/A	N/A	N/A	N/A	N/A	N/A	N/A	5
103	CHASE	103	3'0" x 7'0"	C	HM	CUSTOM	1	HM	PT3	5/A-005	6/A-005	7/A-005	N/A	N/A	N/A	N/A	N/A	4
105	CHASE	105	3'0" x 7'0"	C	HM	CUSTOM	1	HM	PT3	5/A-005	6/A-005	7/A-005	N/A	N/A	N/A	N/A	N/A	4
107	CHASE	107	3'0" x 7'0"	C	HM	CUSTOM	1	HM	PT3	5/A-005	6/A-005	7/A-005	N/A	N/A	N/A	N/A	N/A	4
110	CHASE	110	3'0" x 7'0"	C	HM	CUSTOM	1	HM	PT3	5/A-005	6/A-005	7/A-005	N/A	N/A	N/A	N/A	N/A	4
112	CHASE	112	3'0" x 7'0"	C	HM	CUSTOM	1	HM	PT3	5/A-005	6/A-005	7/A-005	N/A	N/A	N/A	N/A	N/A	4
113	COMMUNICATIONS	113	3'0" x 7'0"	C	HM	PT2	1	HM	PT3	5/A-005	6/A-005	7/A-005	N/A	N/A	N/A	N/A	N/A	4
115	CHASE	115	3'0" x 7'0"	C	HM	CUSTOM	1	HM	PT3	5/A-005	6/A-005	7/A-005	N/A	N/A	N/A	N/A	N/A	4
MAINTENANCE BUILDING																		
201A	MAINTENANCE	201	3'0" x 7'0"	D	HM	EPT1	1	HM	EPT2	8/A-005	9/A-005	10/A-005	N/A	N/A	N/A	N/A	N/A	6
201B	MAINTENANCE	201	12'0" x 8'6"	G	MTL	WHITE	N/A	MTL	EPT2	N/A	N/A	N/A	N/A	N/A	N/A	N/A	N/A	3
202	FLAMABLE STORAGE	202	3'0" x 7'0"	E	HM	EPT1	1	HM	EPT2	8/A-005	9/A-005	10/A-005	N/A	N/A	N/A	N/A	N/A	7
TRUCKER-VENDING BUILDING																		
301	WOMEN	301	3'0" x 7'0"	D	HM	EPT1	1	HM	EPT2	8/A-005	9/A-005	10/A-005	N/A	N/A	N/A	N/A	N/A	8
302	CHASE	302	3'0" x 7'0"	D	HM	EPT1	1	HM	EPT2	8/A-005	9/A-005	10/A-005	N/A	N/A	N/A	N/A	N/A	4
303	MEN	303	3'0" x 7'0"	D	HM	EPT1	1	HM	EPT2	8/A-005	9/A-005	10/A-005	N/A	N/A	N/A	N/A	N/A	8
304A	VENDING	304	4'10" x 7'0"	J	MTL	PT6	N/A	MTL	PT6	N/A	N/A	N/A	N/A	N/A	N/A	N/A	N/A	5
304B	VENDING	304	4'10" x 7'0"	J	MTL	PT6	N/A	MTL	PT6	N/A	N/A	N/A	N/A	N/A	N/A	N/A	N/A	5
304C	VENDING	304	2'0" x 7'0"	K	MTL	PT6	N/A	MTL	PT6	N/A	N/A	N/A	N/A	N/A	N/A	N/A	N/A	5
DOOR NOTES:																		
1.) SEE SHEETS A-005 FOR SLIDING GATE DETAILS																		
2.) SEE SHEETS A-501 AND A-502 FOR VENDING SWING GATE DETAILS																		
3.) SEE SHEETS A-531 AND A-532 FOR OUTSIDE VENDING SWING GATE DETAILS																		

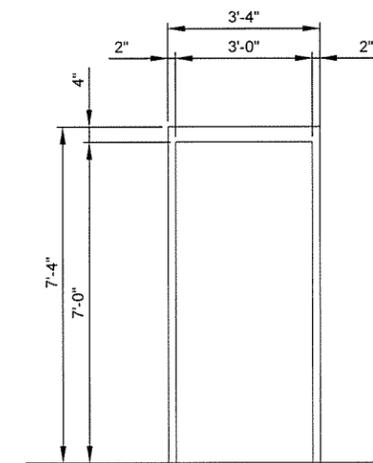


1 HOLLOW METAL FRAME - 4" HEAD


2 DOOR FRAME ELEVATIONS
SCALE: 1/2" = 1'-0"

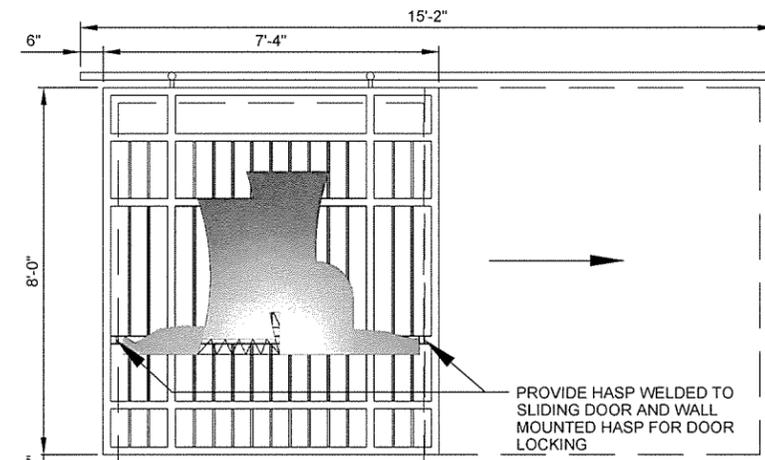


F SLIDING GATE WITH METAL SILHOUETTE GRAPHIC. METAL GRAPHIC. SEE ALLOWANCE NO. 1, SECTION 012100 - ALLOWANCES

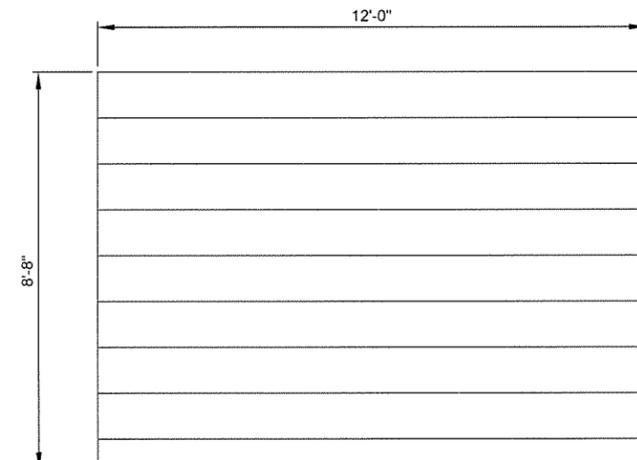


G OVERHEAD SECTIONAL DOOR - INSULATED

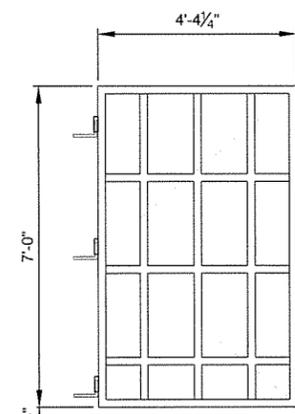


H VENDING SWING GATE

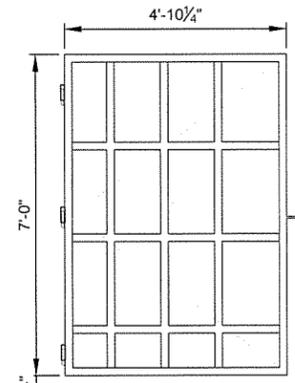


J EXTERIOR VENDING SWING GATE - WHITE RIVER LOCATION ONLY

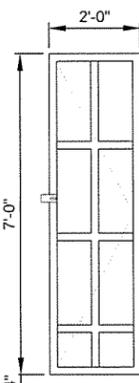


K EXTERIOR VENDING SWING GATE - WHITE RIVER LOCATION ONLY

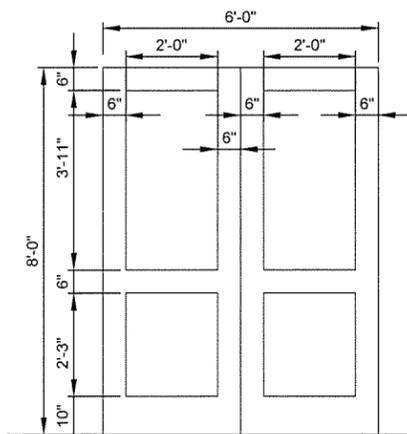


A ALUMINUM DOOR - INSULATED GLAZING

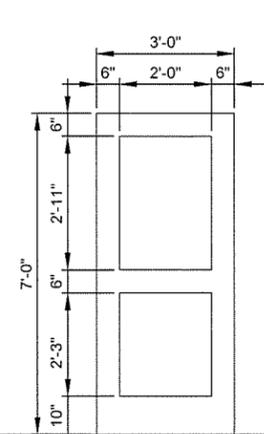


B ALUMINUM DOOR - INSULATED GLAZING

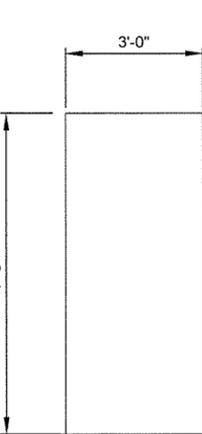

C HOLLOW METAL DOOR

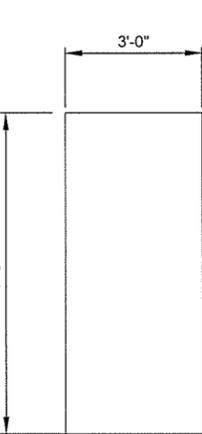


D HOLLOW METAL DOOR - INSULATED

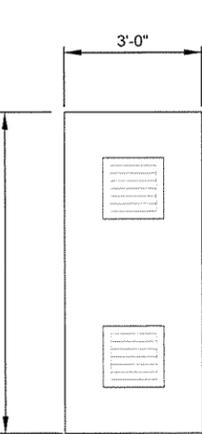

E HOLLOW METAL DOOR - 16" x 16" LOUVERS

1 DOOR ELEVATIONS
SCALE: 1/2" = 1'-0"

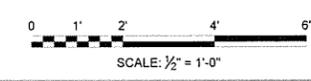


JRR
Date
10/1/15

ISSUED FOR CONSTRUCTION
Description
IFC
Symbol

Job Number
060451
Submitted by:
John T. Watkins, III, P.E., SE
Director, Federal Services
Drawn by:
J. RAMSEY
Checked by:
G. ARCHER
File Name
AHTSWR-A-003.DWG
Plot Date:
10/1/15
Plot Scale:
1:1
Dwg. Code:

ARKANSAS HIGHWAY AND TRANSPORTATION DEPARTMENT
ARKANSAS TOURIST INFORMATION CENTER
(WHITE RIVER) (S)
JOB 061451
DOOR SCHEDULE & DOOR AND FRAME ELEVATIONS

Sheet Reference Number:
A-003
Sheet 31 of 130

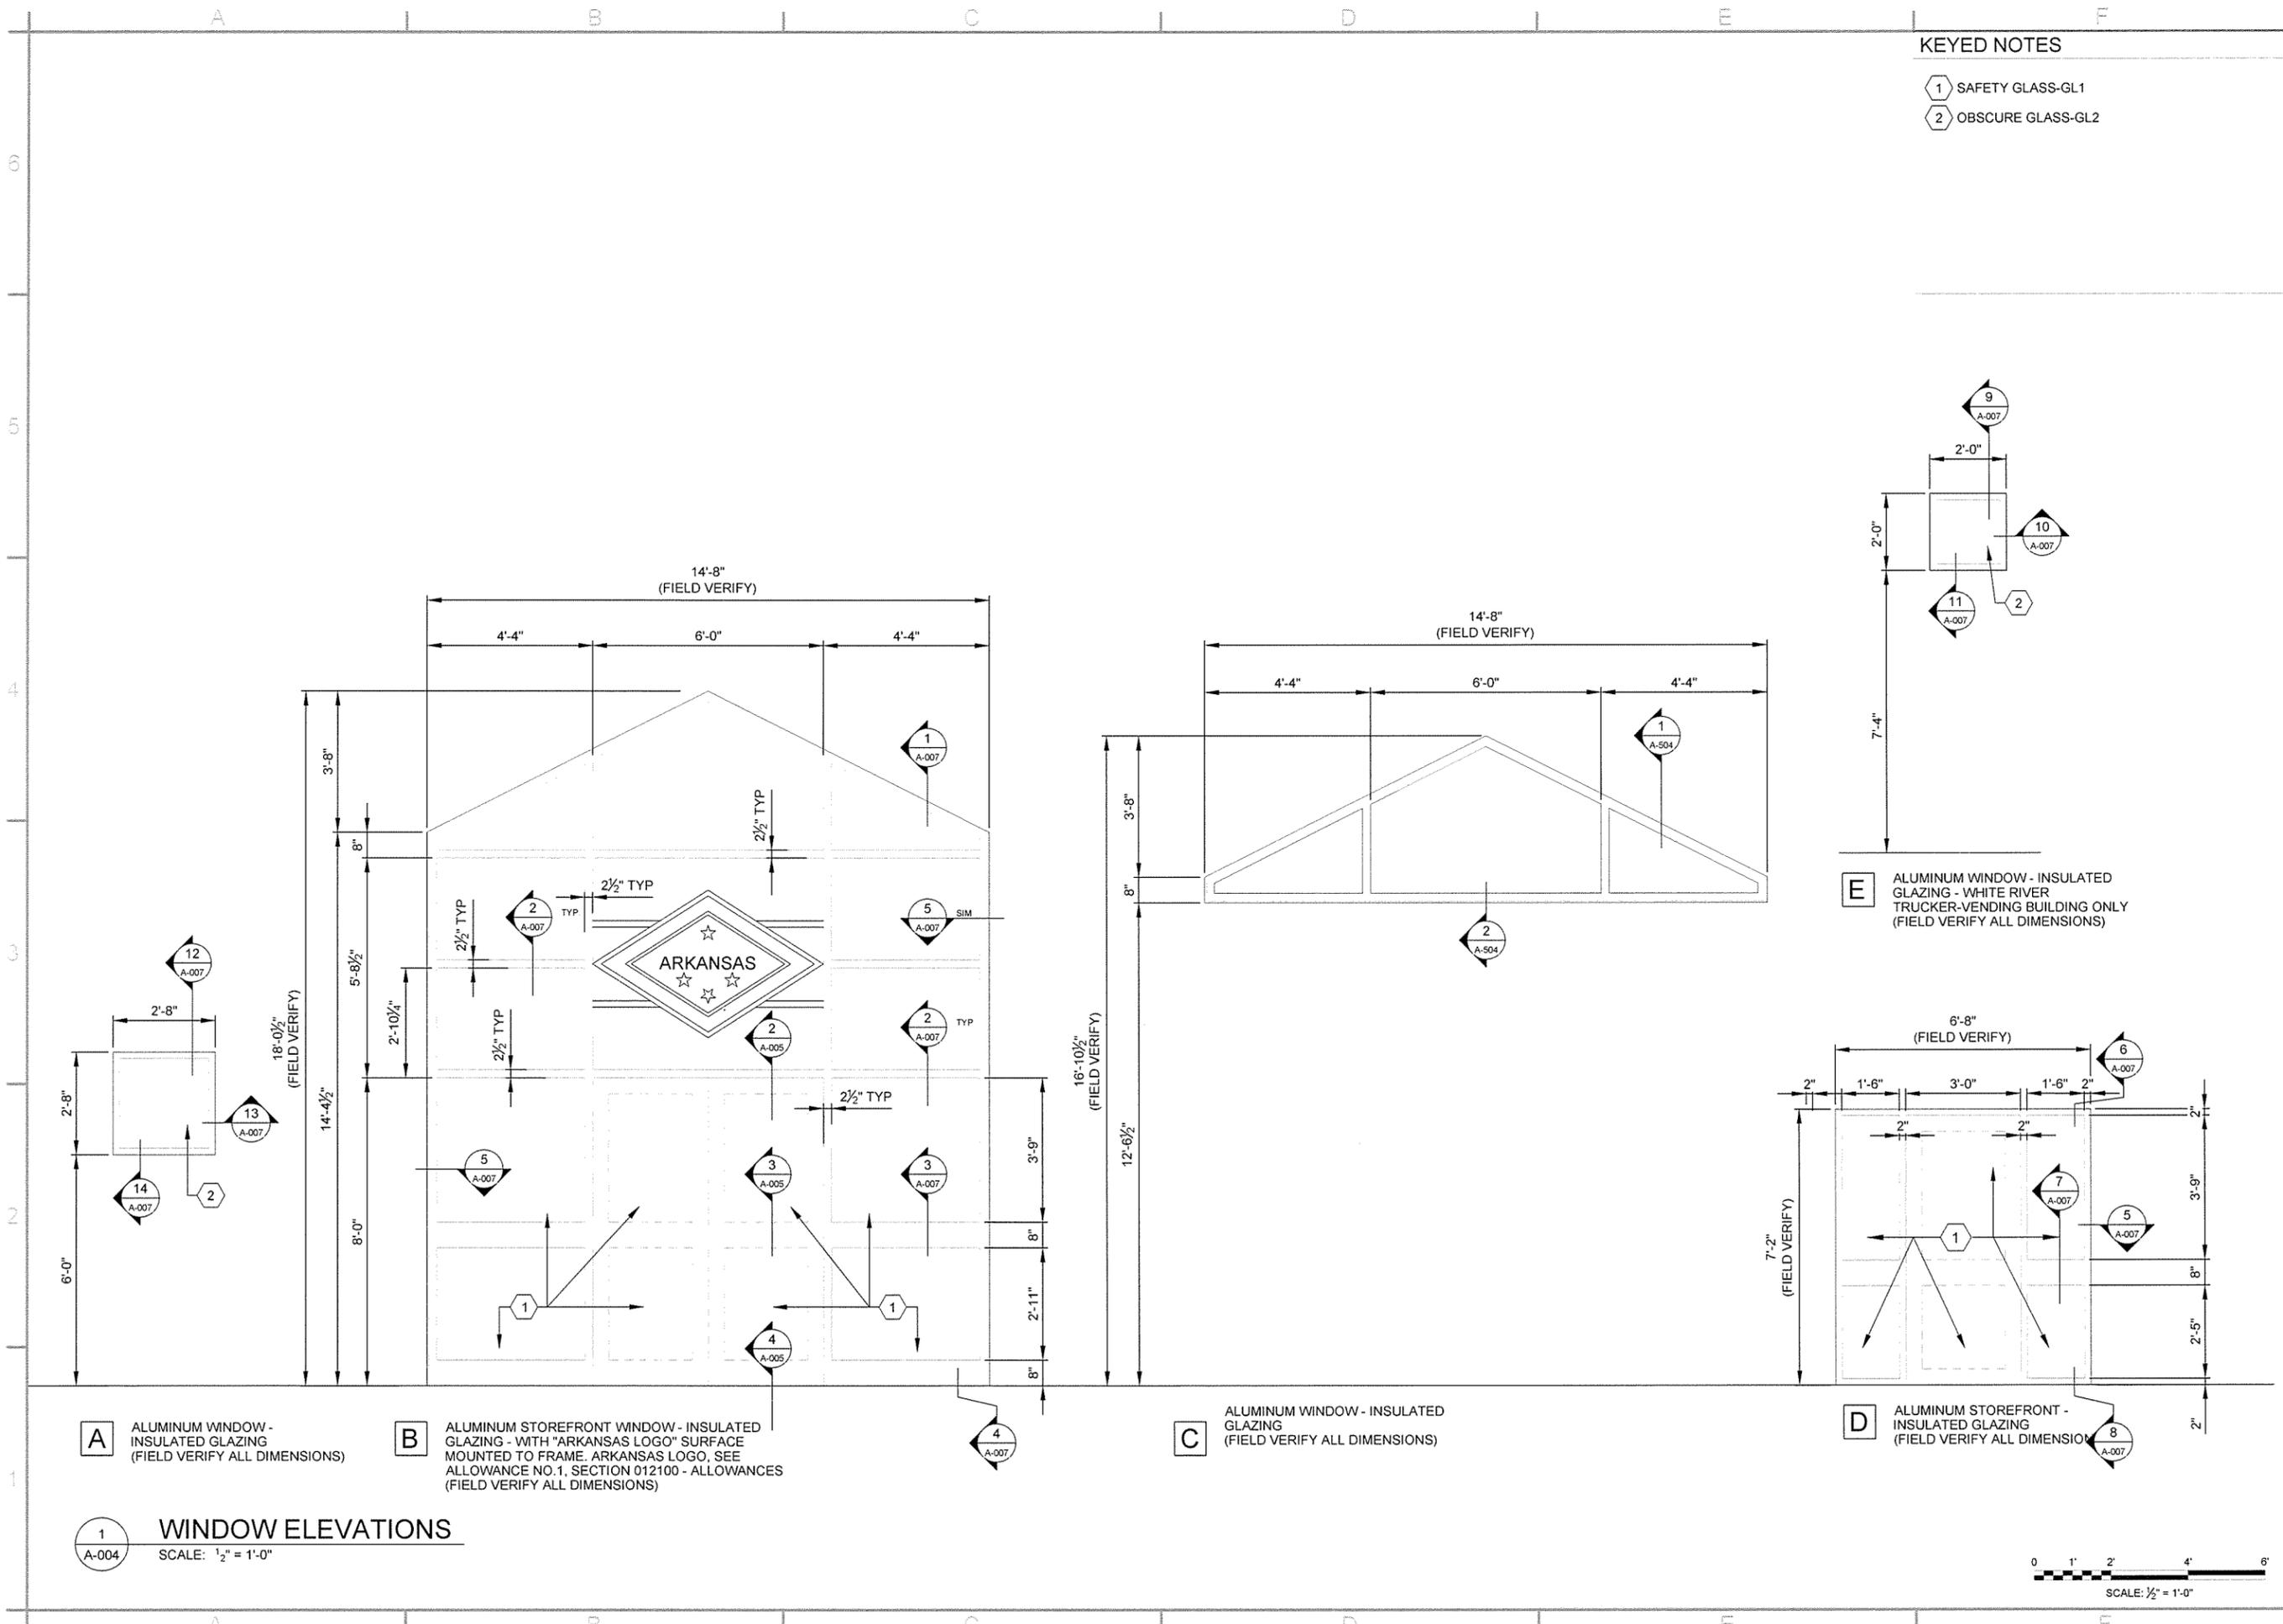

KEYED NOTES

- 1 SAFETY GLASS-GL1
- 2 OBSCURE GLASS-GL2

A ALUMINUM WINDOW - INSULATED GLAZING (FIELD VERIFY ALL DIMENSIONS)

B ALUMINUM STOREFRONT WINDOW - INSULATED GLAZING - WITH "ARKANSAS LOGO" SURFACE MOUNTED TO FRAME. ARKANSAS LOGO, SEE ALLOWANCE NO.1, SECTION 012100 - ALLOWANCES (FIELD VERIFY ALL DIMENSIONS)


C ALUMINUM WINDOW - INSULATED GLAZING (FIELD VERIFY ALL DIMENSIONS)

D ALUMINUM STOREFRONT - INSULATED GLAZING (FIELD VERIFY ALL DIMENSIONS)

E ALUMINUM WINDOW - INSULATED GLAZING - WHITE RIVER TRUCKER-VENDING BUILDING ONLY (FIELD VERIFY ALL DIMENSIONS)

1 WINDOW ELEVATIONS
A-004















SCALE: 1/2" = 1'-0"

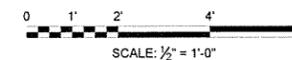

Job Number	000451	JRR
Submitted by	John T. Watkins, III, PE, SE Director, Federal Services	Appr.
Designed by	J. RAMSEY	Date
Drawn by	J. RAMSEY	10/1/15
Checked by	G. ARCHER	10/1/15
File Name:	AH15WR-A-004.DWG	ISSUED FOR CONSTRUCTION
Plot Date	10/1/15	Date
Plot Scale	1:1	Description
Divp Code		Symbol

Arkansas Highway and Transportation Department	Arkansas Tourist Information Center	White River (S)	Job 051451
WINDOW ELEVATIONS			


Arkansas Highway and Transportation Department
Arkansas Tourist Information Center
White River (S)
Job 051451

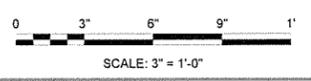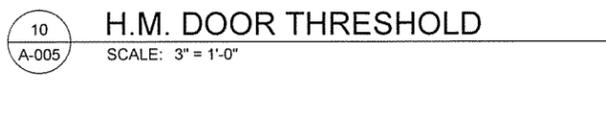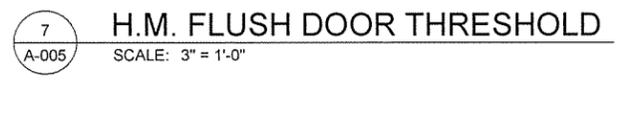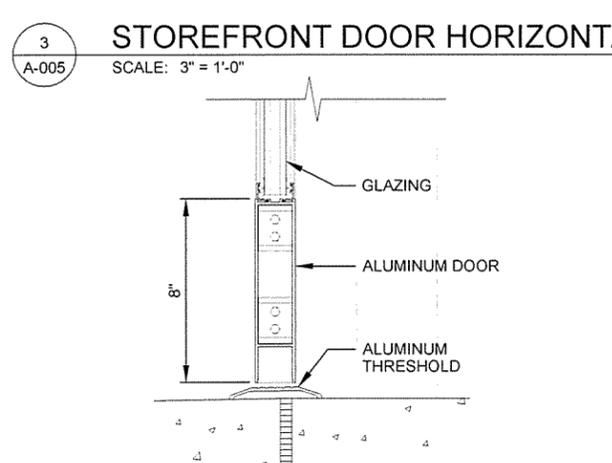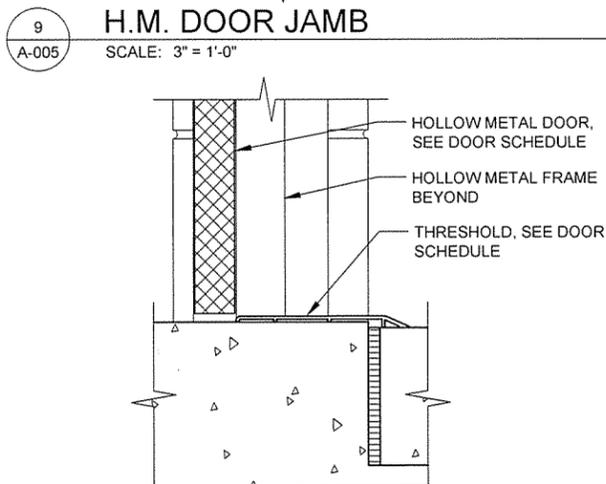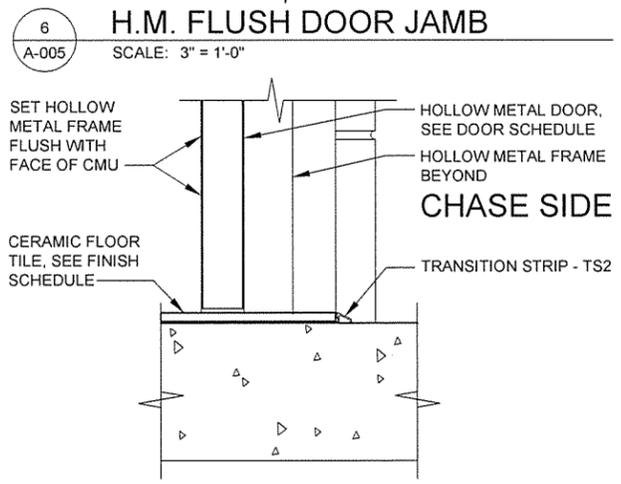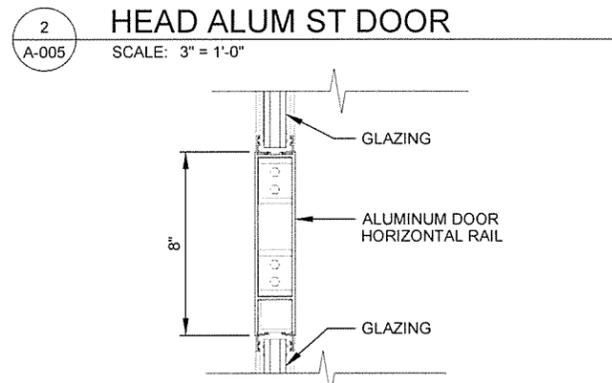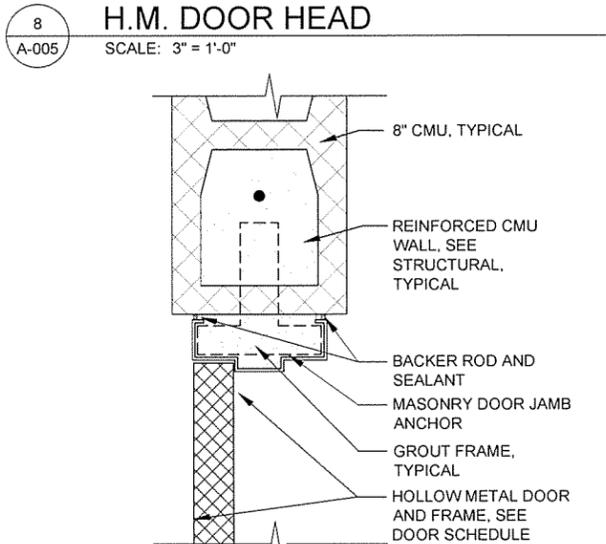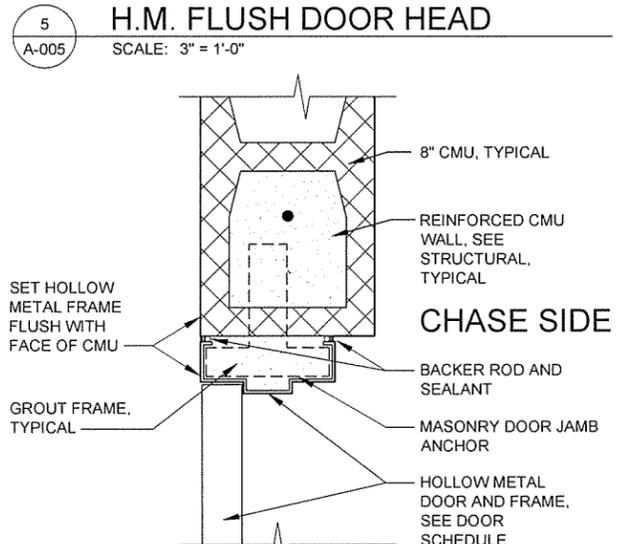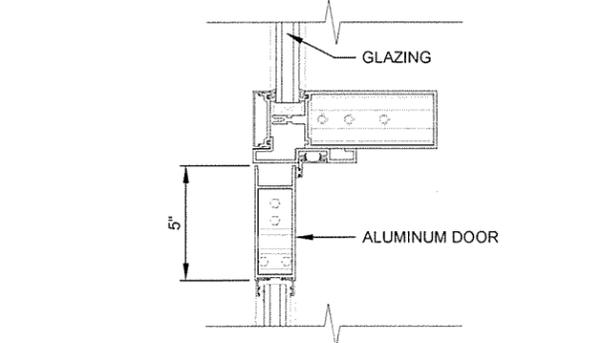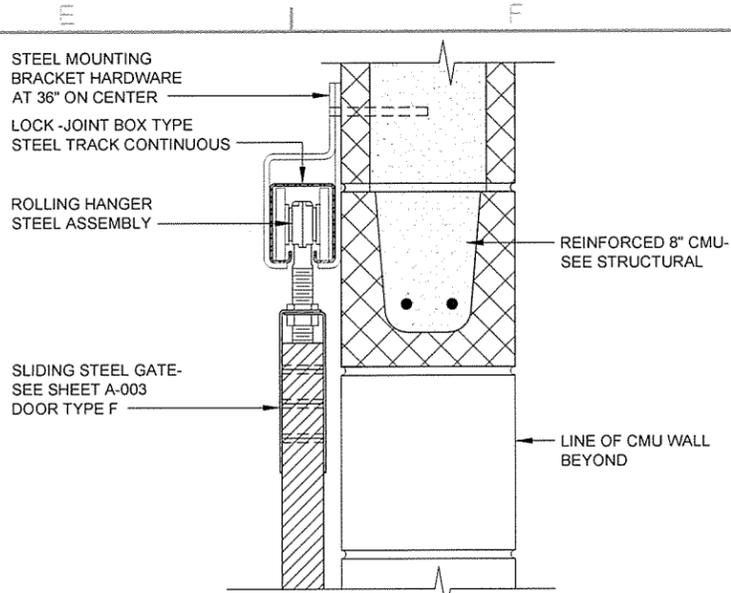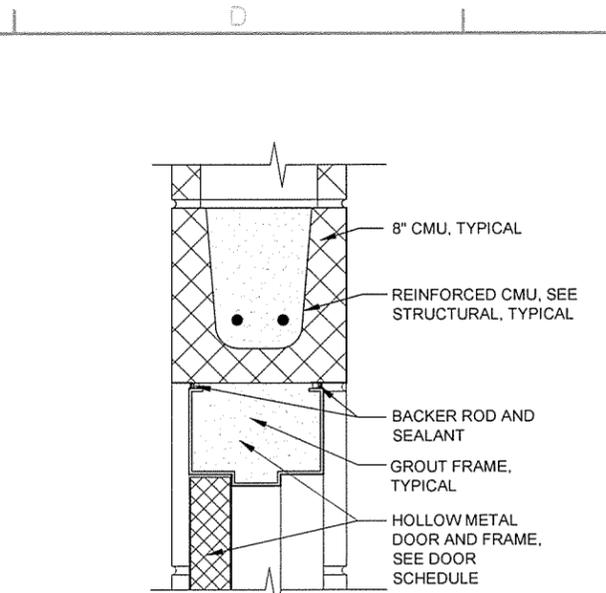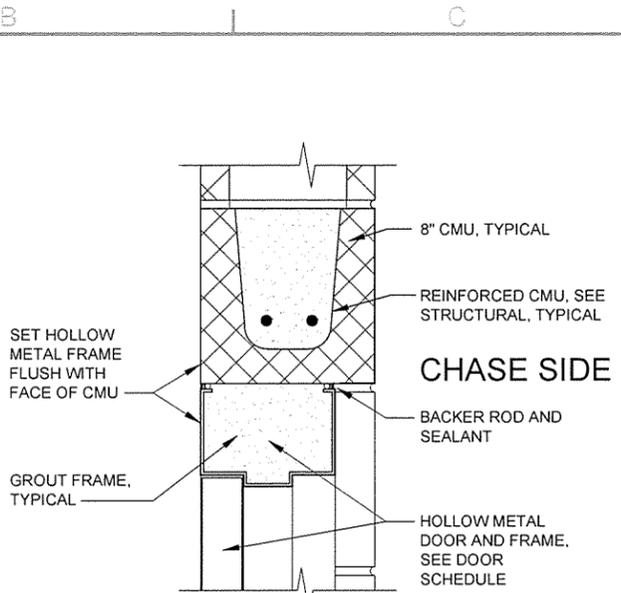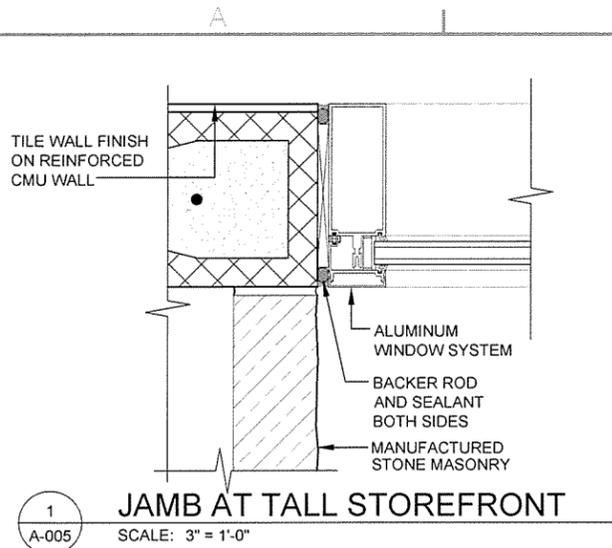


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Submitted by	John T. Watkins, III, P.E., SE Director, Federal Services	10/11/15	Date
Drawn by	J. DEMARNE		
Checked by	G. ARCHER		
Job Title	N/A		
Plot Scale	1:1		
Drug Code			
File Name	AR15VWR-A-005.DWG		
ISSUED FOR CONSTRUCTION	Description	IFC	Symbol

ARKANSAS HIGHWAY AND TRANSPORTATION DEPARTMENT	ARKANSAS TOURIST INFORMATION CENTER	DOOR DETAILS
(WHITE RIVER) (S)	JOB 061451	


Sheet Reference Number: **A-005**

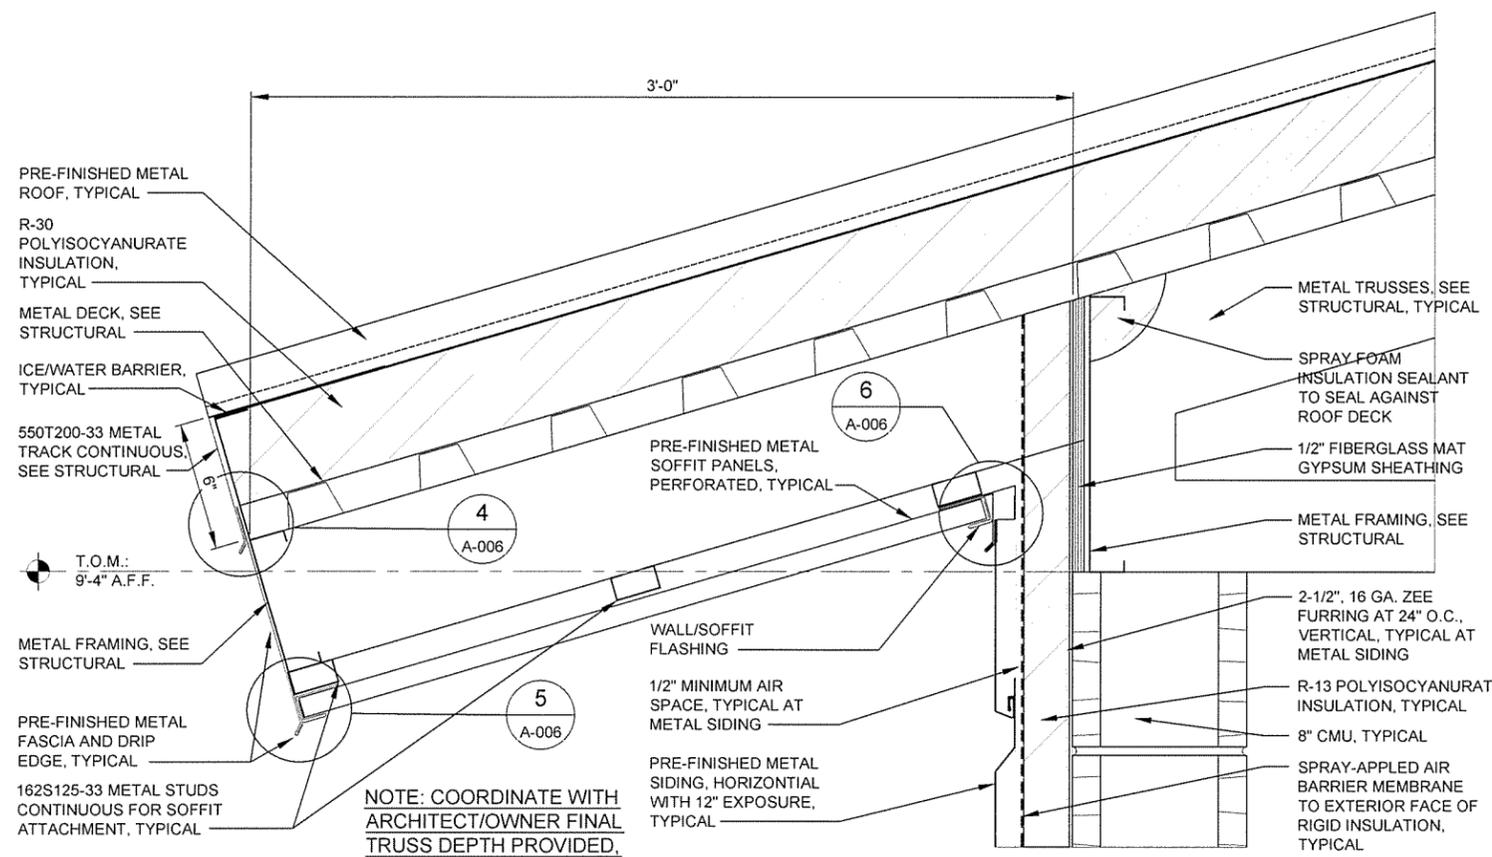


1 ROOF OVERHANG DETAIL
A-006 SCALE: 3" = 1'-0"

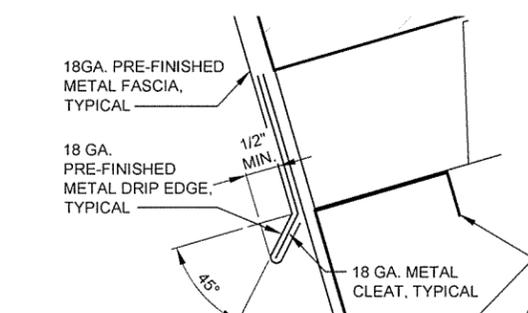


4 FASCIA DETAIL
A-006 SCALE: FULL SIZE

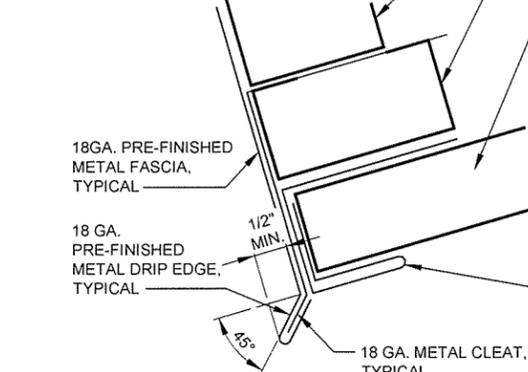


5 FASCIA DRIP
A-006 SCALE: FULL SIZE

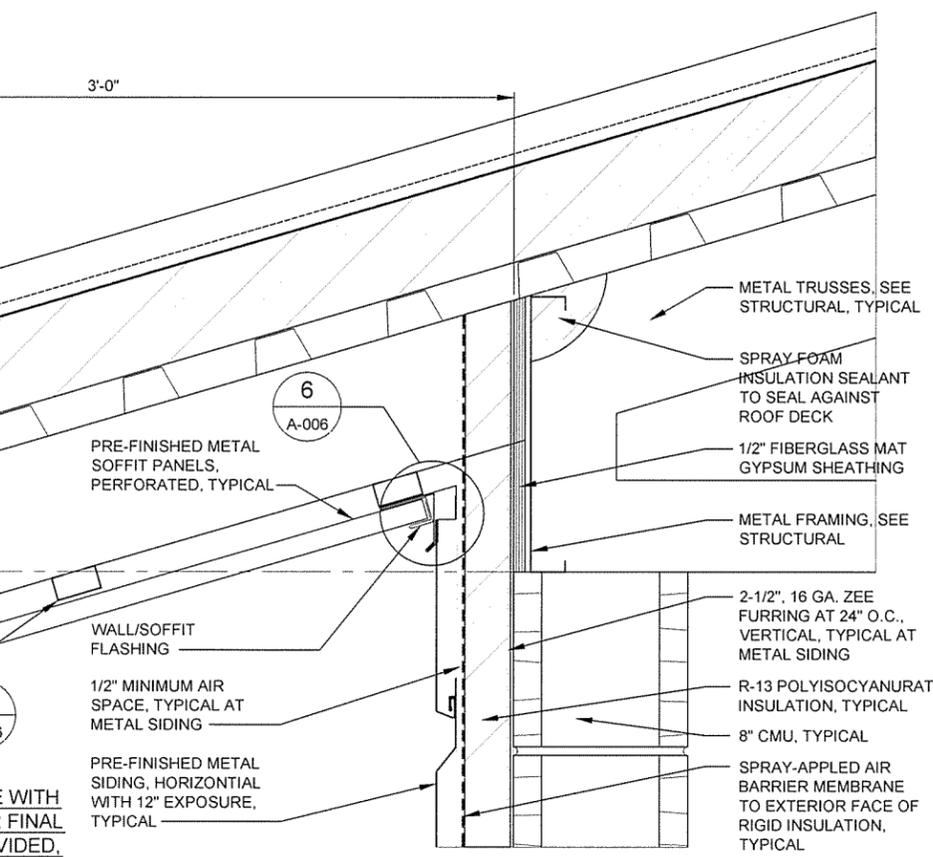


6 SOFFIT DETAIL
A-006 SCALE: FULL SIZE

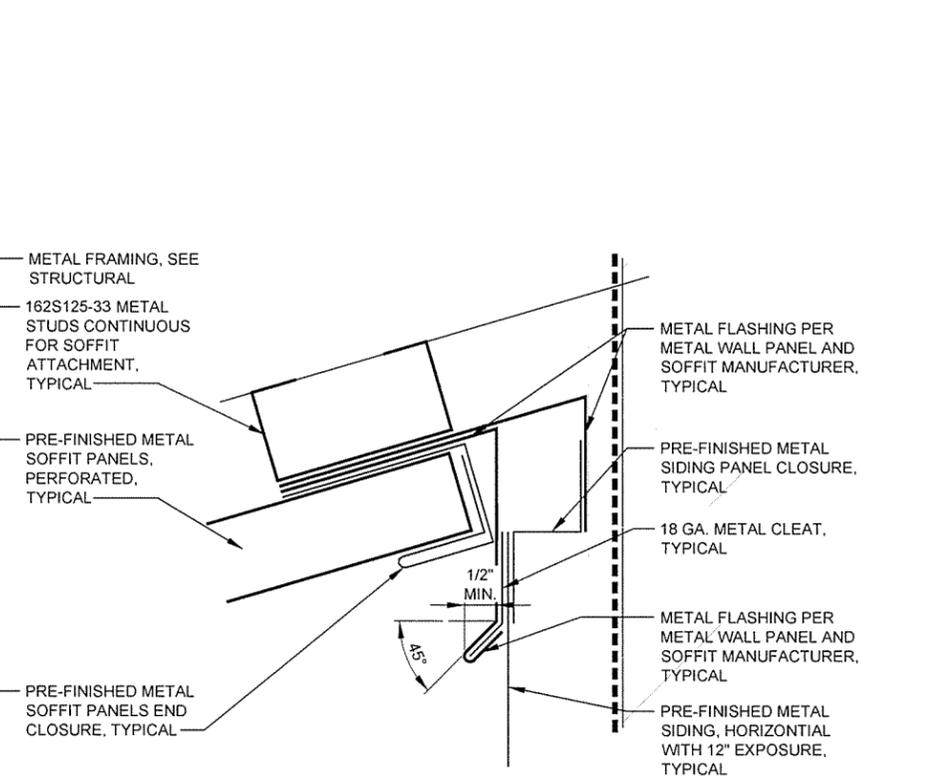



3 WALL GRADE DETAIL
A-006 SCALE: 3" = 1'-0"

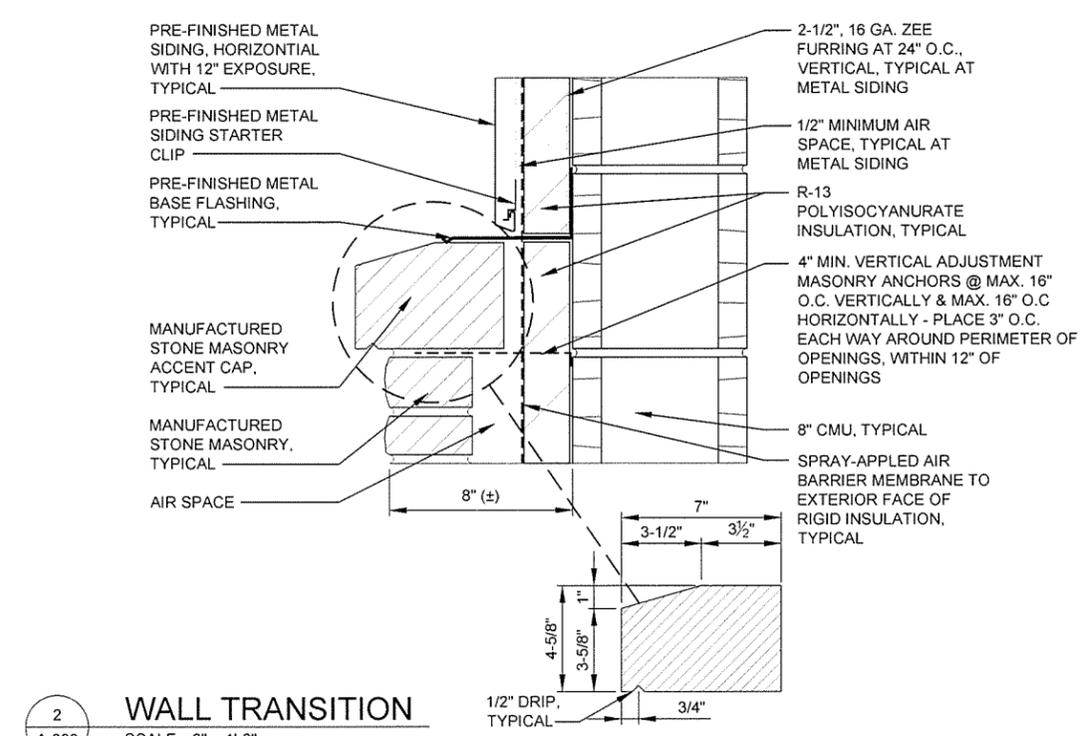

2 WALL TRANSITION
A-006 SCALE: 3" = 1'-0"

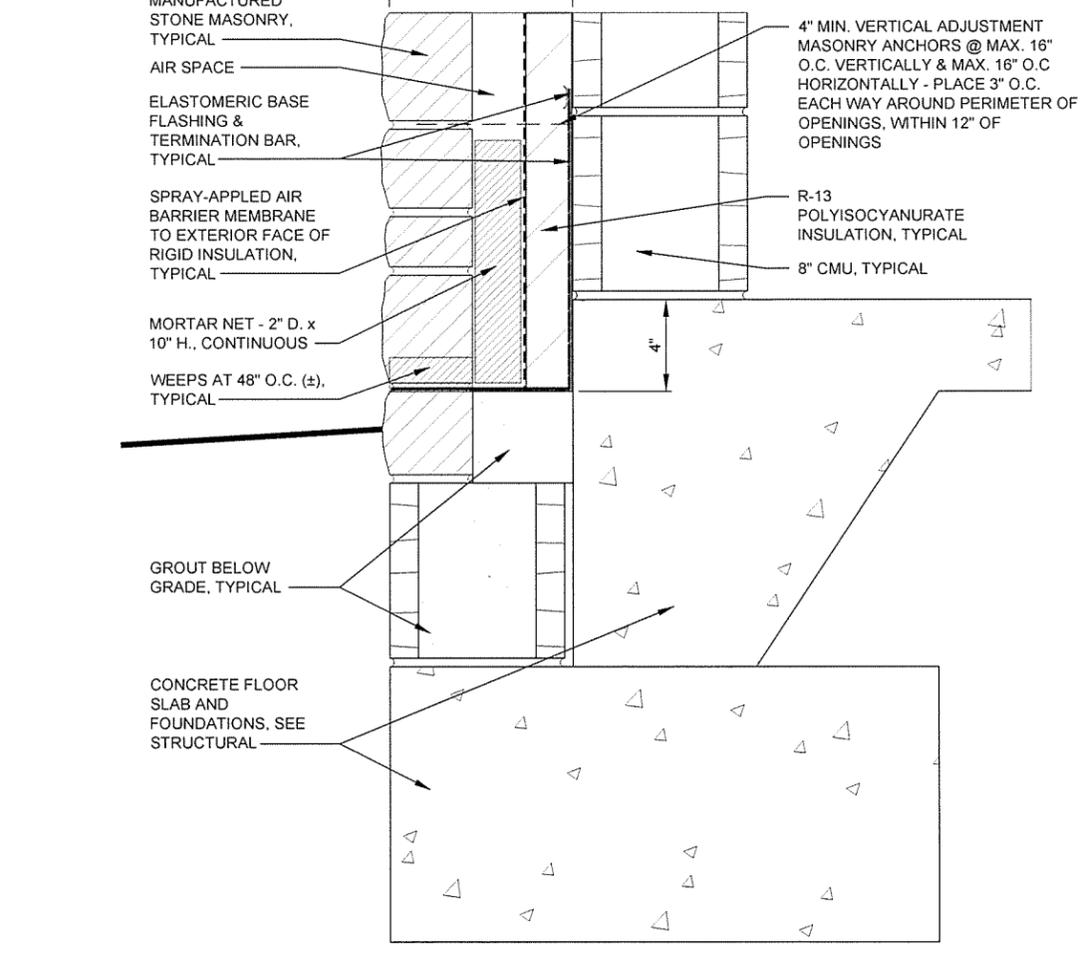


3 STANDARD WALL DETAILS
A-006 SCALE: 3" = 1'-0"

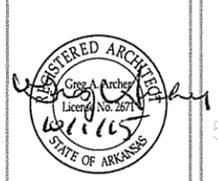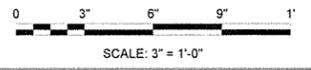


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Submitted by	John T. Watkins, III, PE, SE Director, Federal Services	Plot Scale	1:1	Plot Date	10/1/15	Drawn by	J. DEMARNE
Designed by	J. RAMSEY	Checked by	G. ARCHER	File Name	AH15VR-A-006.DWG	Issued For Construction	IFC Symbol

Arkansas Highway and Transportation Department	Arkansas Tourist Information Center	(White River) (S)	Job 061451
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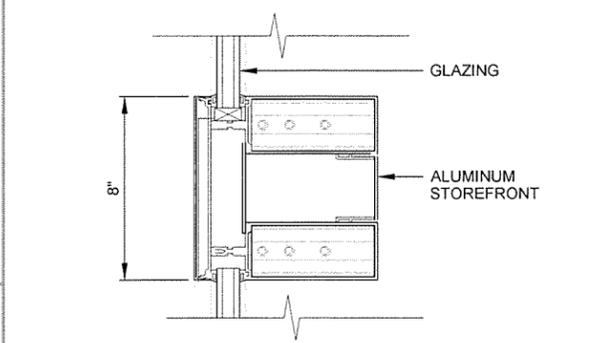
STANDARD WALL DETAILS

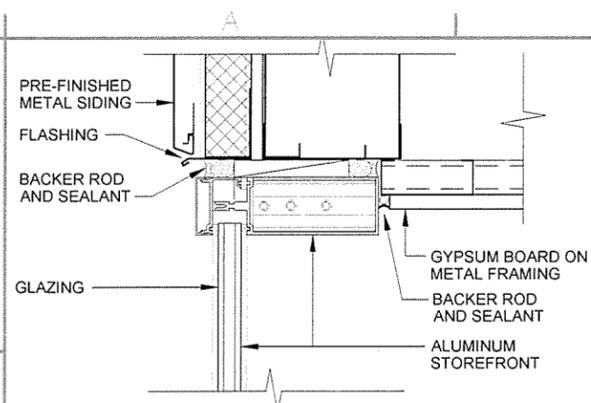


1 HEAD STOREFRONT
A-007 SCALE: 3" = 1'-0"

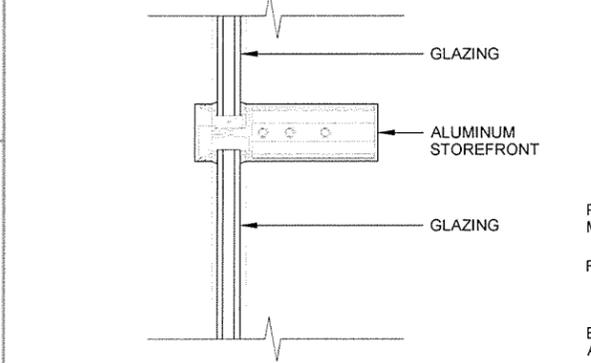


2 HORIZONTAL MULLION
A-007 SCALE: 3" = 1'-0"




3 HORIZONTAL MULLION
A-007 SCALE: 3" = 1'-0"

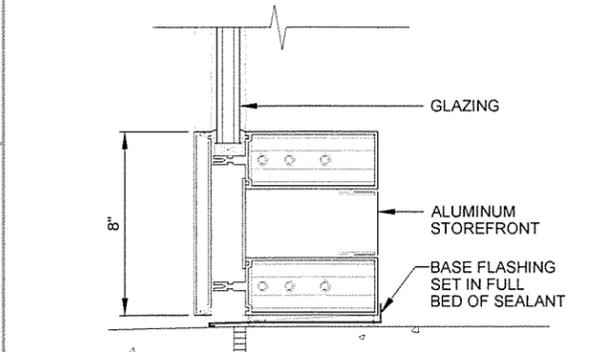


4 STOREFRONT WINDOW SILL
A-007 SCALE: 3" = 1'-0"

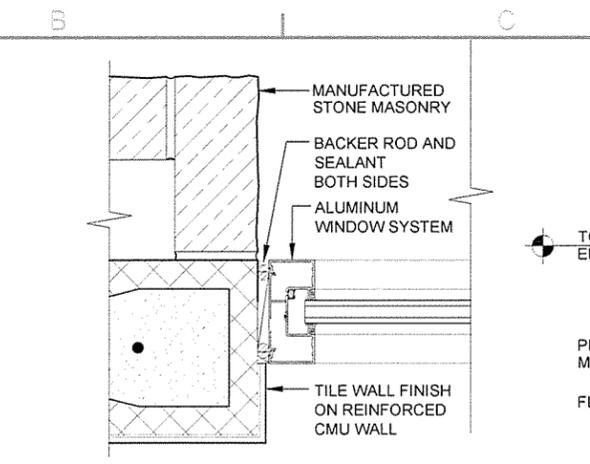


5 JAMB AT LOW STOREFRONT
A-007 SCALE: 3" = 1'-0"

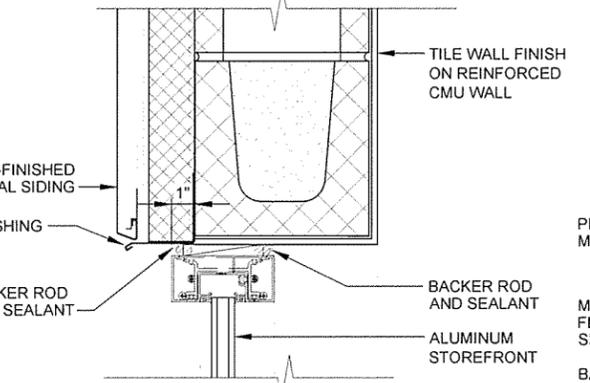


6 HEAD ALUM STOREFRONT
A-007 SCALE: 3" = 1'-0"

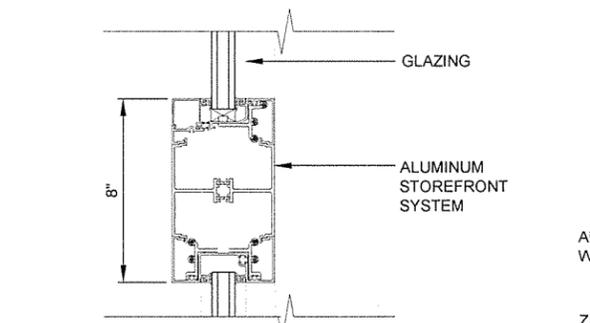


7 STOREFRONT HORIZONTAL
A-007 SCALE: 3" = 1'-0"

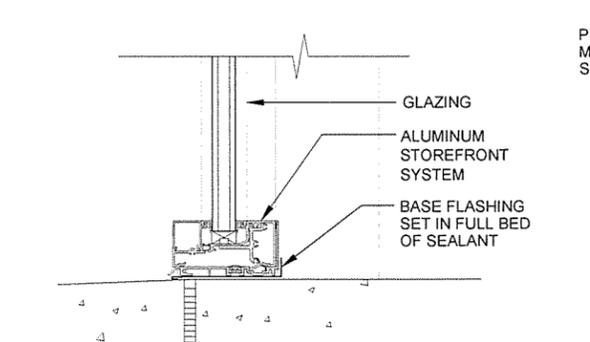


8 SILL AT LOW STOREFRONT
A-007 SCALE: 3" = 1'-0"

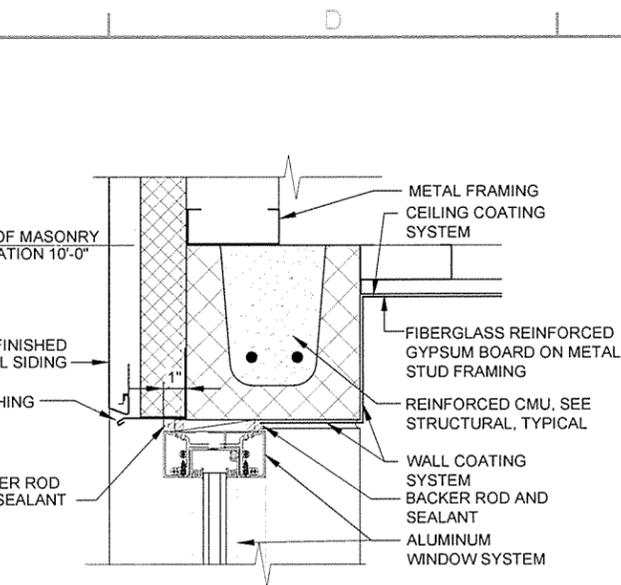


9 HEAD ALUM WINDOW
A-007 SCALE: 3" = 1'-0"

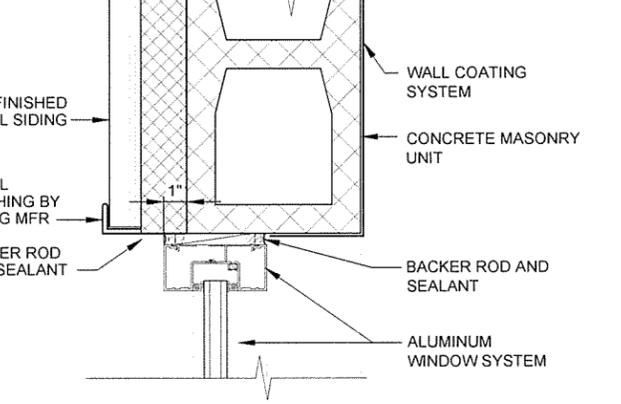


10 JAMB AT ALUM WINDOW
A-007 SCALE: 3" = 1'-0"

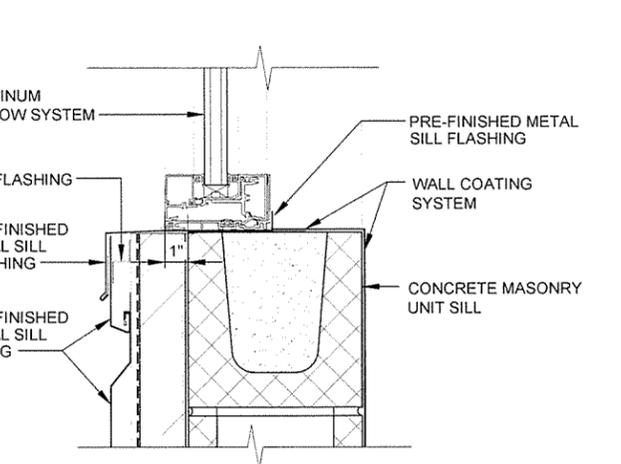


11 SILL ALUM WINDOW
A-007 SCALE: 3" = 1'-0"

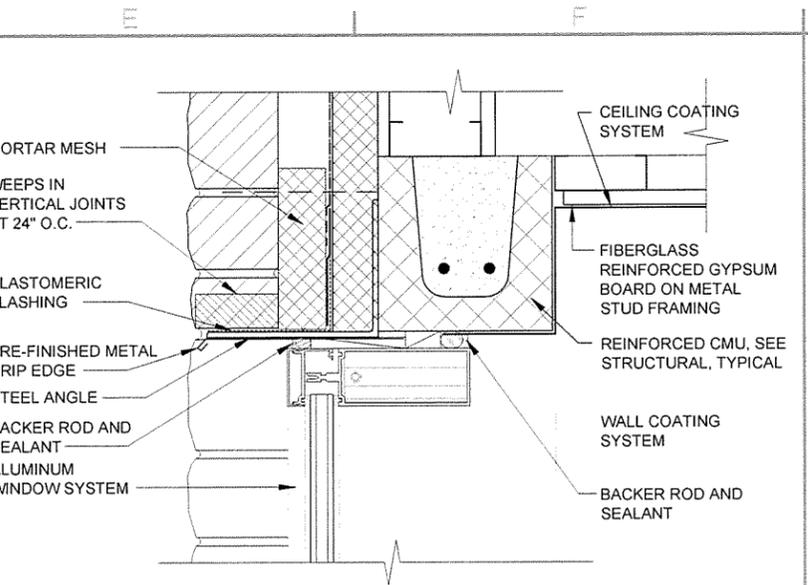


12 HEAD ALUM WINDOW
A-007 SCALE: 3" = 1'-0"

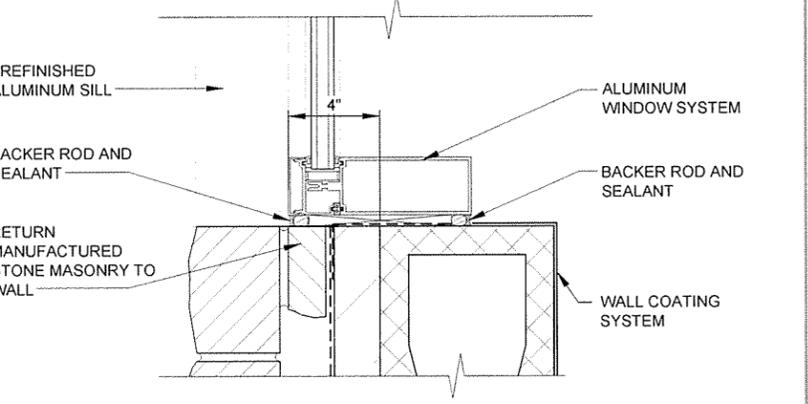

13 JAMB AT ALUM WINDOW
A-007 SCALE: 3" = 1'-0"

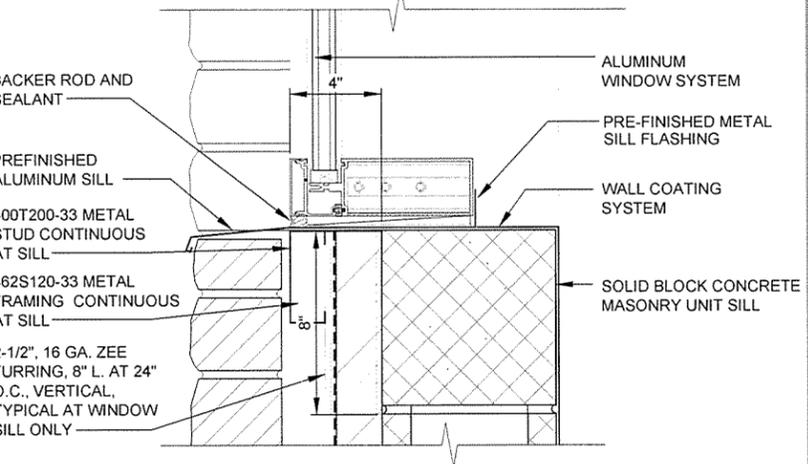

14 SILL ALUM WINDOW
A-007 SCALE: 3" = 1'-0"

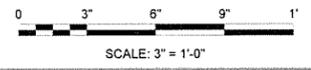


Job Number	060451	JRR	Appr.
Submitted by	John T. Watkins, III, P.E., SE Director, Federal Services	Date	10/11/15
Designed by	J. RAMSEY	IFC	Symbol
Drawn by	J. DEMARNE	ISSUED FOR CONSTRUCTION	Description
Plot Date	10/11/15	Plot Scale	1:1
Checked by	G. ARCHER	File Name	AH15WR-A-007.DWG
Drwg Code			

Arkansas Highway and Transportation Department	Arkansas Tourist Information Center	(White River) (S)	Job 061451
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WINDOW DETAILS


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Designed by J. RAMSEY	Drawn by J. RAMSEY	Checked by G. ARCHER	File Name AR15VWR-A-101.DWG
Issued For Construction	IFC Symbol	Date 10/1/15	JRR Appr.


ARKANSAS HIGHWAY AND TRANSPORTATION DEPARTMENT
 ARKANSAS TOURIST INFORMATION CENTER
 (WHITE RIVER) (S)
 JOB 061451
 TOURIST INFORMATION CENTER
 FLOOR PLAN

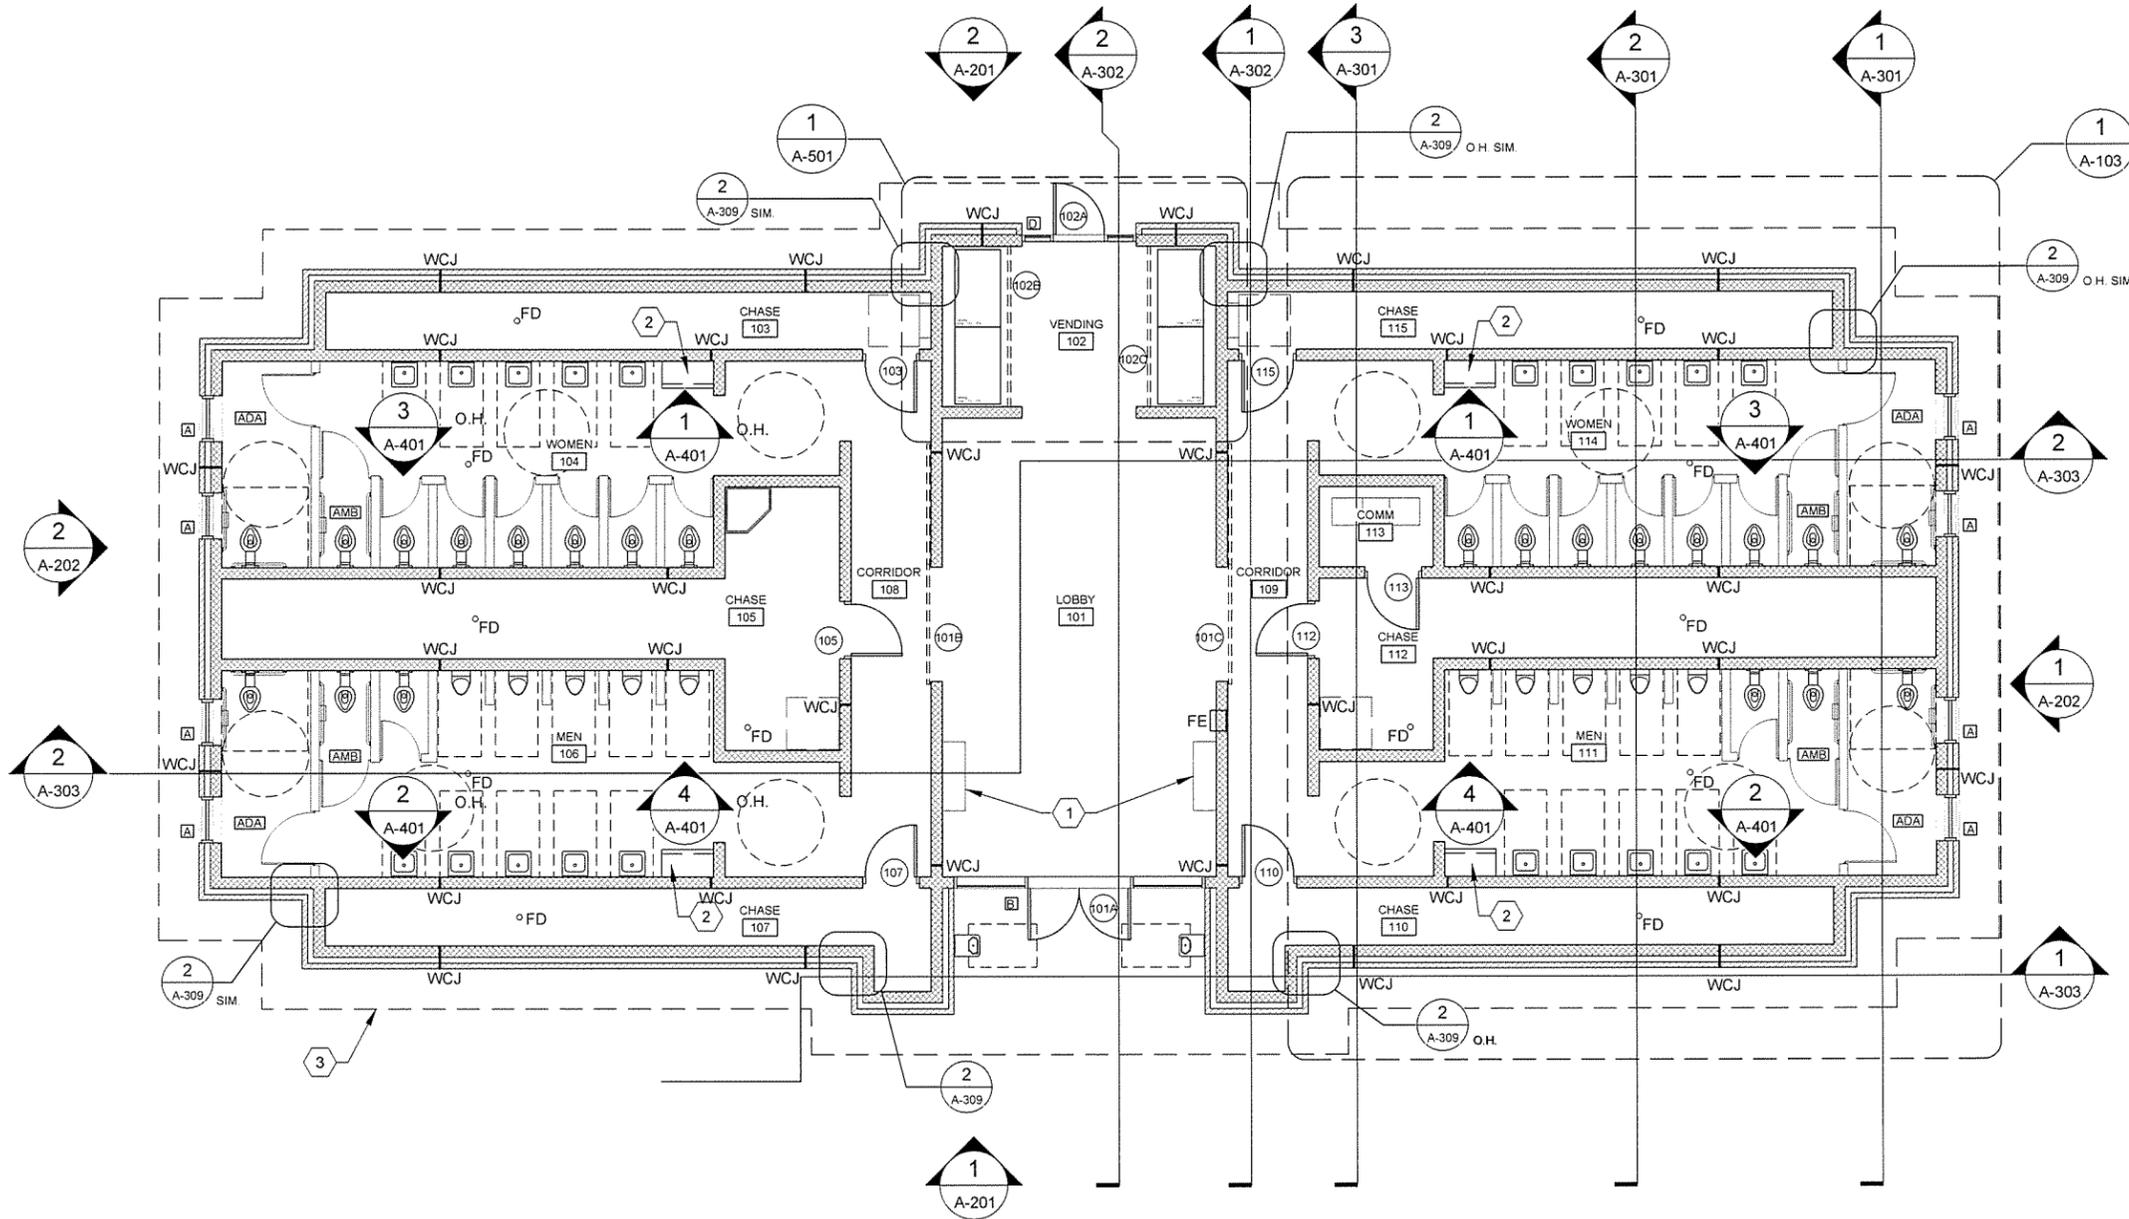

FLOOR PLAN
 SCALE: 3/16" = 1'-0"
 PLAN NORTH

GENERAL NOTES	KEYED NOTES	LEGEND
1. SEE SHEET A-102 FOR DIMENSIONED FLOOR PLAN. 2. SEE SHEET A-103 FOR ENLARGED TOILET AREA DIMENSIONED FLOOR PLAN 3. SEE CIVIL SHEETS FOR ORIENTATION OF BUILDING ON SITE 4. SEE SHEET A-002 FOR MATERIAL AND COLOR LEGENDS	1 WALL-MOUNTED MONITOR SECURITY CABINET. SEE ALLOWANCE NO. 2, SECTION 012100 - ALLOWANCES. CONFIRM FINAL MOUNTING HEIGHT WITH OWNER/ARCHITECT. 2 BABY CHANGING PLATFORM 3 DASHED LINE INDICATES ROOF OVERHANG ABOVE	100 DOOR NUMBERS A WINDOW SYMBOLS ADA FLOOR CLEARANCES ADA COMPLIANT STALL ADA AMBULATORY COMPLIANT STALL FE FIRE EXTINGUISHER AND SEMI-RECESSED CABINET FD FLOOR DRAIN WCJ WALL CONTROL JOINT, CMU AND MANUFACTURED STONE MASONRY

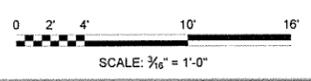

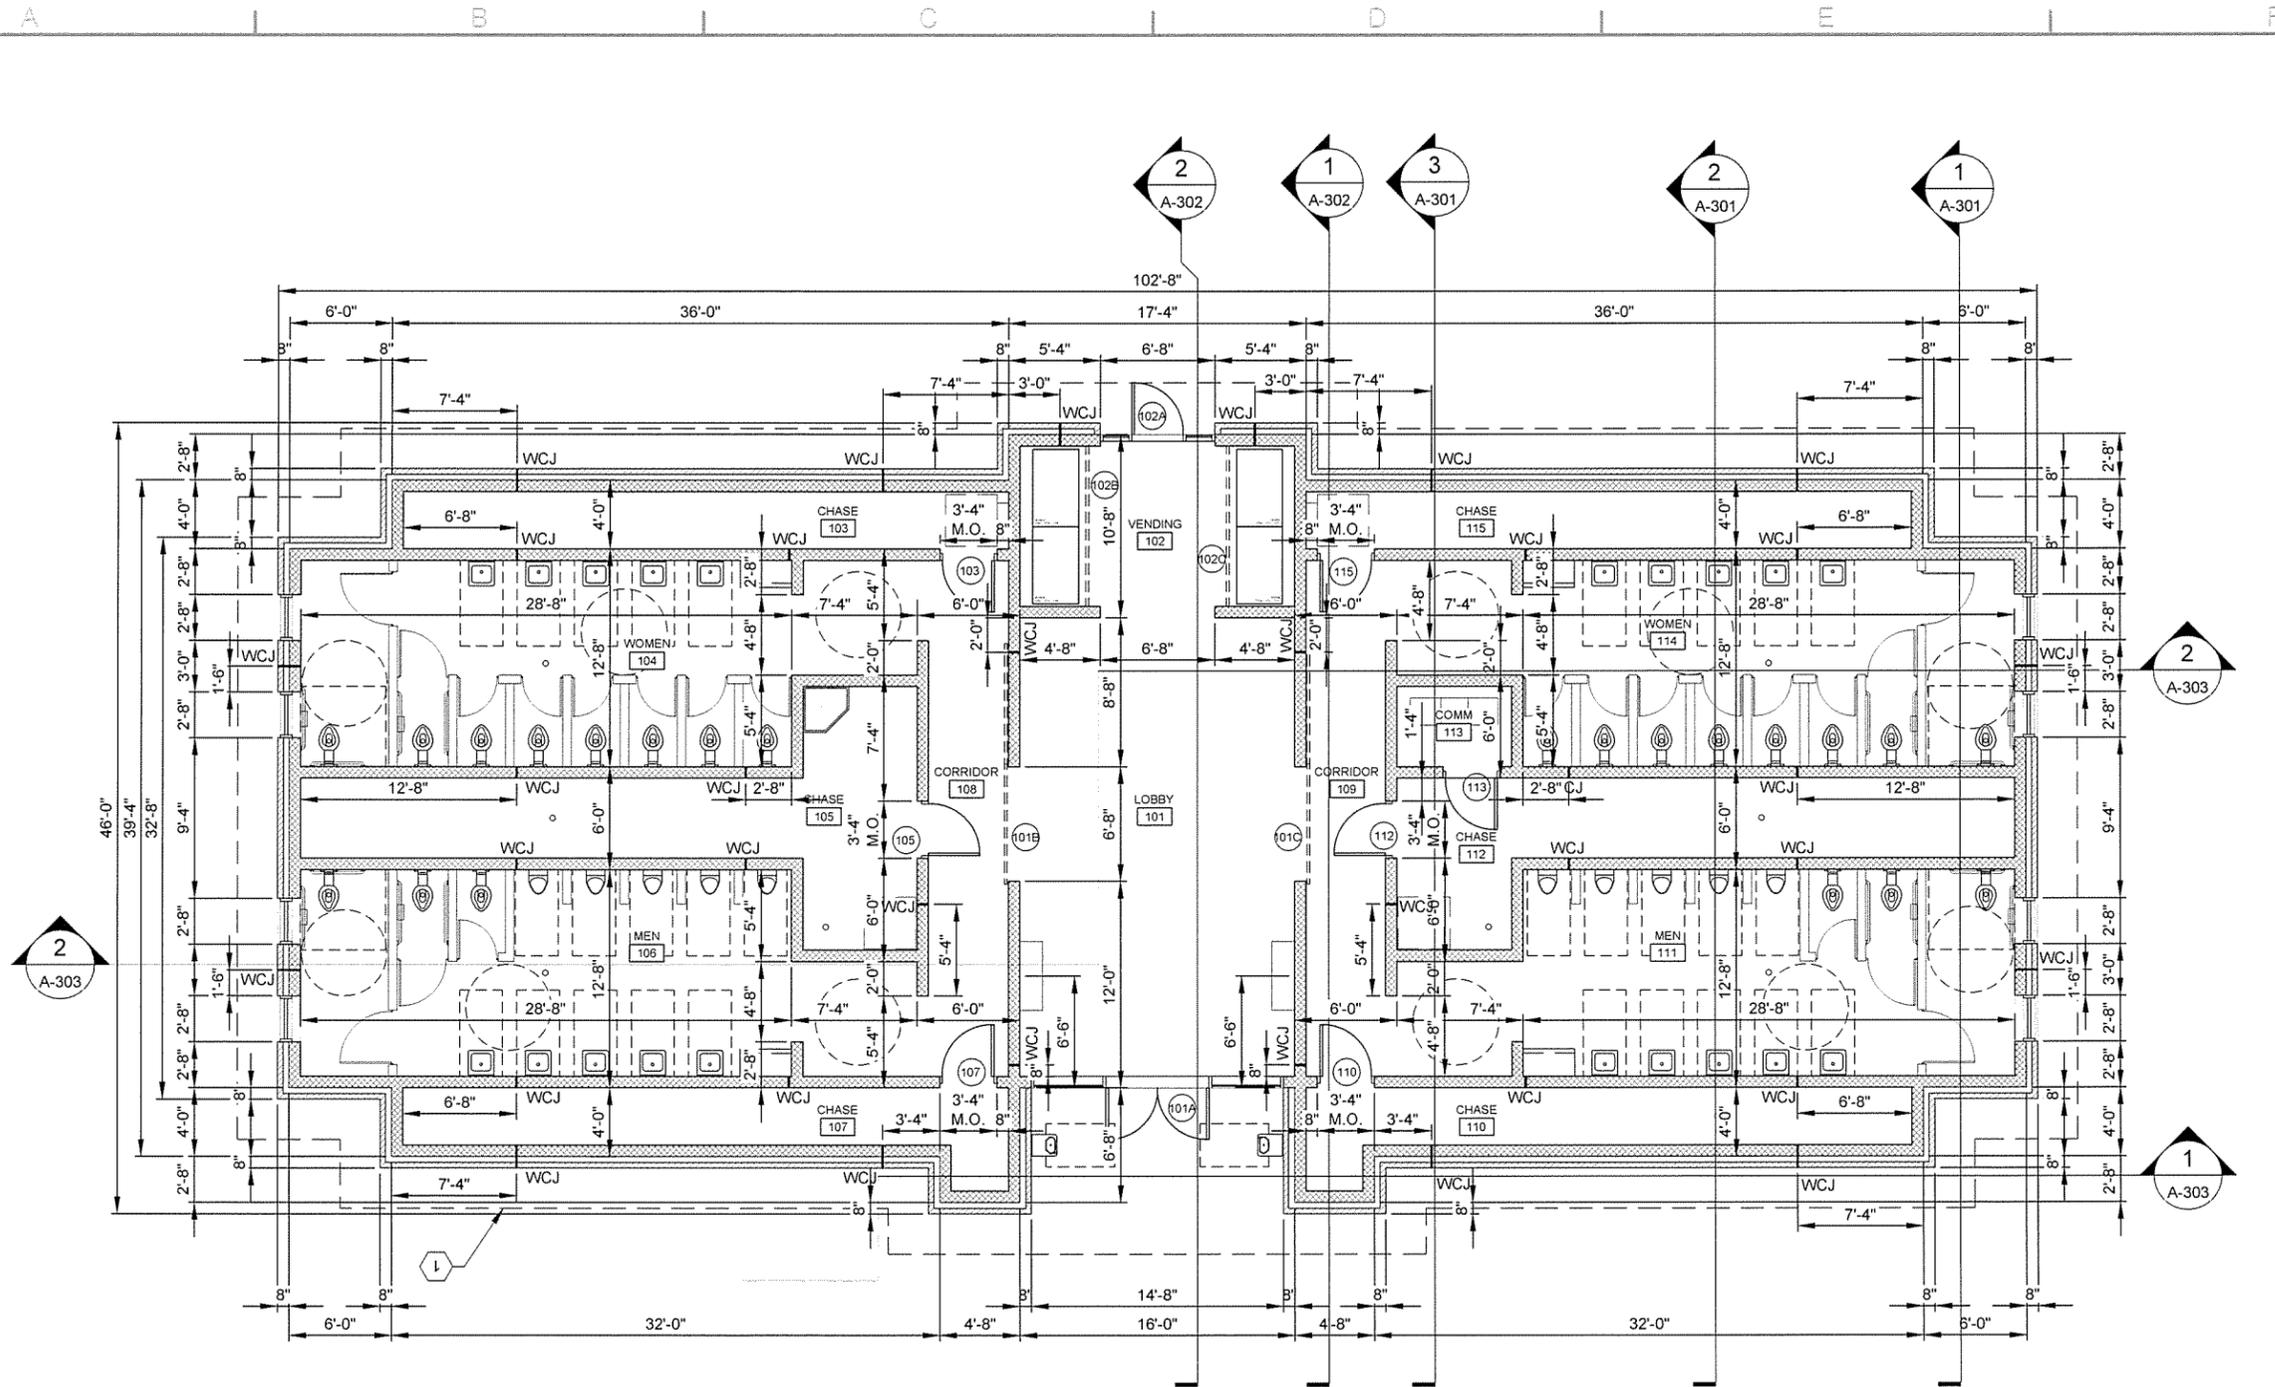

1
A-102

DIMENSIONED FLOOR PLAN

SCALE: 3/16" = 1'-0"

GENERAL NOTES


1. SEE SHEET A-101 FOR DOOR AND WINDOW SYMBOLS
2. ALL DIMENSIONS TO FACE OF CMU UNLESS NOTED OTHERWISE
3. SEE CIVIL SHEETS FOR ORIENTATION OF BUILDING ON SITE
4. SEE SHEET A-002 FOR MATERIAL AND COLOR LEGENDS

KEYED NOTES

- 1 DASHED LINE INDICATES ROOF OVERHANG ABOVE

LEGEND

- 100 DOOR NUMBERS
- A WINDOW SYMBOLS
- ADA FLOOR CLEARANCES
- FE FIRE EXTINGUISHER AND SEMI-RECESSED CABINET
- FD FLOOR DRAIN
- WCJ WALL CONTROL JOINT, CMU AND MANUFACTURED STONE MASONRY

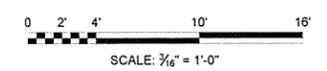


JR	Appr.
10/1/15	Date
ISSUED FOR CONSTRUCTION	Description
IFC	Symbol

Submitted by John T. Valente, III, P.E., S.E. Director, Facility Services	Job Number 060451	N/A	N/A	N/A
Plat Date 10/1/15	Plat Scale 1:1	N/A	N/A	N/A
Designed by J. RAMSEY	Drawn by J. RAMSEY	Checked by G. ARCHER	File Name A1151RR-01_102 DWG	


ARKANSAS HIGHWAY AND TRANSPORTATION DEPARTMENT
ARKANSAS TOURIST INFORMATION CENTER
(WHITE RIVER) (S)
JOB 061451

TOURIST INFORMATION CENTER
DIMENSIONED FLOOR PLAN


Sheet Reference Number:
A-102
Sheet 37 of 130

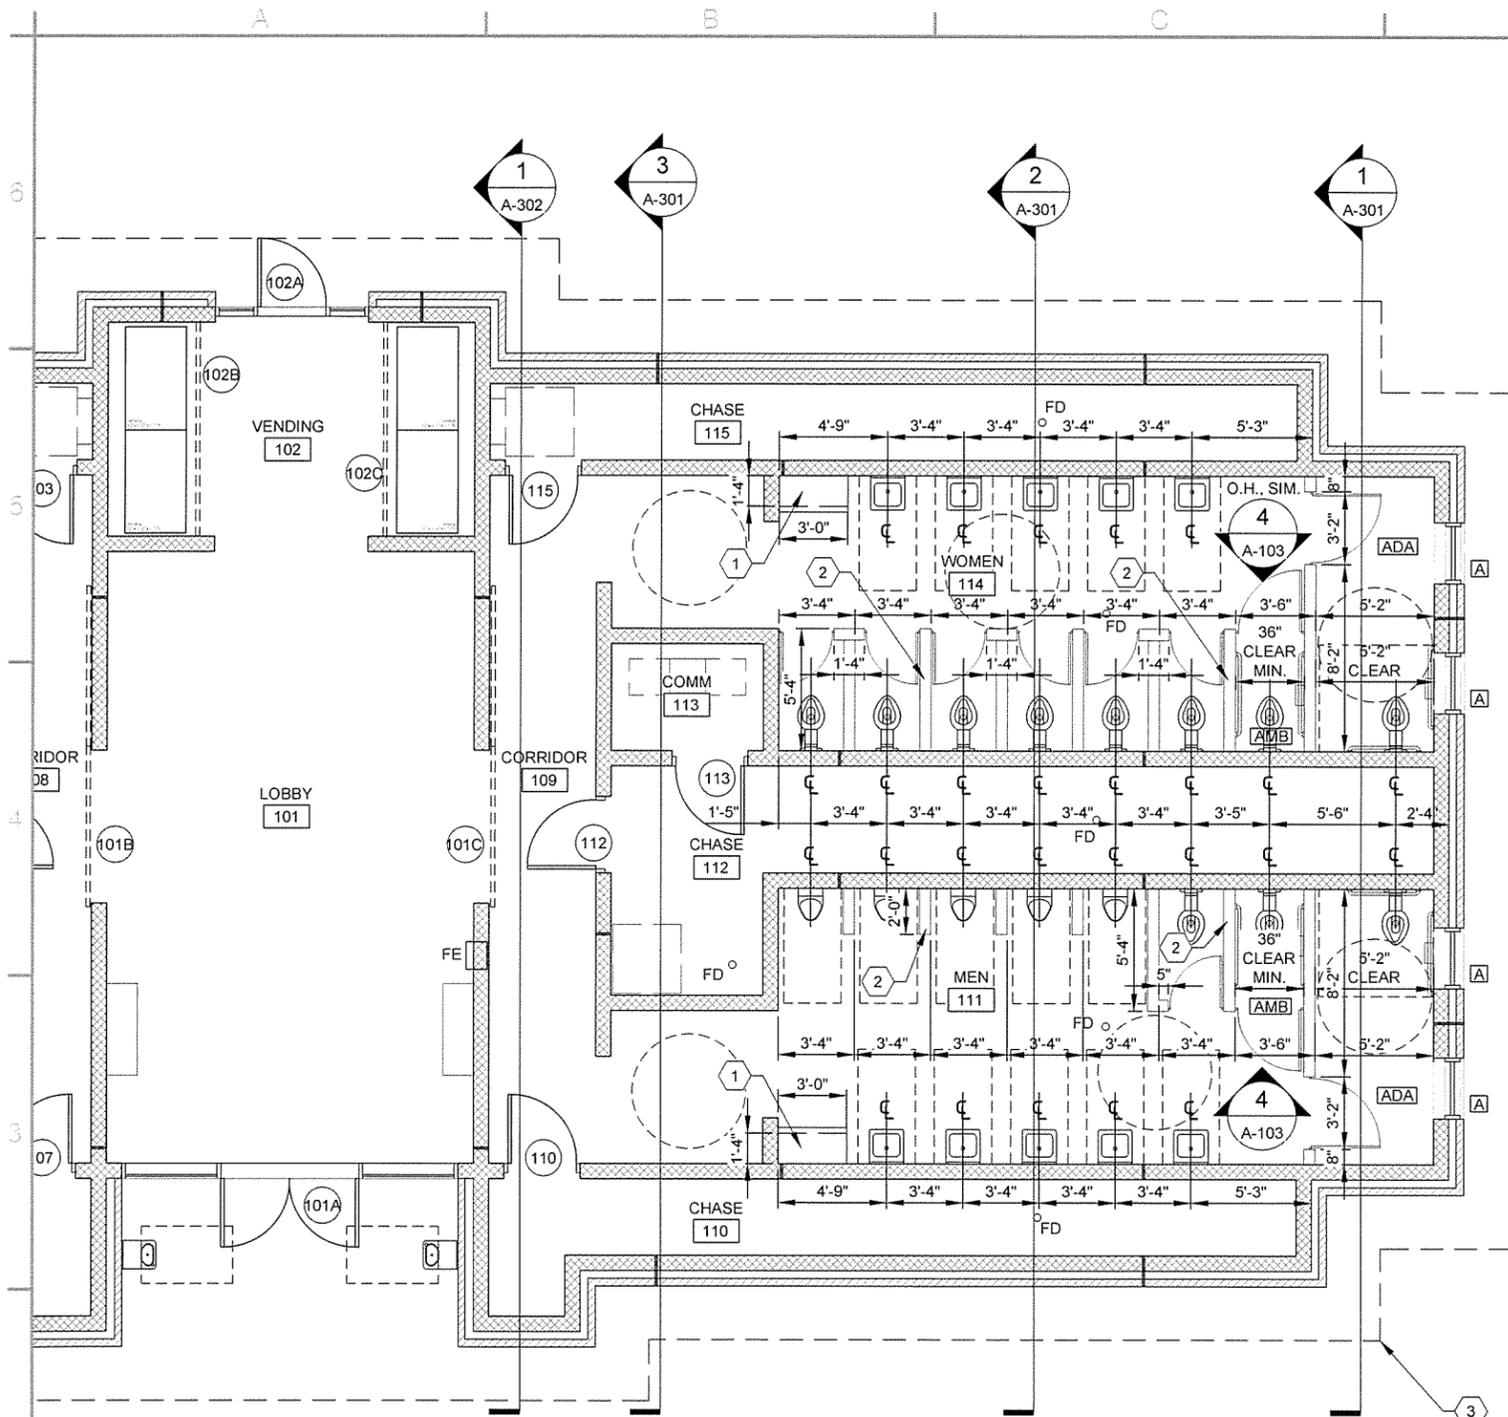


1 PARTIAL FIXTURE DIMENSIONED FLOOR PLAN
 SCALE: 1/4" = 1'-0"
 PLAN NORTH

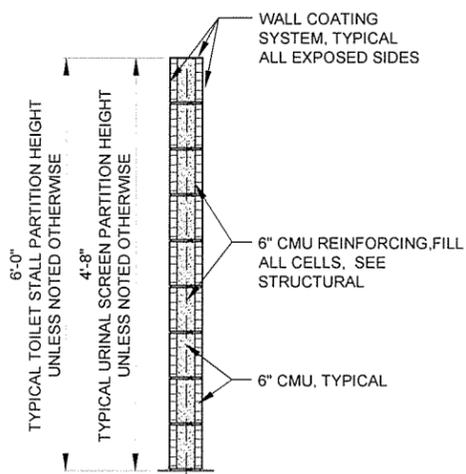

2 TYPICAL 6" CMU PARTITION WALL
 SCALE: 3/4" = 1'-0"

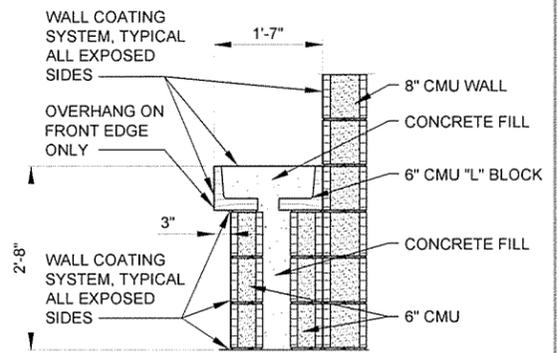

3 BABY CHANGING PLATFORM SECTION
 SCALE: 3/4" = 1'-0"

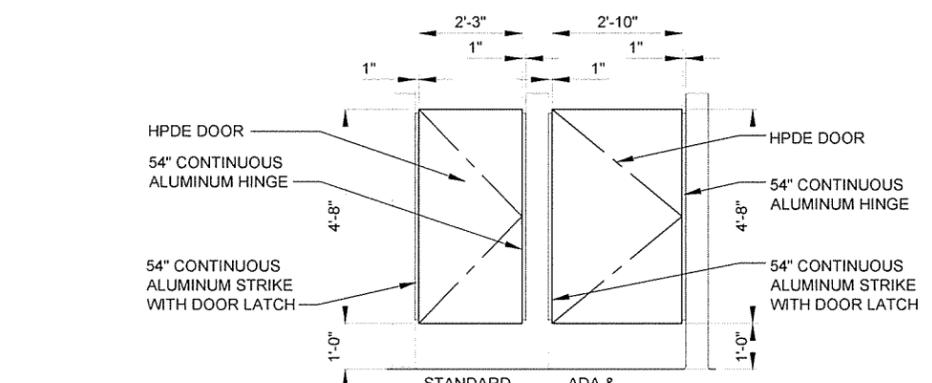

4 HDPE TOILET STALL DOOR ELEVATIONS
 SCALE: 1/2" = 1'-0"

GENERAL NOTES


1. ALL DIMENSIONS TO FACE OF CMU UNLESS NOTED OTHERWISE
2. SEE CIVIL SHEETS FOR ORIENTATION OF BUILDING ON SITE
3. SEE SHEET A-002 FOR MATERIAL AND COLOR LEGENDS

KEYED NOTES

- 1 BABY CHANGING PLATFORM, SEE 3/A-103 FOR DETAIL
- 2 6" CMU PARTITION, TYPICAL ALL STALLS AND SCREENS, SEE 2/A-103 FOR DETAIL
- 3 DASHED LINE INDICATES ROOF OVERHANG ABOVE

LEGEND

- 100 DOOR NUMBERS
- Window Symbols
- ADA FLOOR CLEARANCES
- ADA COMPLIANT STALL
- ADA AMBULATORY COMPLIANT STALL
- FE FIRE EXTINGUISHER AND SEMI-RECESSED CABINET
- FD FLOOR DRAIN

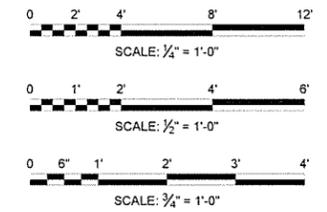

GARVER
 4701 Northshore Drive
 11 Little Rock, AR 72118
 501-378-3633
 www.GarverUSA.com

REGISTERED ARCHITECT
 Garver, LLC
 License No. LL1111
 STATE OF ARKANSAS


REGISTERED ARCHITECT
 Greg A. Archer
 License No. 25715
 STATE OF ARKANSAS

ISSUED FOR CONSTRUCTION	JRR	Appr.
Date	10/11/15	
Symbol	IFC	
Description		


Submitted by	Job Number
John T. Valens, III, PE, SE Director, Federal Services	060451
Plot Date	Plot Scale
10/11/15	1:1
Drawn by	Checked by
J. RAMBEY	G. ARCHER
File Name	ARTISVR-A-103.DWG

ARKANSAS HIGHWAY AND TRANSPORTATION DEPARTMENT
 ARKANSAS TOURIST INFORMATION CENTER
 (WHITE RIVER) (S)
 JOB 061451
 TOURIST INFORMATION CENTER
 PARTIAL ENLARGED FLOOR PLAN

Sheet Reference Number:
A-103
 Sheet 38 of 130

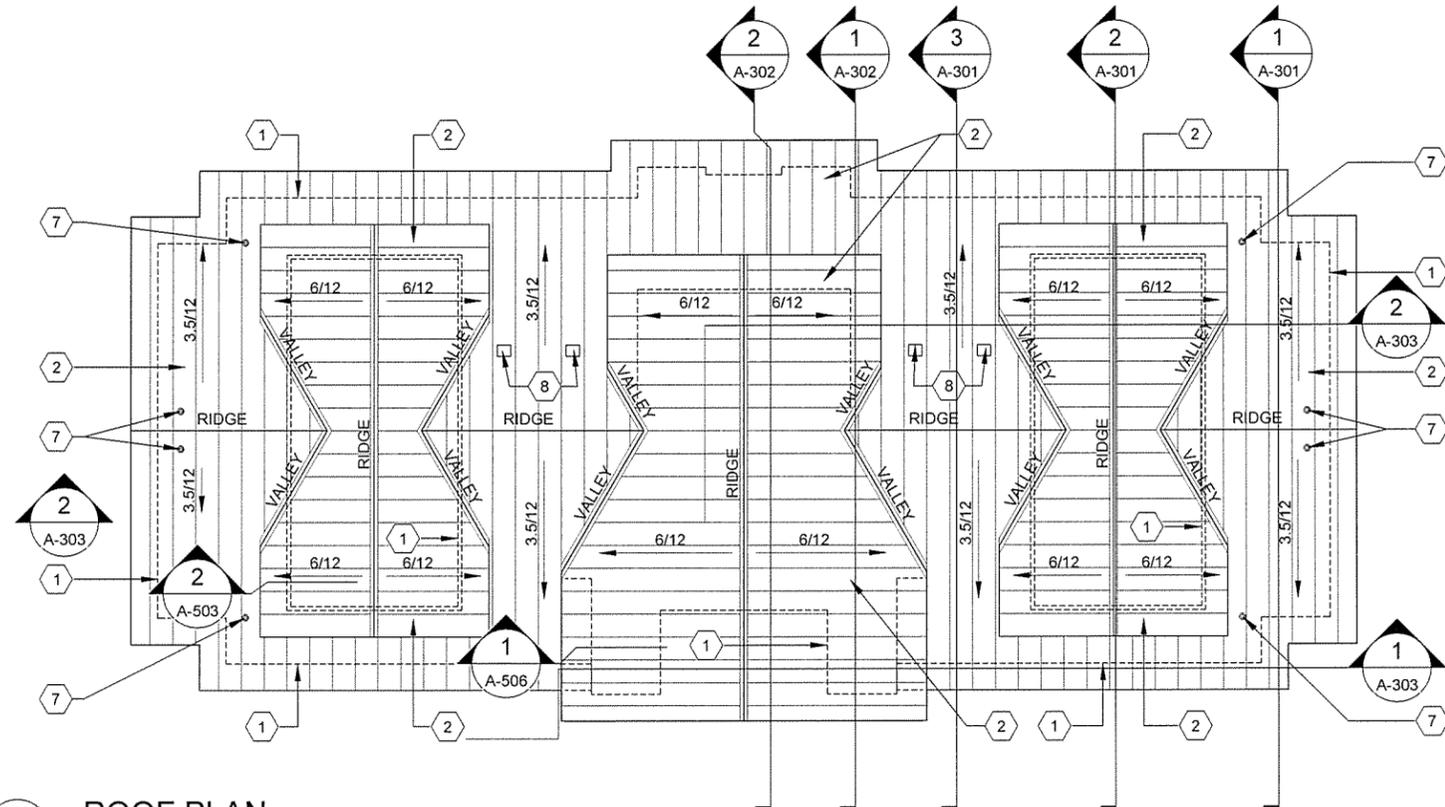

1 ROOF PLAN
 SCALE: 1/8" = 1'-0"
 PLAN NORTH

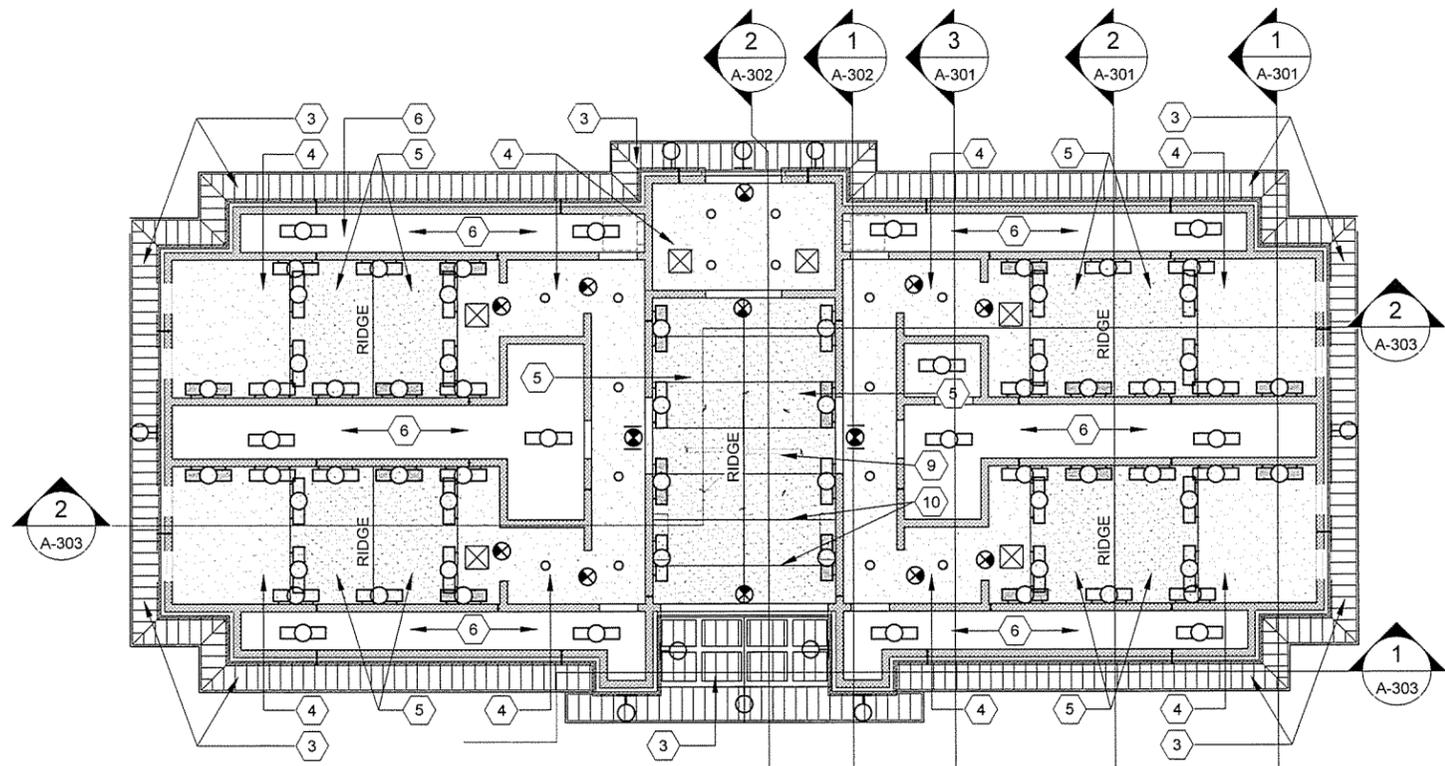

2 REFLECTED CEILING PLAN
 SCALE: 1/8" = 1'-0"
 PLAN NORTH

KEYED NOTES


- 1 DASHED LINE INDICATES WALL BELOW
- 2 PRE-FINISHED METAL ROOF - RP1
- 3 PRE-FINISHED METAL SOFFIT - PERFORATED - MS1
- 4 GYPSUM BOARD CEILING. SEE FINISH SCHEDULE
- 5 SLOPED GYPSUM BOARD CEILING. SEE FINISH SCHEDULE
- 6 OPEN TO DECK ABOVE
- 7 ROOF VENT. SEE PLUMBING DRAWINGS
- 8 ROOF HOOD, CENTER IN METAL ROOF PAN, SEE MECHANICAL
- 9 CEILING FAN. SEE ELECTRICAL
- 10 GYPSUM BOARD CONTRL JOINTS, COORDINATE LOCAITON WITH ARCHITECT/OWNER

GENERAL NOTES

- 1. SEE CIVIL SHEETS FOR ORIENTATION OF BUILDING ON SITE
- 2. SEE SHEET A-002 FOR MATERIAL AND COLOR LEGENDS

LEGEND


- [Symbol] GYPSUM BOARD CEILING, PAINT FINISH. SEE FINISH SCHEDULE
- [Symbol] PREFINISHED METAL SOFFIT - PERFORATED, MS1
- [Symbol] NO CEILING - EXPOSED STRUCTURE
- [Symbol] 2 X 4 WALL MOUNTED FLUORESCENT LIGHT FIXTURE
- [Symbol] 2 X 4 WALL MOUNTED FLUORESCENT EMERGENCY LIGHT FIXTURE
- [Symbol] 2 X 4 PENDANT MOUNTED FLUORESCENT LIGHT FIXTURE
- [Symbol] EXIT FIXTURE
- [Symbol] RETURN GRILLE
- [Symbol] SUPPLY GRILLE

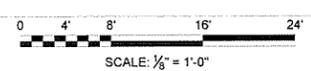

Job Number	060451	JRR
Submitted by	John T. Watkins, III, P.E., S.E. Director, Federal Services	Appr.
Drawn by	J. RAMSEY	Date
Checked by	G. ARCHER	10/1/15
File Name	AH15WR-A-104.DWG	ISSUED FOR CONSTRUCTION
		Symbol
		Description

Designed by	J. RAMSEY	Plot Scale	1:1
Drawn by	J. RAMSEY	Plot Date	10/1/15
Checked by	G. ARCHER	Draw Code	
Job Number	060451	N/A	N/A
Submitted by	John T. Watkins, III, P.E., S.E. Director, Federal Services	N/A	N/A

ARKANSAS HIGHWAY AND TRANSPORTATION DEPARTMENT
 ARKANSAS TOURIST INFORMATION CENTER
 (WHITE RIVER) (S)
 JOB 061451
 TOURIST INFORMATION CENTER
 ROOF AND REFLECTED CEILING PLANS

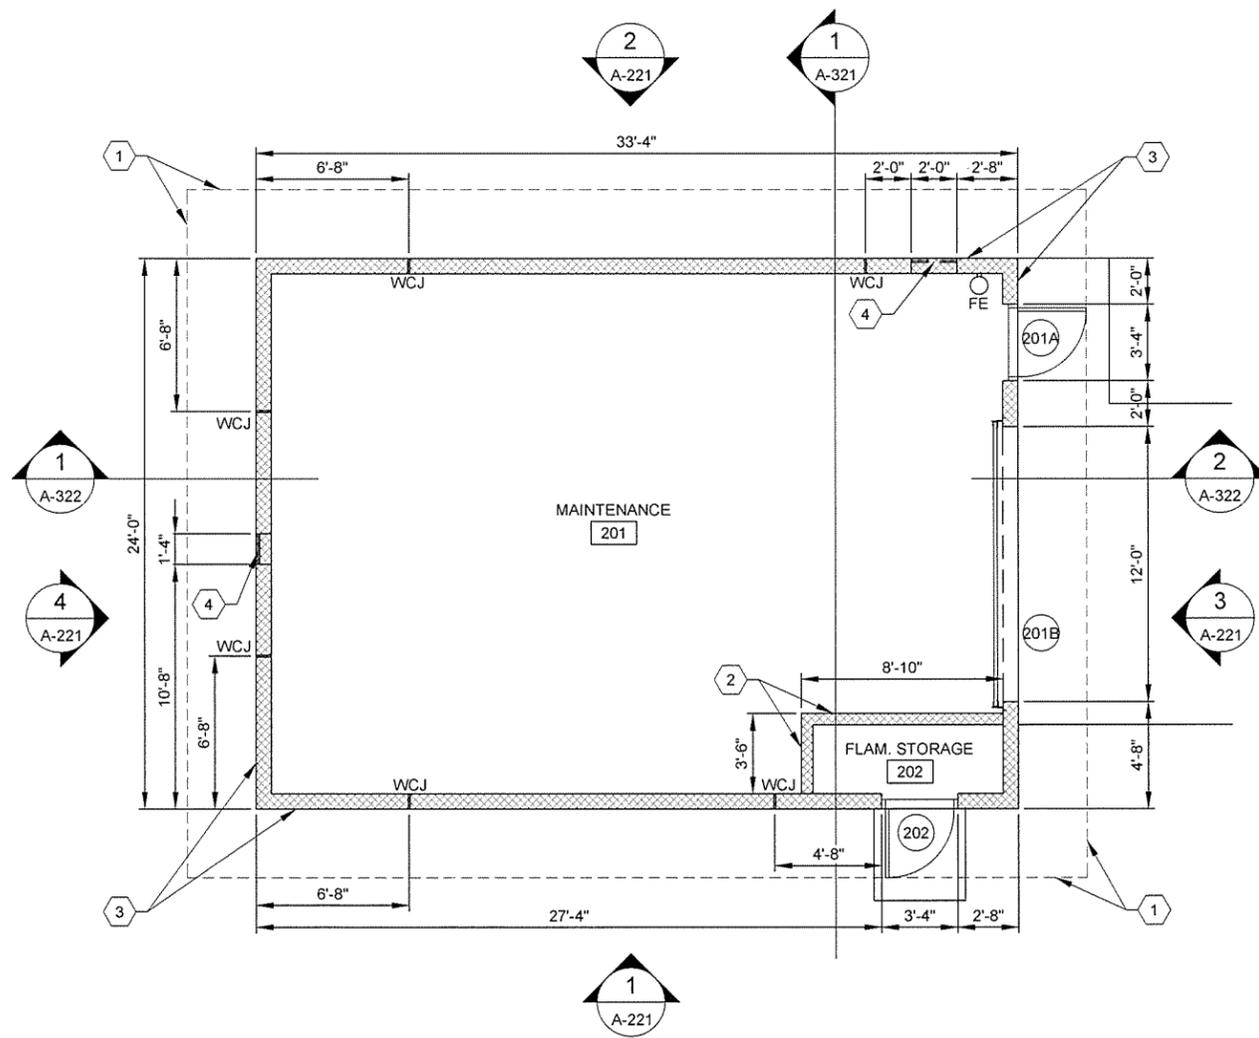

1
A-121

FLOOR PLAN

SCALE: 1/4" = 1'-0"

GENERAL NOTES


1. ALL DIMENSIONS TO FACE OF CMU UNLESS NOTED OTHERWISE
2. SEE CIVIL SHEETS FOR ORIENTATION OF BUILDING ON SITE
3. SEE SHEET A-002 FOR MATERIAL AND COLOR LEGENDS

KEYED NOTES

- ① DASHED LINE INDICATES ROOF OVERHAND ABOVE
- ② 6" CMU WALL
- ③ 8" CMU WALL WITH INTEGRAL WALL REPELLANT AND SEALER
- ④ LOUVER, SEE MECHANICAL DRAWINGS

LEGEND

- ⑩ DOOR NUMBERS
- FE ○ FIRE EXTINGUISHER - WALL HUNG, HOOK MOUNTED
- WCJ | WALL CONTROL JOINT

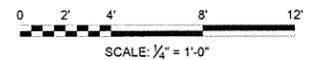

4701 Northshore Drive
N Little Rock, AR 72118
501-376-3633
www.GarverUSA.com



ISSUED FOR CONSTRUCTION	JRR
Date	10/1/15
Appr.	
IFC Symbol	


Job Number	060451
Submitted by	John T. Watkins, III, PE, SE Director, Federal Services
Plot Scale	1:1
Plot Date	10/1/15
Drawn by	J. RAMSEY
Checked by	G. ARCHER
File Name	AH18VR-A-121.DWG

ARKANSAS HIGHWAY AND TRANSPORTATION DEPARTMENT
ARKANSAS TOURIST INFORMATION CENTER
(WHITE RIVER) (S)
JOB 061451
**MAINTENANCE BUILDING
FLOOR PLAN**


Sheet Reference Number:

A-121

Sheet 40 of 130

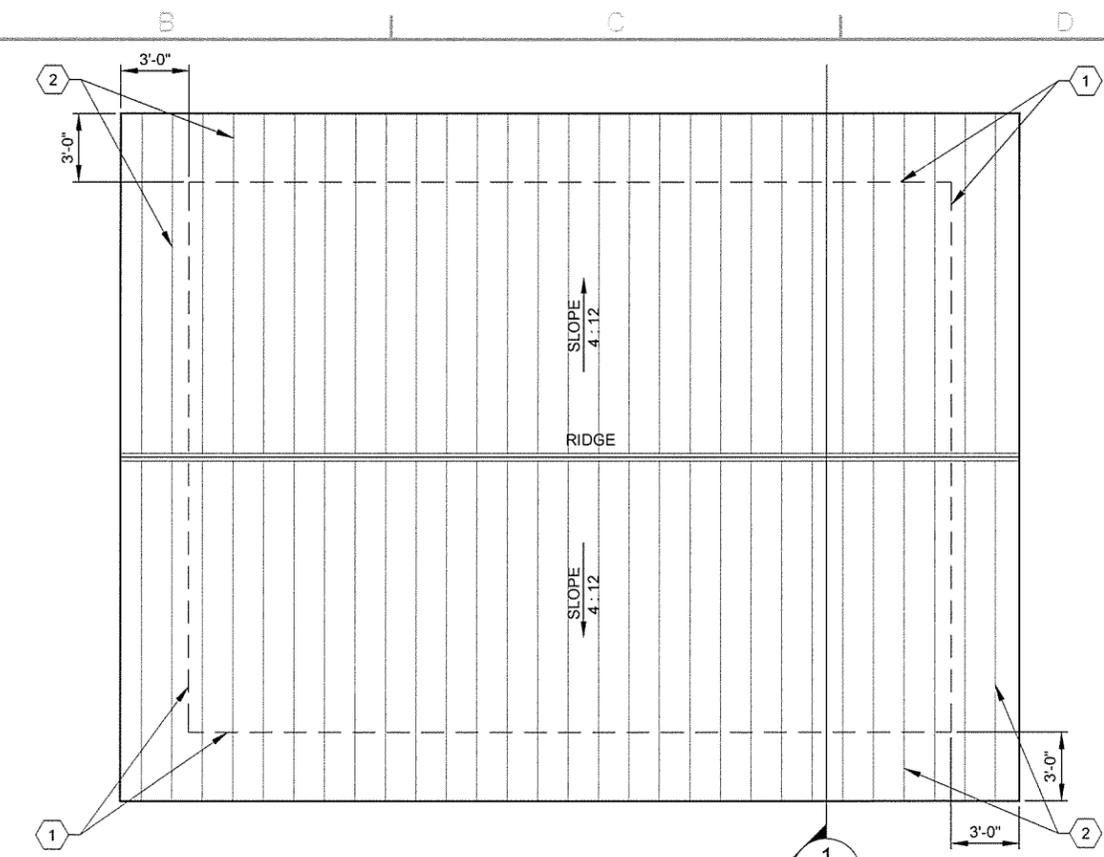

1 ROOF PLAN
 SCALE: 1/4" = 1'-0"
 PLAN NORTH

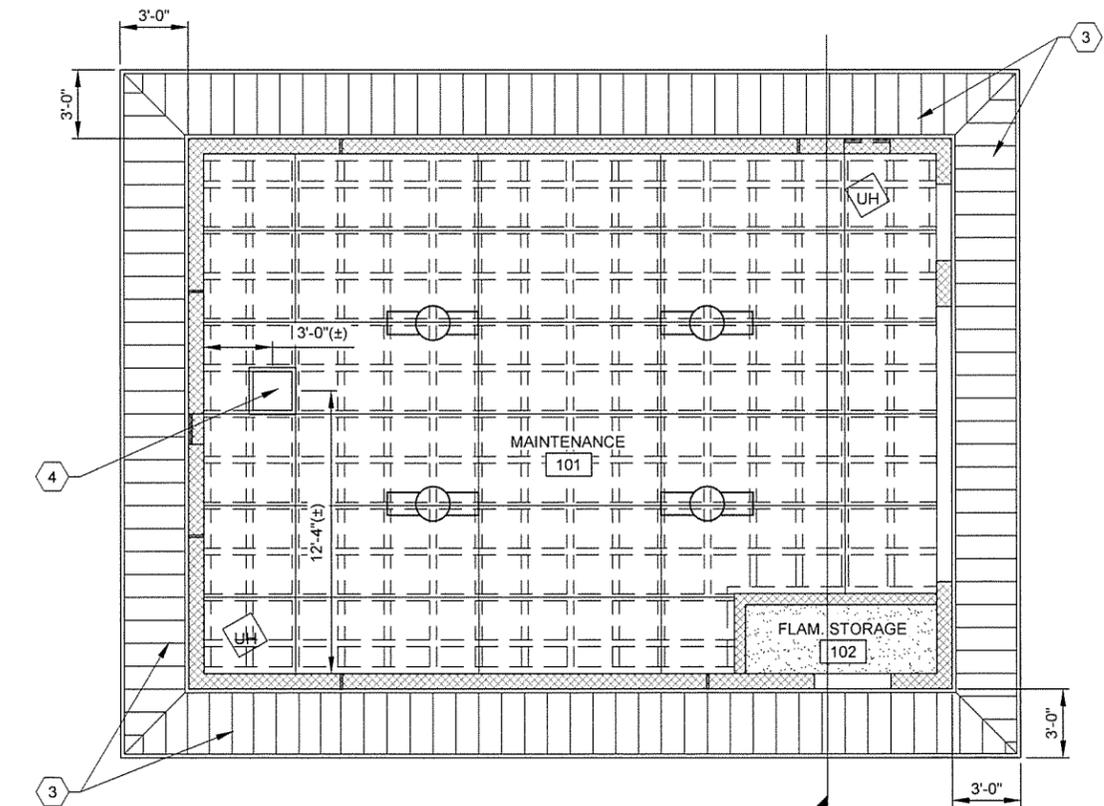

2 REFLECTED CEILING PLAN
 SCALE: 1/4" = 1'-0"
 PLAN NORTH

GENERAL NOTES


1. ALL DIMENSIONS TO FACE OF CMU UNLESS NOTED OTHERWISE
2. SEE CIVIL SHEETS FOR ORIENTATION OF BUILDING ON SITE
3. SEE SHEET A-002 FOR MATERIAL AND COLOR LEGENDS

KEYED NOTES

- 1 DASHED LINE INDICATES WALL BELOW OR ROOF EDGE ABOVE
- 2 PRE-FINISHED METAL ROOF - RP1
- 3 PRE-FINISHED METAL SOFFIT - PERFORATED - MS1
- 4 20" x 20" LIFT-OUT CEILING ACCESS PANEL. ADJUST FINAL LOCATION TO FIT CEILING FRAMING

LEGEND

- CONCRETE CEILING, PAINT FINISH. SEE FINISH SCHEDULE
- 4' x 8' MOISTURE RESISTANT GYPSUM BOARD CEILING. SEE FINISH SCHEDULE
- METAL FRAMING ABOVE. SEE WALL SECTIONS
- 2 X 4 SURFACE MOUNTED FLUORESCENT LIGHT FIXTURE
- EXIT FIXTURE
- UNIT HEATER, SEE MECHANICAL DRAWINGS

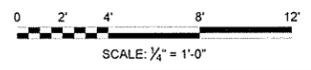

JRR	Appr.
10/1/15	Date
ISSUED FOR CONSTRUCTION	Description
IFC	Symbol

Submitted by	Job Number
John T. Walkers, III, PE, SE Director, Federal Services	060451
Drawn by	Plot Scale
J. RAMSEY	N/A
Checked by	Drwg Code
G. ARCHER	N/A
Designed by	File Name
J. RAMSEY	AH15VR-A-122.DWG

ARKANSAS HIGHWAY AND TRANSPORTATION DEPARTMENT
 ARKANSAS TOURIST INFORMATION CENTER
 (WHITE RIVER) (S)
 JOB 061451
 MAINTENANCE BUILDING
 REFLECTED CEILING AND ROOF PLANS

Sheet Reference Number:
A-122
 Sheet 41 of 130

A B C D E F

GENERAL NOTES

1. ALL DIMENSIONS TO FACE OF CMU UNLESS NOTED OTHERWISE
2. SEE CIVIL SHEETS FOR ORIENTATION OF BUILDING ON SITE
3. SEE SHEET A-002 FOR MATERIAL AND COLOR LEGENDS




KEYED NOTES


- ① DASHED LINE INDICATES ROOF OVERHANG ABOVE
- ② 6" CMU DIVIDER WALL
- ③ 8" CMU WALL
- ④ ALUMINUM WINDOWS, HIGH., WITH FROSTED GLAZING, SEE ELEVATIONS, SHEET A-004
- ⑤ RECESSED DISPLAY BOARD, SEE ALLOWANCE NO.1; SECTION 012100 - ALLOWANCES
- ⑥ ADA COMPLIANT DRINKING FOUNTAIN, SEE PLUMBING

LEGEND

- ⑩ DOOR NUMBERS
- Ⓐ WINDOW SYMBOLS
- ADA FLOOR CLEARANCES
- FE FIRE EXTINGUISHER AND SEMI-RECESSED CABINET
- FD FLOOR DRAIN
- ADA ADA COMPLIANT STALL
- WCJ WALL CONTROL JOINT, CMU AND MANUFACTURED STONE MASONRY

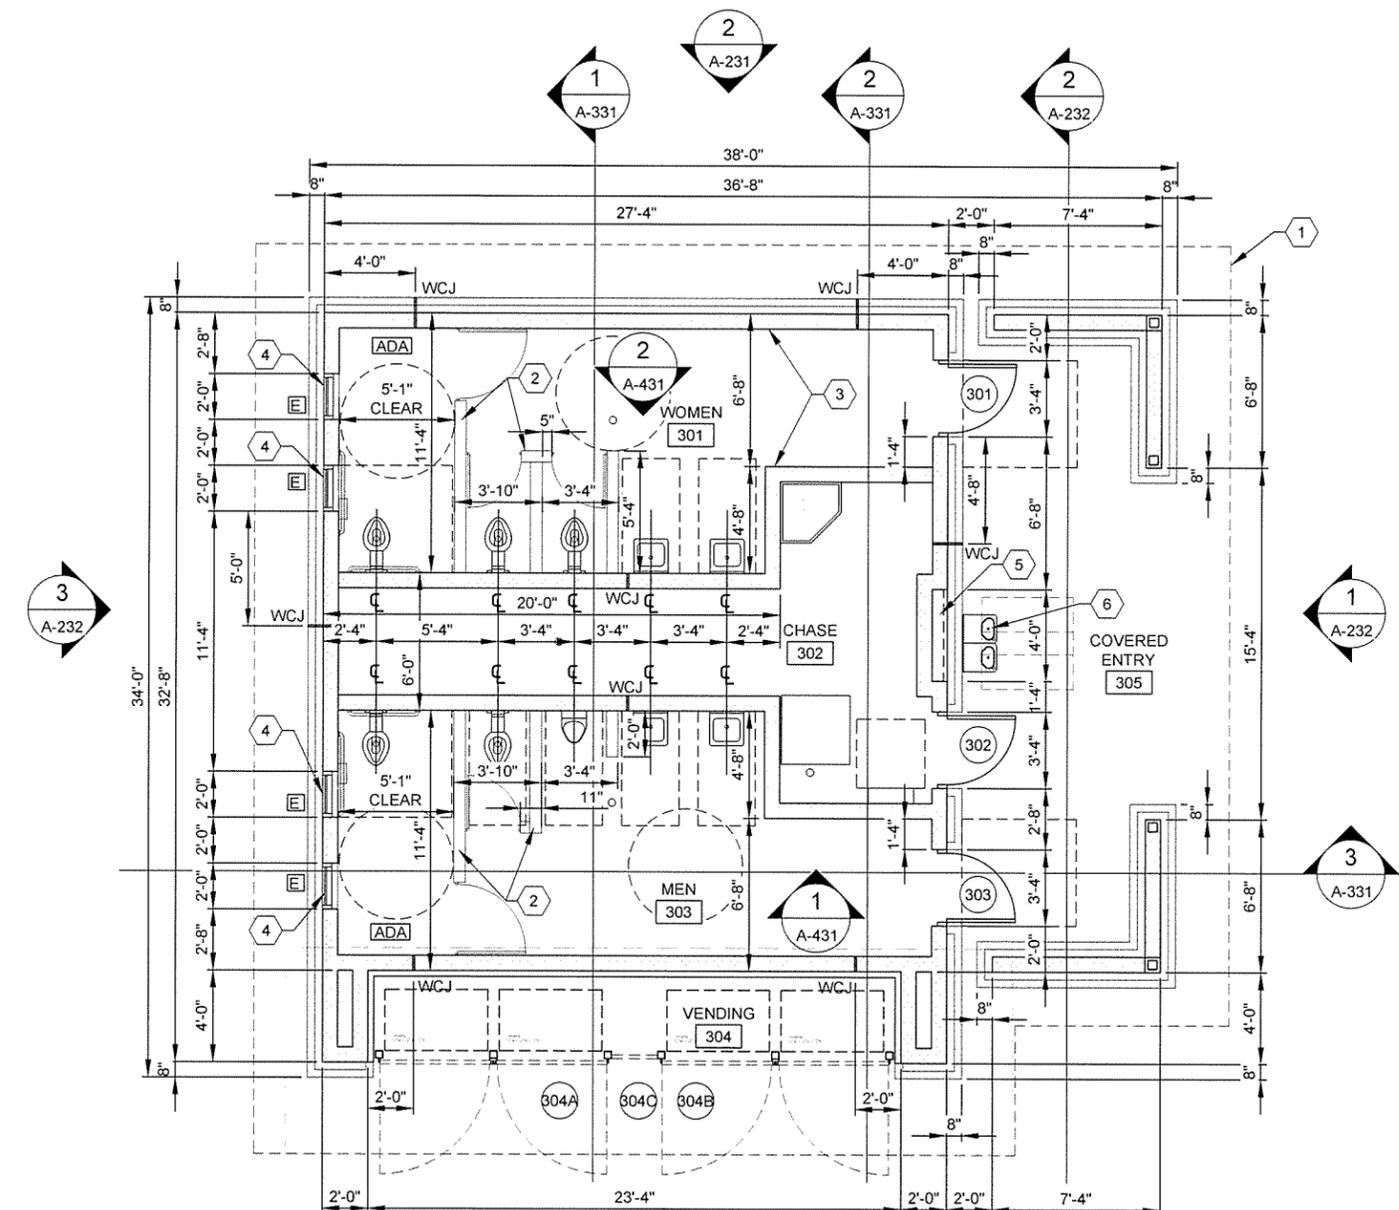

FLOOR PLAN
SCALE: 1/4" = 1'-0"
PLAN NORTH

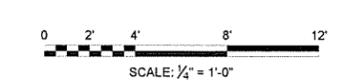


JRR	Appr.
10/1/15	Date

ISSUED FOR CONSTRUCTION	Description
IFC	Symbol


Submitted by:	John T. Watkins, III, P.E., SE	Director, Federal Services	Job Number:	000451
Designed by:	J. RAMSEY		Drawn by:	J. RAMSEY
Plot Date:	10/1/15	Plot Scale:	1:1	Drwg Code:
Checked by:	G. ARCHER	File Name:	A115WR-A-131.DWG	

ARKANSAS HIGHWAY AND TRANSPORTATION DEPARTMENT
 ARKANSAS TOURIST INFORMATION CENTER
 (WHITE RIVER) (S)
 JOB 051451
TRUCKER-VENDING BUILDING FLOOR PLAN

Sheet Reference Number:
A-131
 Sheet 42 of 130

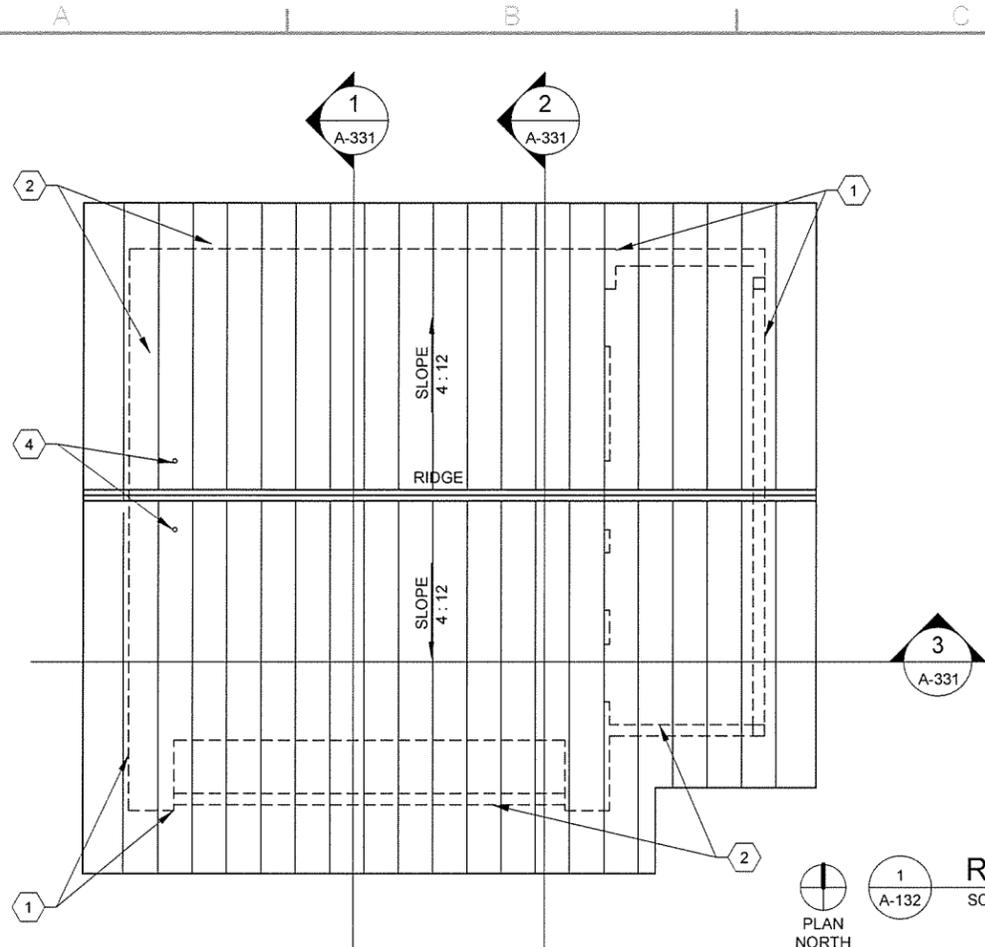

1 A-132
 PLAN NORTH
ROOF PLAN
 SCALE: 3/16" = 1'-0"

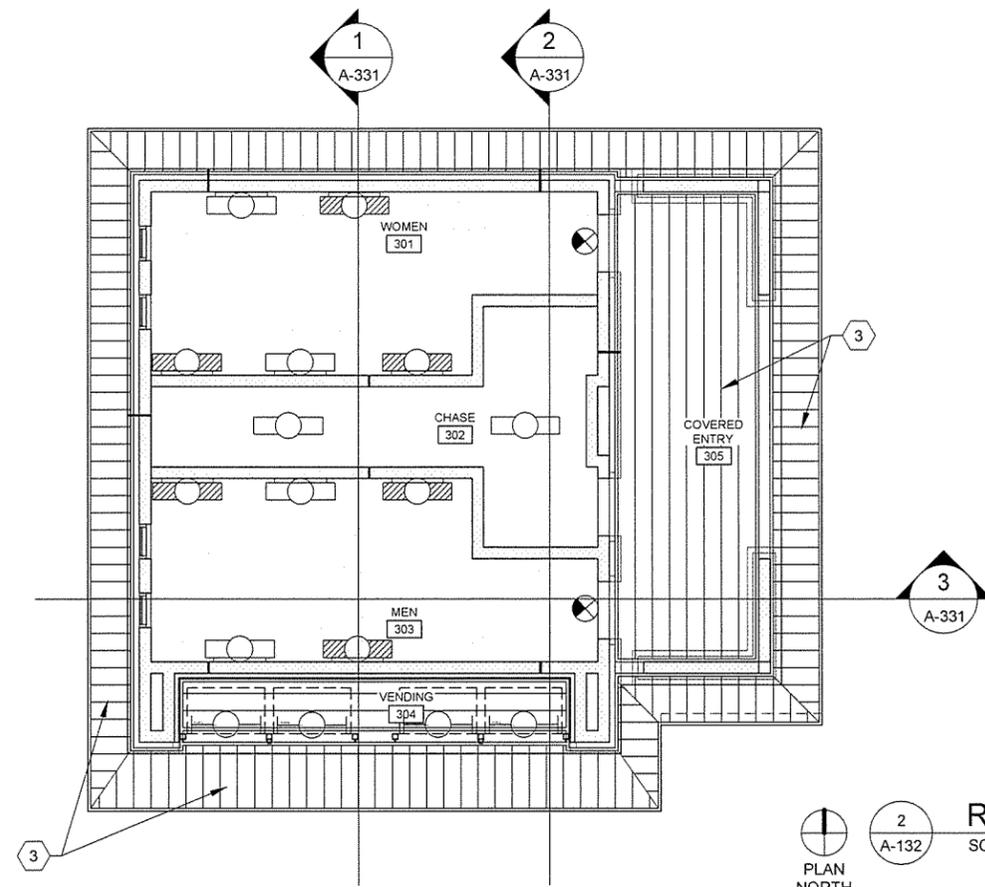

2 A-132
 PLAN NORTH
REFLECTED CEILING PLAN
 SCALE: 3/16" = 1'-0"

GENERAL NOTES


1. ALL DIMENSIONS TO FACE OF CMU UNLESS NOTED OTHERWISE
2. SEE CIVIL SHEETS FOR ORIENTATION OF BUILDING ON SITE
3. SEE SHEET A-002 FOR MATERIAL AND COLOR LEGENDS

KEYED NOTES

- 1 DASHED LINE INDICATES WALL BELOW OR ROOF EDGE ABOVE
- 2 PRE-FINISHED METAL ROOF - RP1
- 3 PRE-FINISHED METAL SOFFIT - PERFORATED - MS1
- 4 VENT-THRU-ROOF, SEE PLUMBING

LEGEND

	MOISTURE RESISTANT GYPSUM BOARD CEILING, SEE FINISH SCHEDULE
	PERFINISHED METAL SOFFIT - PERFORATED, MS1
	NO CEILING - EXPOSED STRUCTURE
	2 X 4 WALL MOUNTED FLUORESCENT LIGHT FIXTURE
	2 X 4 WALL MOUNTED FLUORESCENT EMERGENCY LIGHT FIXTURE
	2 X 4 PENDANT MOUNTED FLUORESCENT LIGHT FIXTURE
	EXIT FIXTURE
	SURFACE MOUNTED FLUORESCENT FIXTURE
	RETURN GRILLE
	SUPPLY GRILLE

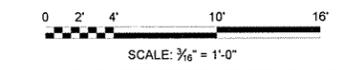


Job Number	000451	JRR	Appr.
Submitted by	John T. Watkins, III, PE, SE Director, Federal Services	Date	10/1/15
Designed by	J. RAMSEY	Issued for Construction	
Drawn by	J. RAMSEY	Description	
Checked by	G. ARCHER	IFC Symbol	
File Name	AHTSWRA-132.DWG		


Submitted by	John T. Watkins, III, PE, SE Director, Federal Services	Plot Scale	1:1
Designed by	J. RAMSEY	Drawn by	J. RAMSEY
Checked by	G. ARCHER	Drwg Code	
File Name	AHTSWRA-132.DWG		

ARKANSAS HIGHWAY AND TRANSPORTATION DEPARTMENT
 ARKANSAS TOURIST INFORMATION CENTER
 (WHITE RIVER) (S)
 JOB 061451

TRUCKER-VENDING BUILDING
 ROOF AND REFLECTED CEILING PLANS

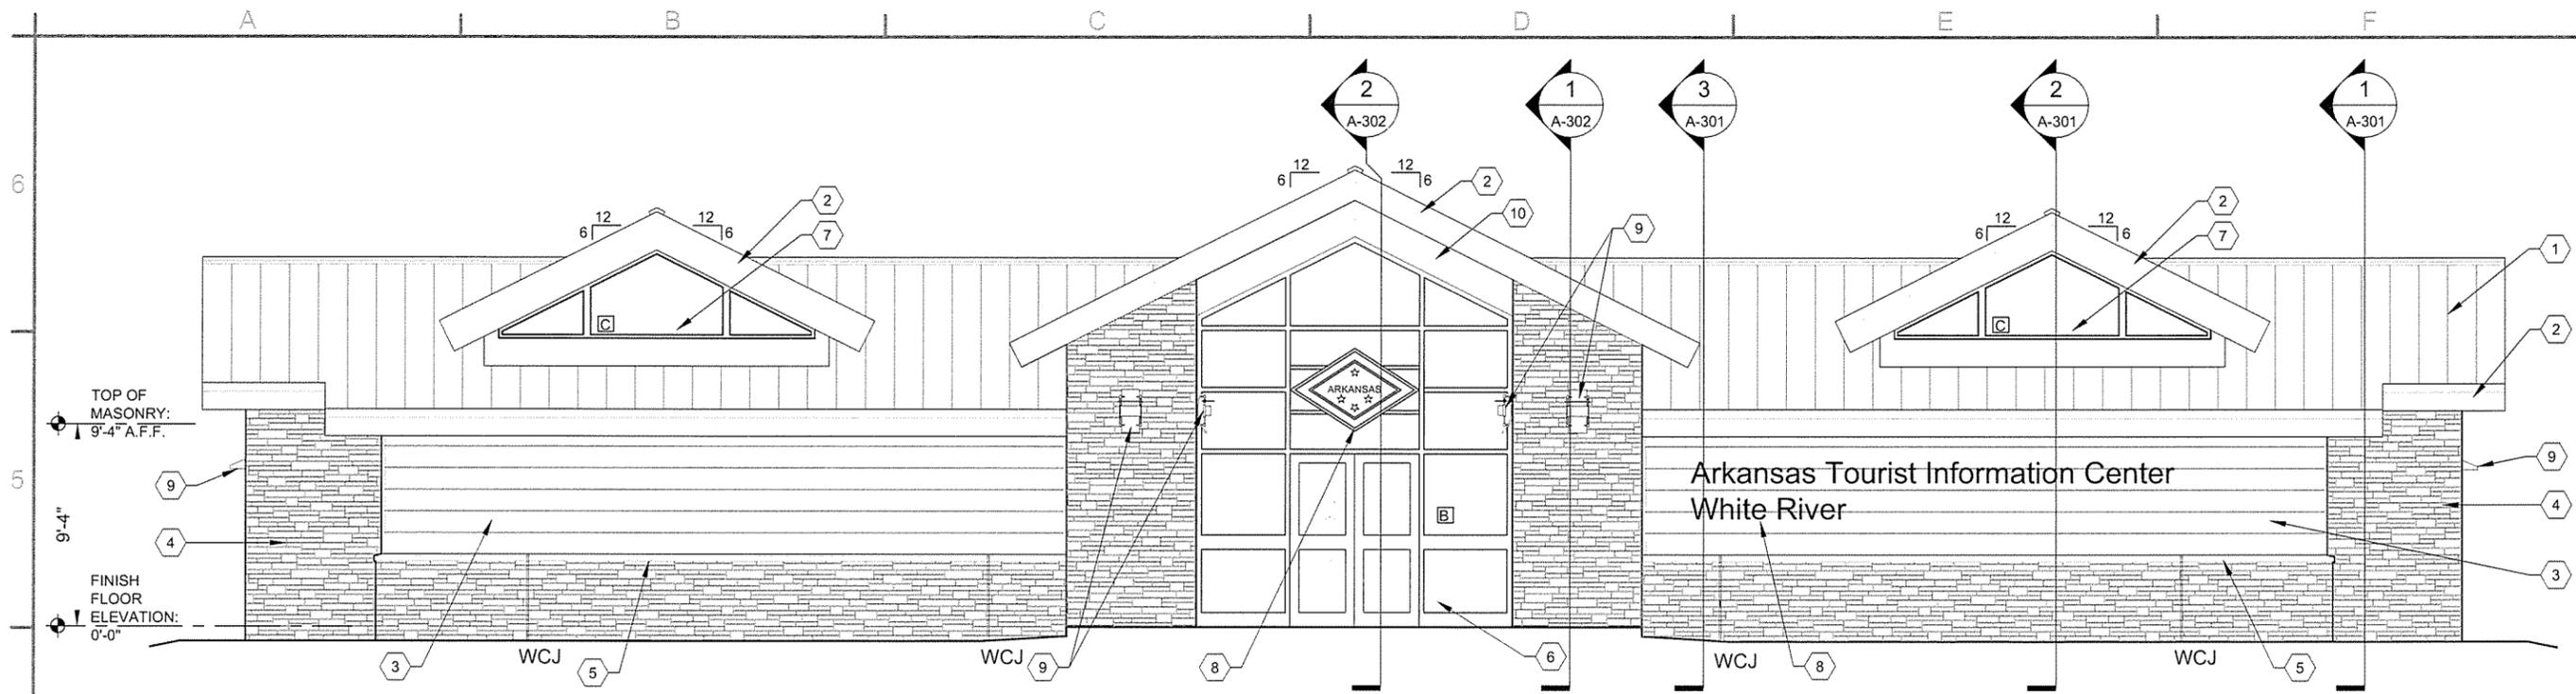

1 FRONT ELEVATION
A-201 SCALE: 1/4" = 1'-0"

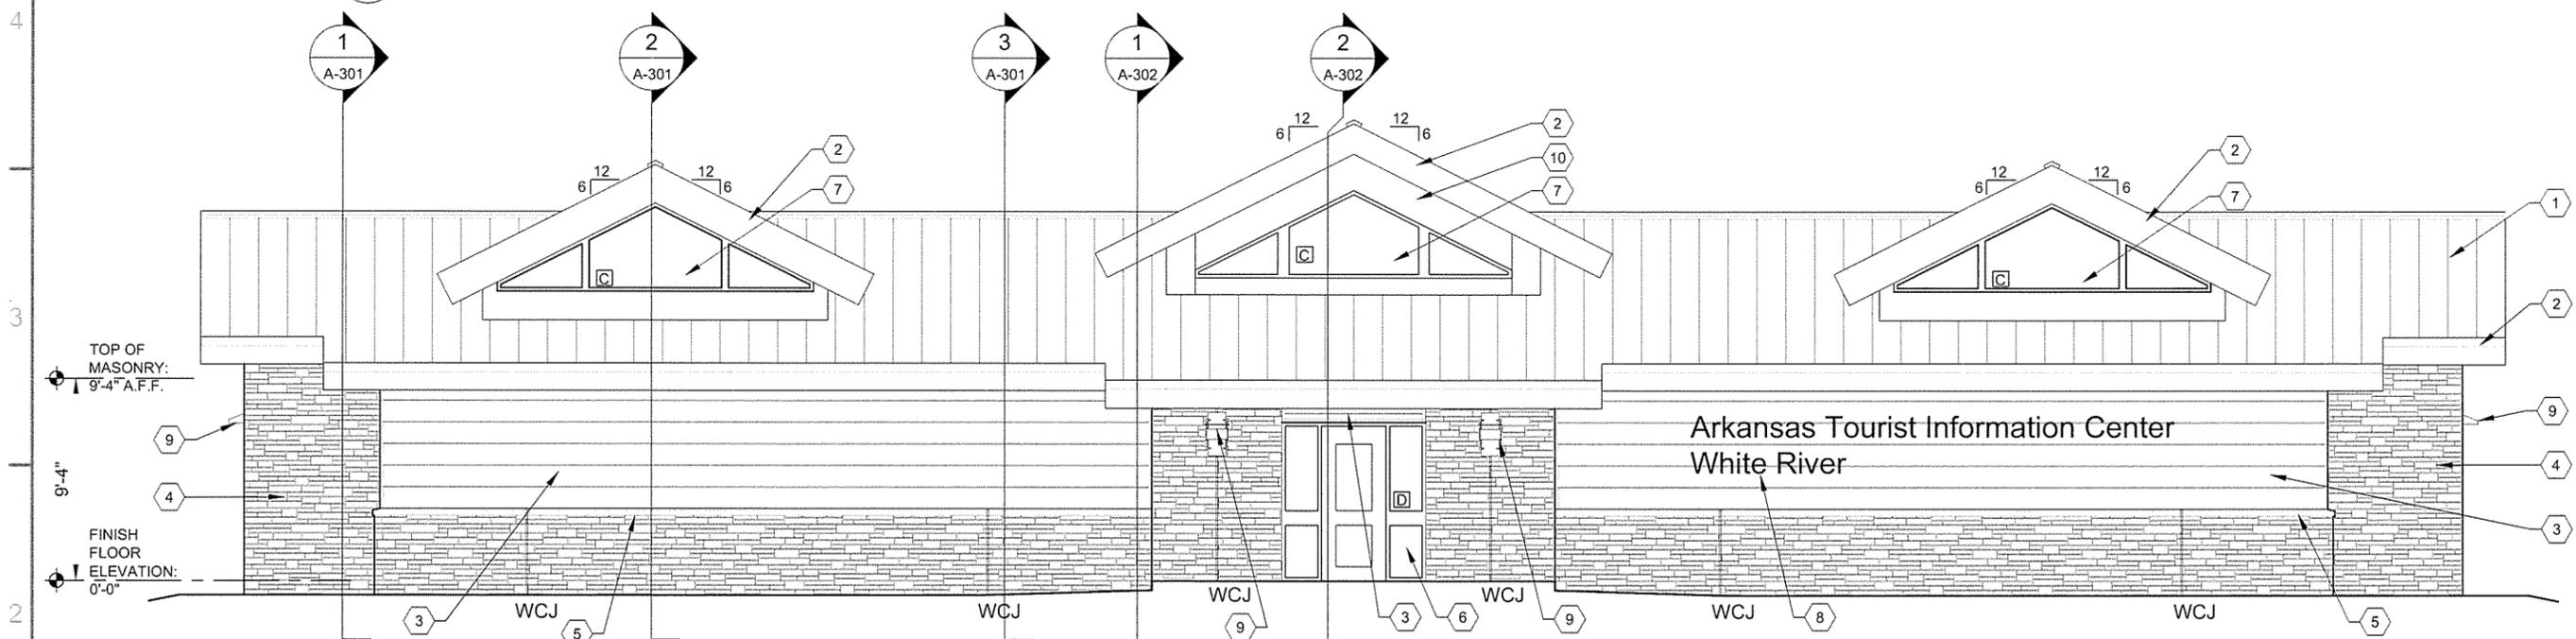

2 BACK ELEVATION
A-201 SCALE: 1/4" = 1'-0"

GENERAL NOTES

- SEE CIVIL SHEETS FOR FINAL GRADE AT EACH BUILDING ON SITE
- SEE SHEET A-002 FOR MATERIAL AND COLOR LEGENDS

KEYED NOTES

- 1 PRE-FINISHED METAL ROOF - RP1
- 2 PRE-FINISHED METAL TRIM FASCIA - MT1
- 3 PRE-FINISHED METAL SIDING - WS1
- 4 MANUFACTURED STONE MASONRY - SW1
- 5 MANUFACTURED STONE MASONRY CAP - SW2
- 6 ALUMINUM STOREFRONT - SF1
- 7 ALUMINUM WINDOWS - WD1

LEGEND

- 8 BUILDING SIGNAGE, SEE ALLOWANCE NO. 1; SECTION 012100 - ALLOWANCES
- 9 LIGHT FIXTURE, SEE ELECTRICAL
- 10 PRE-FINISHED METAL WALL PANEL - MT2
- WCJ WALL CONTROL JOINT, CMU AND MANUFACTURED STONE MASONRY



10/11/15 Date
JRR ASpr


ISSUED FOR CONSTRUCTION Description
IFC Symbol

Submitted by John T. Ramsey Director, Federal Services	Job Number 060451	Scale N/A	Plot Scale 1:1	Job Number N/A
Designed by J. Ramsey	Plot Date 10/12/15	Drawn by J. Ramsey	Drawn Date 10/12/15	Drawn by G. Archer
Checked by G. Archer	File Name AH15WR-A-201.DWG			


ARKANSAS HIGHWAY AND TRANSPORTATION DEPARTMENT
ARKANSAS TOURIST INFORMATION CENTER
(WHITE RIVER) (S)
JOB 061451

TOURIST INFORMATION CENTER
BUILDING ELEVATIONS

Sheet Reference Number:
A-201
Sheet 44 of 130

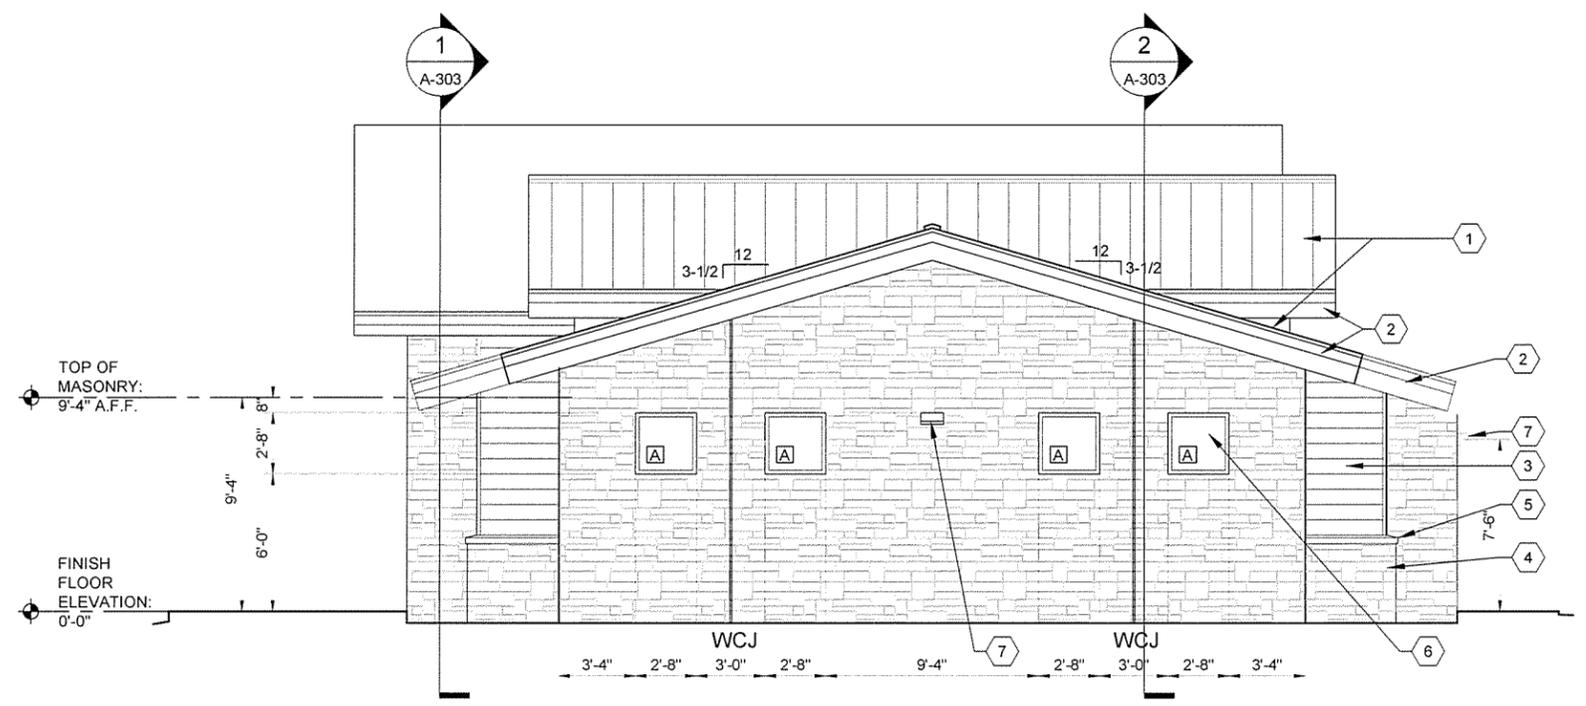

1
A-202
END ELEVATION
SCALE: 1/4" = 1'-0"

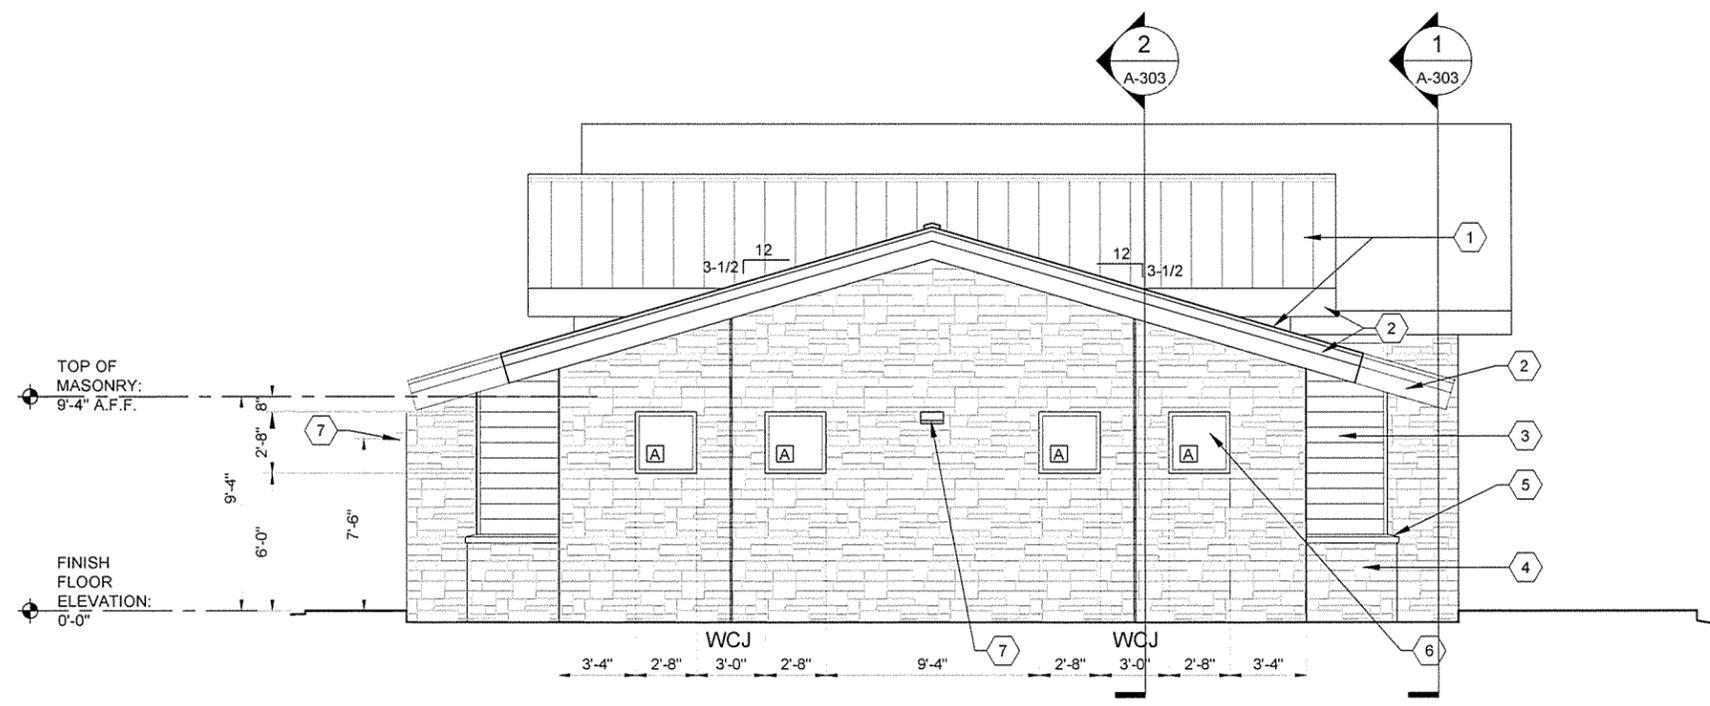

2
A-202
END ELEVATION
SCALE: 1/4" = 1'-0"

GENERAL NOTES

- SEE CIVIL SHEETS FOR FINAL GRADE AT EACH BUILDING ON SITE
- SEE SHEET A-002 FOR MATERIAL AND COLOR LEGENDS

KEYED NOTES

- PRE-FINISHED METAL ROOF - RP1
- PRE-FINISHED METAL TRIM FASCIA - MT1
- PRE-FINISHED METAL SIDING - WS1
- MANUFACTURED STONE MASONRY - SW1
- MANUFACTURED STONE MASONRY CAP - SW2
- ALUMINUM WINDOWS - WD1
- LIGHTING, SEE ELECTRICAL DRAWINGS

LEGEND


WCJ WALL CONTROL JOINT, CMU AND MANUFACTURED STONE MASONRY




IFC Symbol	Issued For Construction	Date	JRR	Appr.
		10/1/15		

Job Number	060451
Submitted by	John T. Walkers, III, PE, SE Director, Federal Services
Plot Date	10/1/15
Plot Scale	1:1
Drawn by	J. RAMSEY
Checked by	G. ARCHER
File Name	AH15WR-A-302.DWG


ARKANSAS HIGHWAY AND TRANSPORTATION DEPARTMENT
 ARKANSAS TOURIST INFORMATION CENTER
 (WHITE RIVER) (S)
 JOB 061451
 TOURIST INFORMATION CENTER
 BUILDING ELEVATIONS

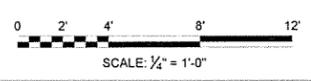

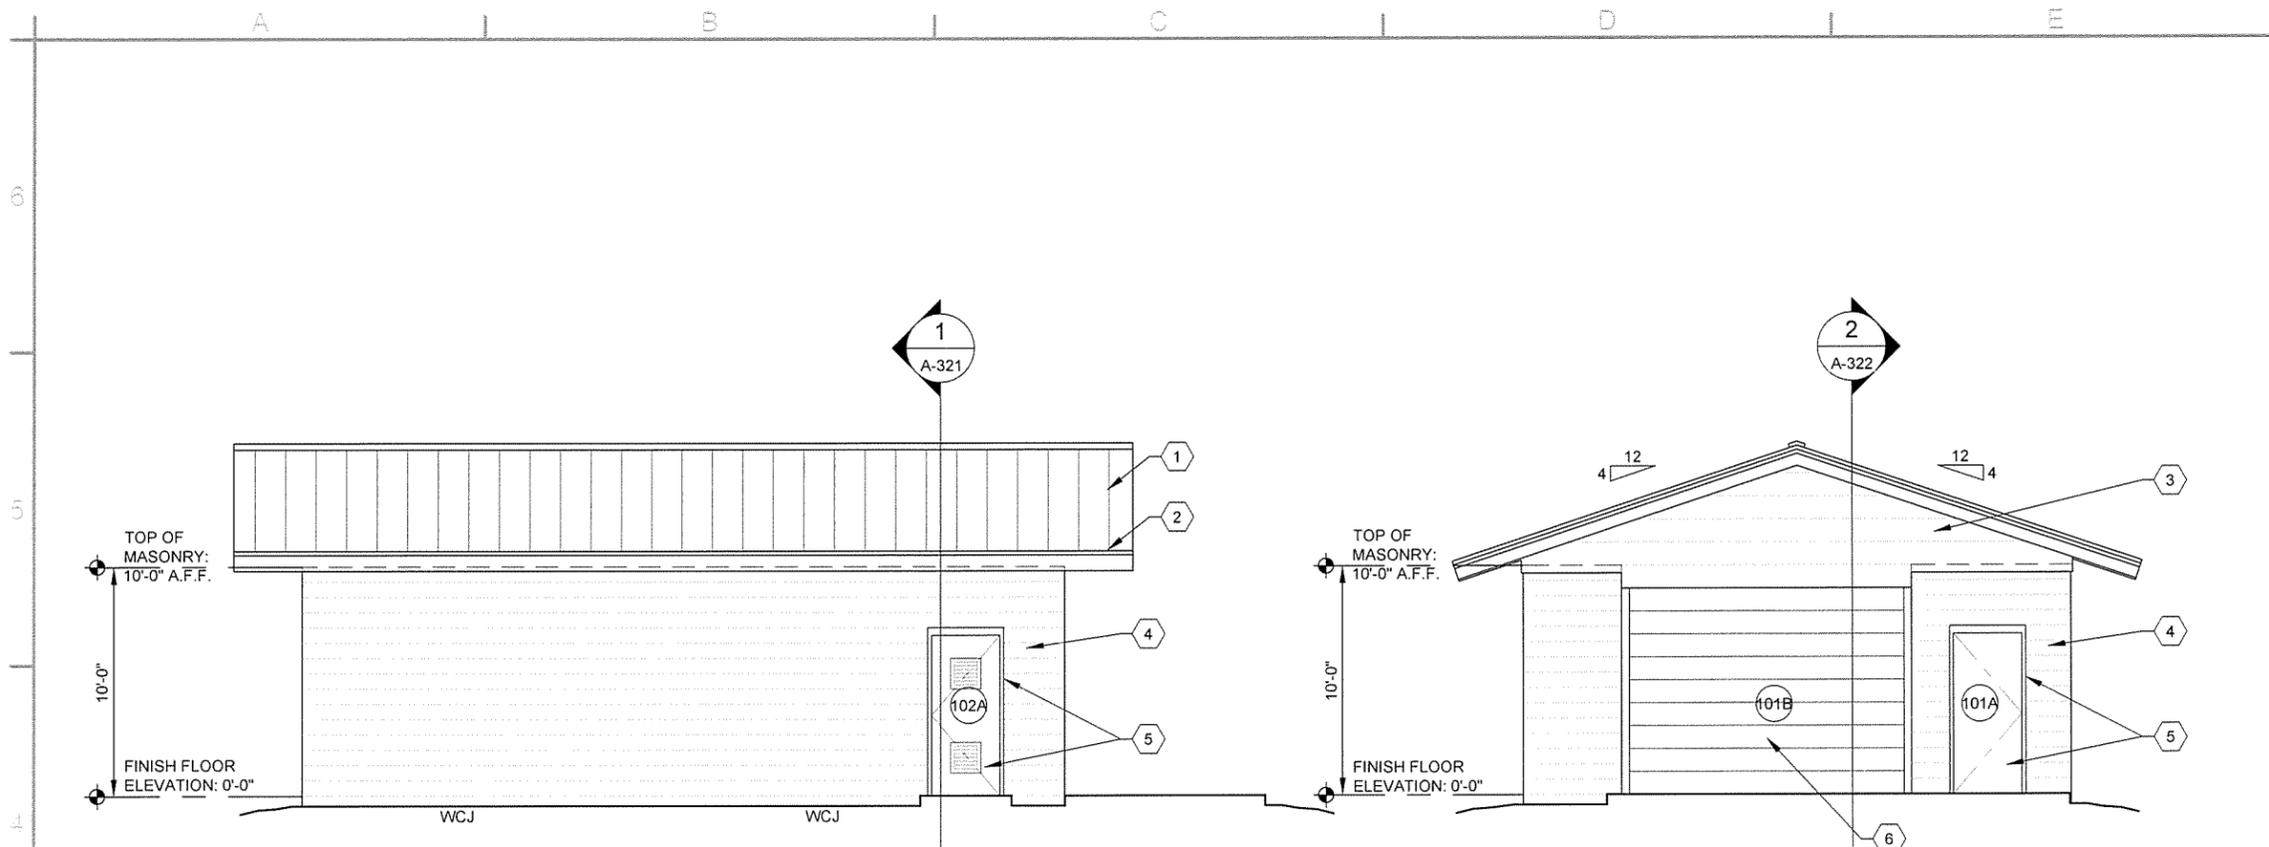


1 SIDE ELEVATION
A-221 SCALE: 1/4" = 1'-0"

3 END ELEVATION
A-221 SCALE: 1/4" = 1'-0"

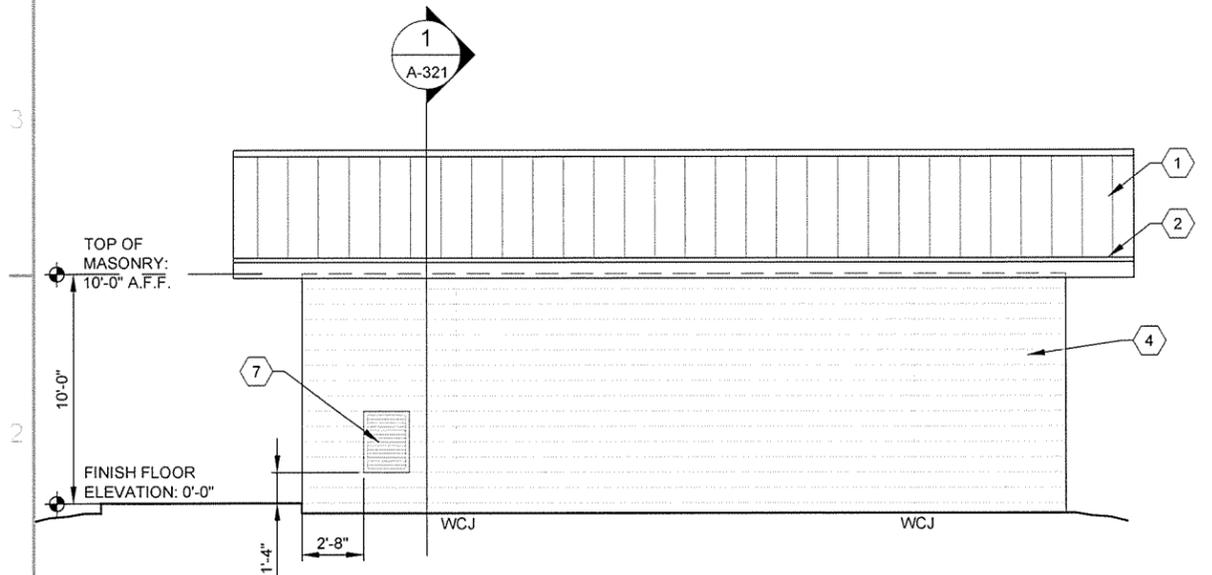

2 SIDE ELEVATION
A-221 SCALE: 1/4" = 1'-0"

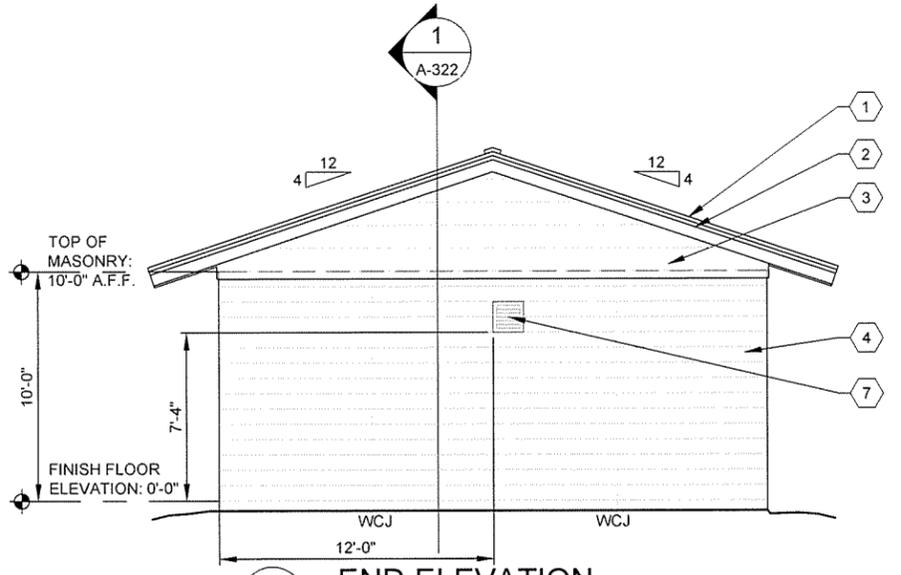

4 END ELEVATION
A-221 SCALE: 1/4" = 1'-0"

GENERAL NOTES


1. ALL DIMENSIONS TO FACE OF CMU UNLESS NOTED OTHERWISE
2. SEE CIVIL SHEETS FOR ORIENTATION OF BUILDING ON SITE
3. SEE SHEET A-002 FOR MATERIAL AND COLOR LEGENDS

KEYED NOTES

- 1 PRE-FINISHED METAL ROOF - RP1
- 2 PRE-FINISHED METAL TRIM FASCIA - MT1
- 3 PRE-FINISHED METAL SIDING - WS1
- 4 8" CMU, INTEGRAL WATER REPELLANT, PAINT AND SEALER
- 5 HOLLOW METAL DOOR AND FRAME - EPT1 & EPT2
- 6 OVERHEAD SECTIONAL DOOR - OHD1
- 7 LOUVER, SEE MECHANICAL DRAWINGS

LEGEND

100 DOOR NUMBERS
WCJ WALL CONTROL JOINT

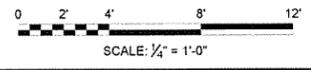


JRR	Date	Description	IFC	Symbol
Appr.	10/1/15	ISSUED FOR CONSTRUCTION		

Job Number 060451	N/A	N/A	N/A
Submitted by John T. Williams, III, P.E., SE Director, Federal Services	Plot Scale 1:1	Plot Date 10/1/15	Draw Code N/A
Designed by J. RAMSEY	Drawn by J. RAMSEY	Checked by G. ARCHER	File Name AHSVR-A-221.DWG


ARKANSAS HIGHWAY AND TRANSPORTATION DEPARTMENT
ARKANSAS TOURIST INFORMATION CENTER
(WHITE RIVER) (S)
JOB 061451
MAINTENANCE BUILDING
ELEVATIONS

Sheet Reference Number:
A-221
Sheet 46 of 130

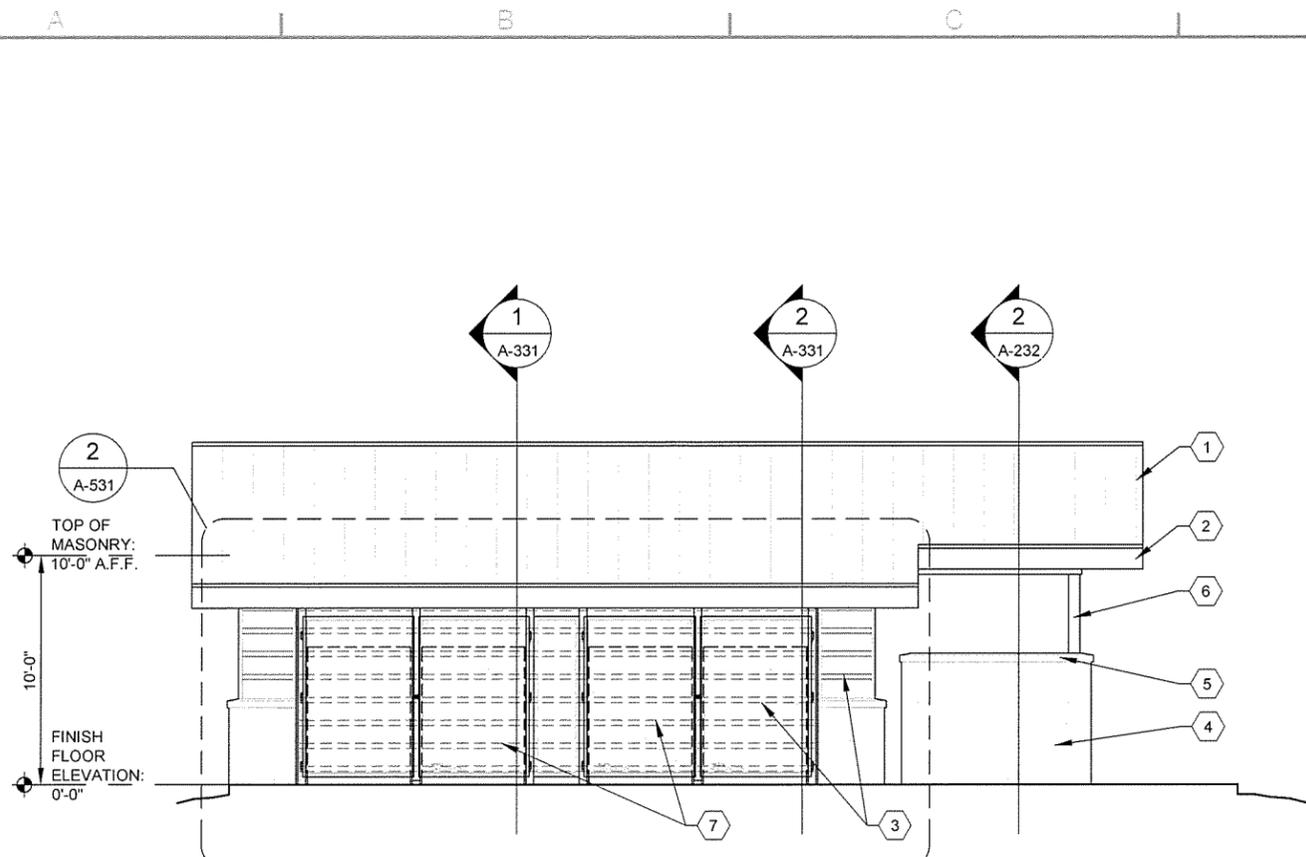

SIDE ELEVATION

SCALE: 1/4" = 1'-0"

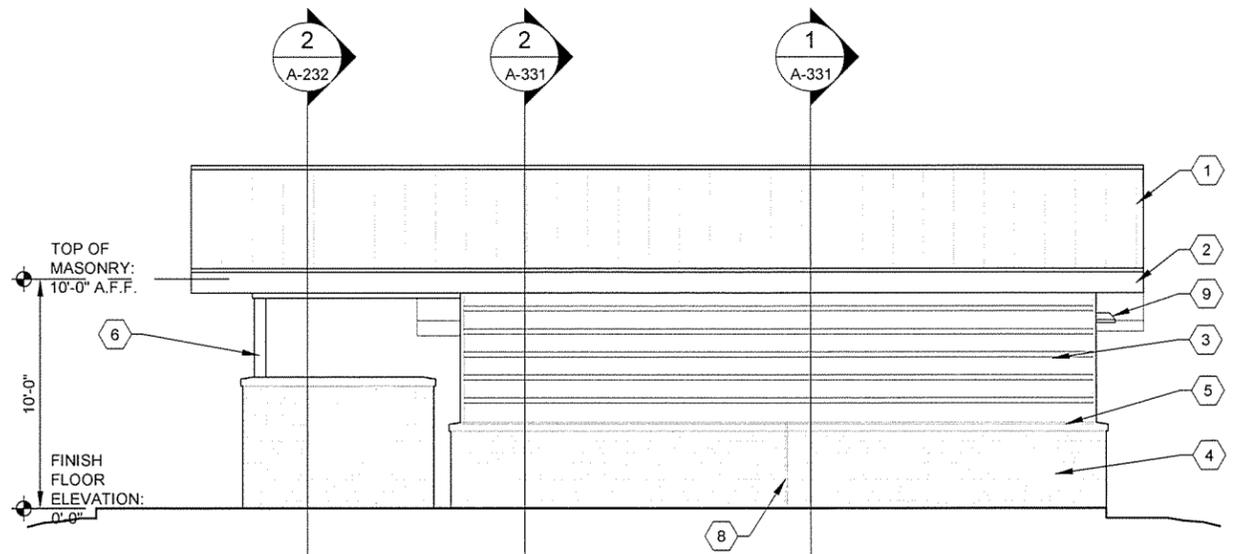

SIDE ELEVATION

SCALE: 1/4" = 1'-0"

GENERAL NOTES

1. SEE CIVIL SHEETS FOR FINAL GRADE AT EACH BUILDING ON SITE
2. SEE SHEET A-002 FOR MATERIAL AND COLOR LEGENDS



KEYED NOTES


- 1 PRE-FINISHED METAL ROOF - RP1
- 2 PRE-FINISHED METAL TRIM FASCIA - MT1
- 3 PRE-FINISHED METAL SIDING - WS1
- 4 MANUFACTURED STONE
- 5 MANUFACTURED STONE CAP
- 6 COLUMN, SEE STRUCTURAL - EPT1
- 7 VENDING SECURITY GATE AND FRAME - PT6
- 8 WALL CONTROL JOINT, CMU AND MANUFACTURED STONE MASONRY
- 9 LIGHT FIXTURE, SEE ELECTRICAL

ISSUED FOR CONSTRUCTION	Date	JRR	Appr
	10/11/15		

Job Number	Submitted by	Plot Date	Plot Scale	Drwg Code	File Name
060451	John T. Watkins, III, P.E., SE Director, Federal Services	10/11/15	1:1		ARTISWR-A-231.DWG

ARKANSAS HIGHWAY AND TRANSPORTATION DEPARTMENT
 ARKANSAS TOURIST INFORMATION CENTER
 (WHITE RIVER) (S)
 JOB 061451

TRUCKER-VENDING BUILDING
 BUILDING ELEVATIONS

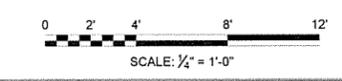

Sheet Reference Number:

A-231

Sheet 47 of 130

GENERAL NOTES

1. SEE CIVIL SHEETS FOR FINAL GRADE AT EACH BUILDING ON SITE
2. SEE SHEET A-002 FOR MATERIAL AND COLOR LEGENDS

KEYED NOTES

- 1 PRE-FINISHED METAL ROOF - RP1
- 2 PRE-FINISHED METAL TRIM FASCIA - MT1
- 3 PRE-FINISHED METAL SIDING - WS1
- 4 MANUFACTURED STONE
- 5 MANUFACTURED STONE CAP
- 6 COLUMN, SEE STRUCTURAL - EPT1
- 7 HOLLOW METAL DOOR AND FRAME - EPT1 & EPT2
- 8 ALUMINUM WINDOWS, HIGH, SEE ELEVATIONS
- 9 LOUVER, SEE MECHANICAL DRAWINGS
- 10 ADA COMPLIANT DRINKING FOUNTAIN, SEE PLUMBING
- 11 RECESSED SIGNAGE BOARD, SEE ALLOWANCE NO. 1; SECTION 012100 - ALLOWANCES
- 12 WALL CONTROL JOINT, CMU AND MANUFACTURED STONE MASONRY
- 13 WALL HYDRANT, SEE PLUMBING
- 14 LIGHT FIXTURE, SEE ELECTRICAL




Job Number	060451	JRR	Apr
Submitted by	John T. Watkins, III, PE, SE Director, Federal Services	Date	10/1/15
Plotted by	J. Ramsey	Issued For Construction	Description
Plat Date	10/1/15	IFC	Symbol
Plot Scale	1:1		
Design Code			
Designed by	J. Ramsey		
Drawn by	J. Ramsey		
Checked by	G. Archer		
File Name	AH15VR-A-232.DWG		


Arkansas Highway and Transportation Department	Arkansas Tourist Information Center	Trucker/Vending Building
(White River) (S)	Job 061451	Building Elevations

Arkansas Highway and Transportation Department
Arkansas Tourist Information Center
(White River) (S)
Job 061451
Trucker/Vending Building
Building Elevations


Sheet Reference Number:
A-232
Sheet 48 of 130

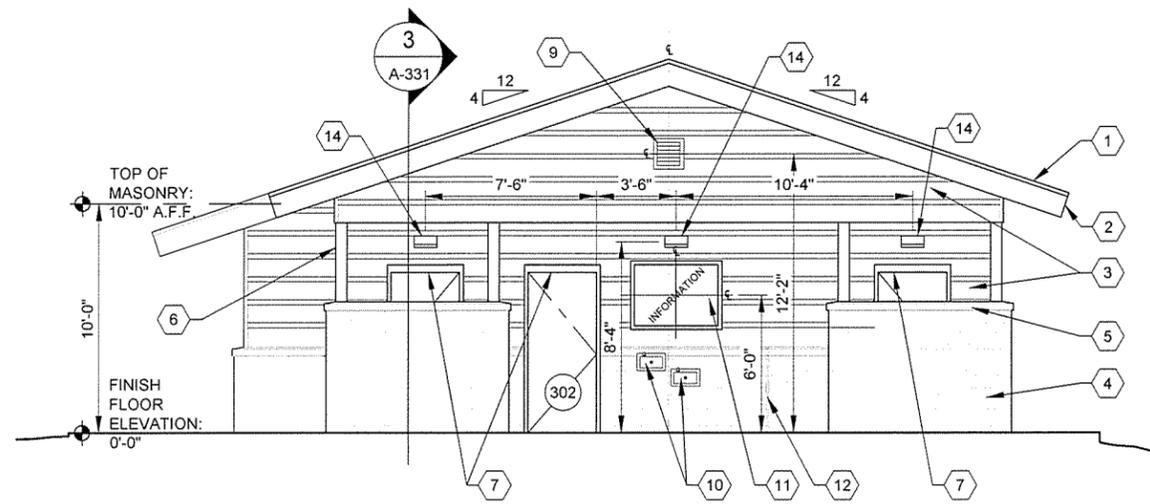


1 END ELEVATION
A-232 SCALE: 1/4" = 1'-0"

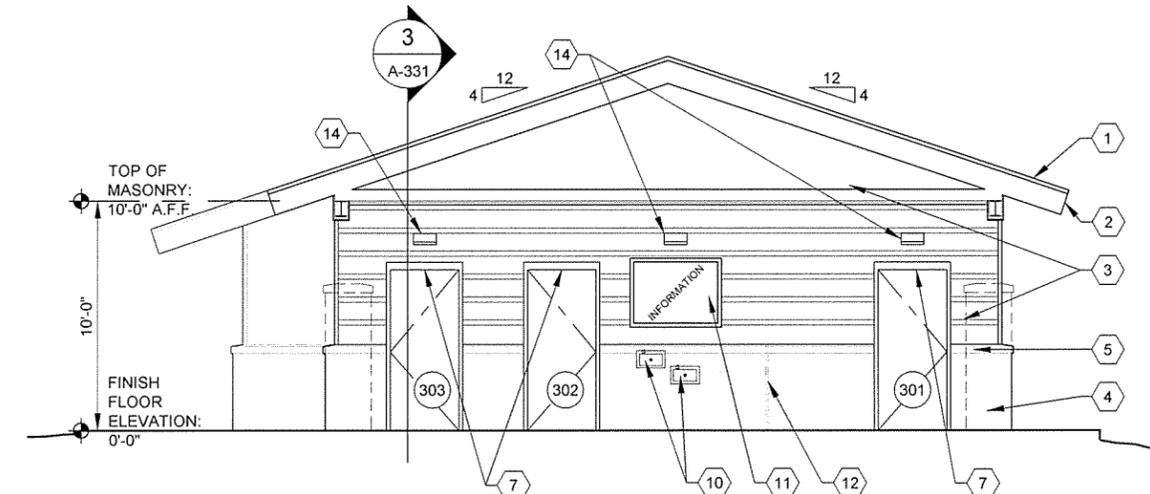


2 SECTION/END ELEVATION
A-232 SCALE: 1/4" = 1'-0"

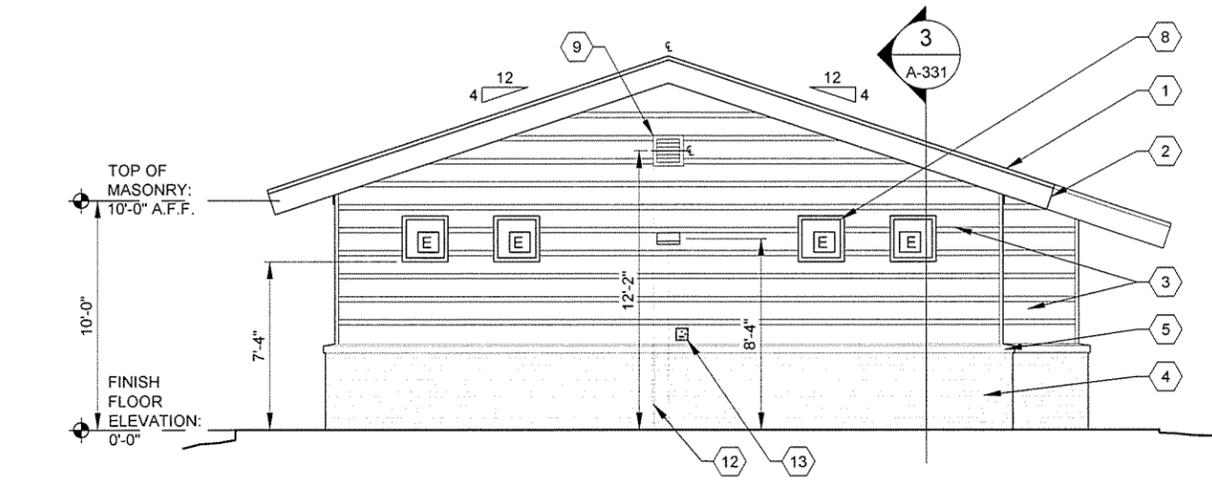


3 END ELEVATION
A-232 SCALE: 1/4" = 1'-0"

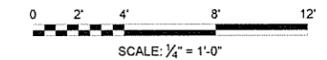


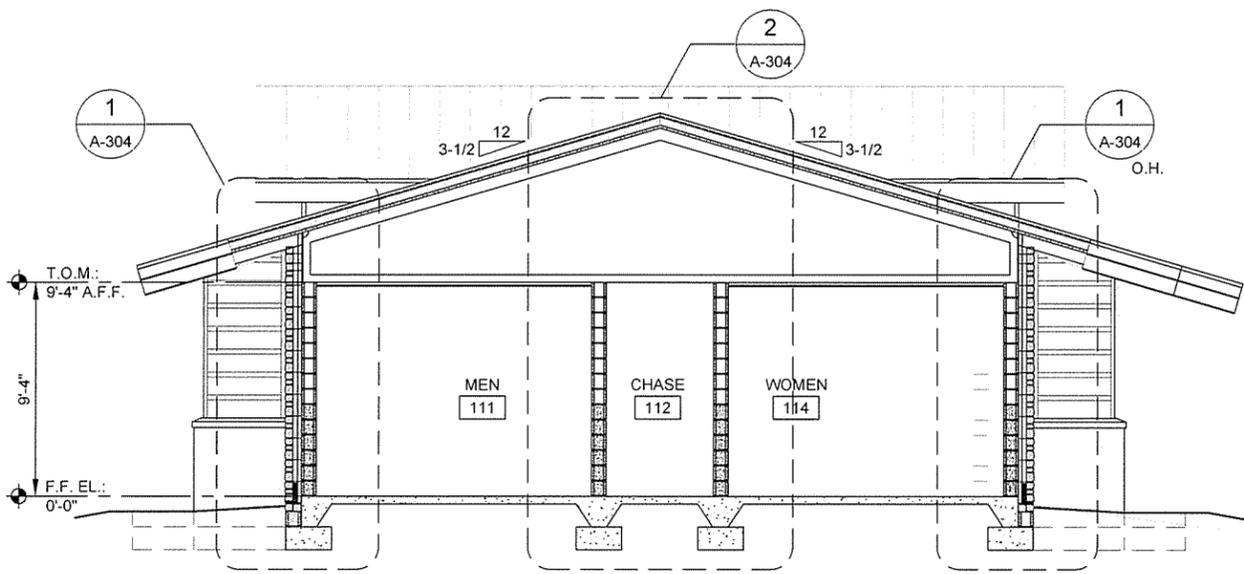


1 BUILDING SECTION
 A-301 SCALE: 1/4" = 1'-0"

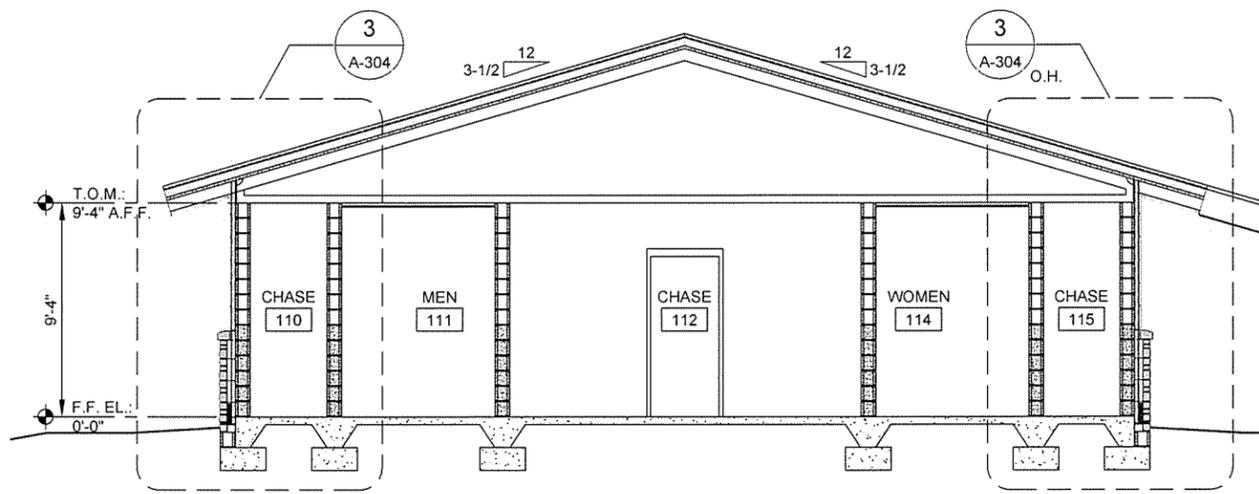

3 BUILDING SECTION
 A-301 SCALE: 1/4" = 1'-0"

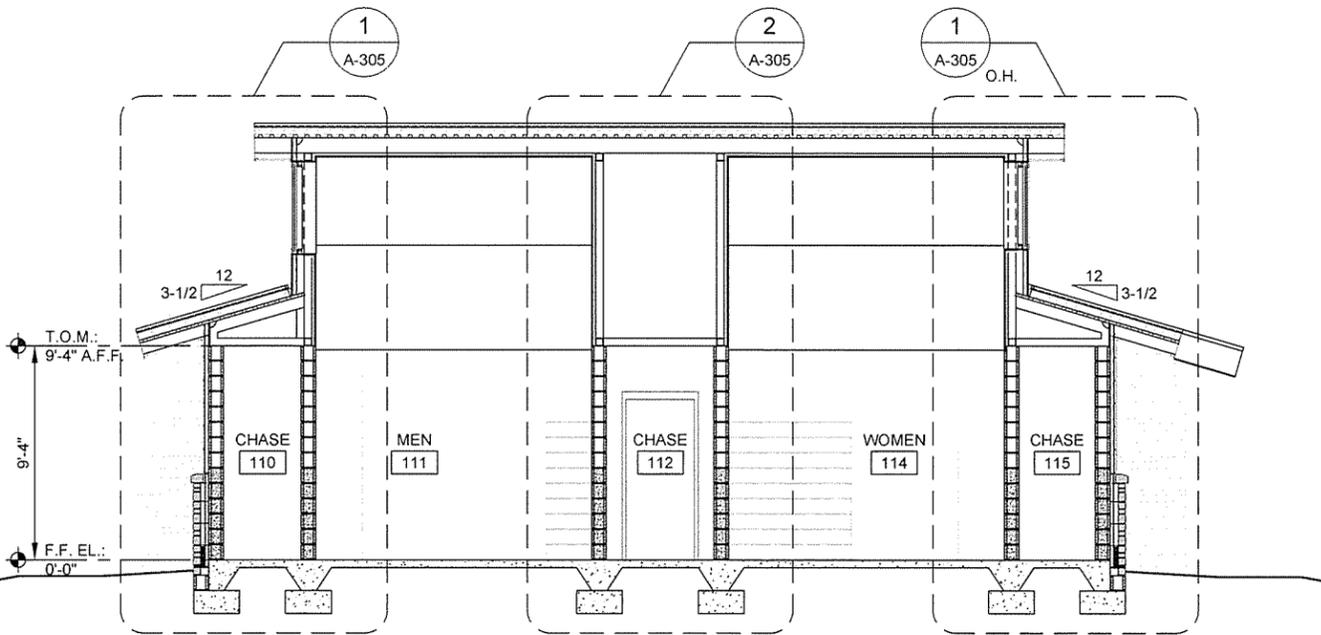


2 BUILDING SECTION
 A-301 SCALE: 1/4" = 1'-0"

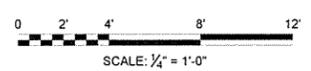


IFC Symbol	Description	Date	JRR Appr.
	ISSUED FOR CONSTRUCTION	10/1/15	

Designed by J. RAMSEY	Submitted by John T. Williams, III, P.E., SE Director, Federal Services	Job Number 060451
Drawn by J. RAMSEY	Plot Date 10/1/15	Plot Scale 1:1
Checked by G. ARCHER	Draw Code	N/A
File Name A15VMR-A-301.DWG		N/A


ARKANSAS HIGHWAY AND TRANSPORTATION DEPARTMENT
 ARKANSAS TOURIST INFORMATION CENTER
 (WHITE RIVER) (S)
 JOB 061451
 TOURIST INFORMATION CENTER
 BUILDING SECTIONS

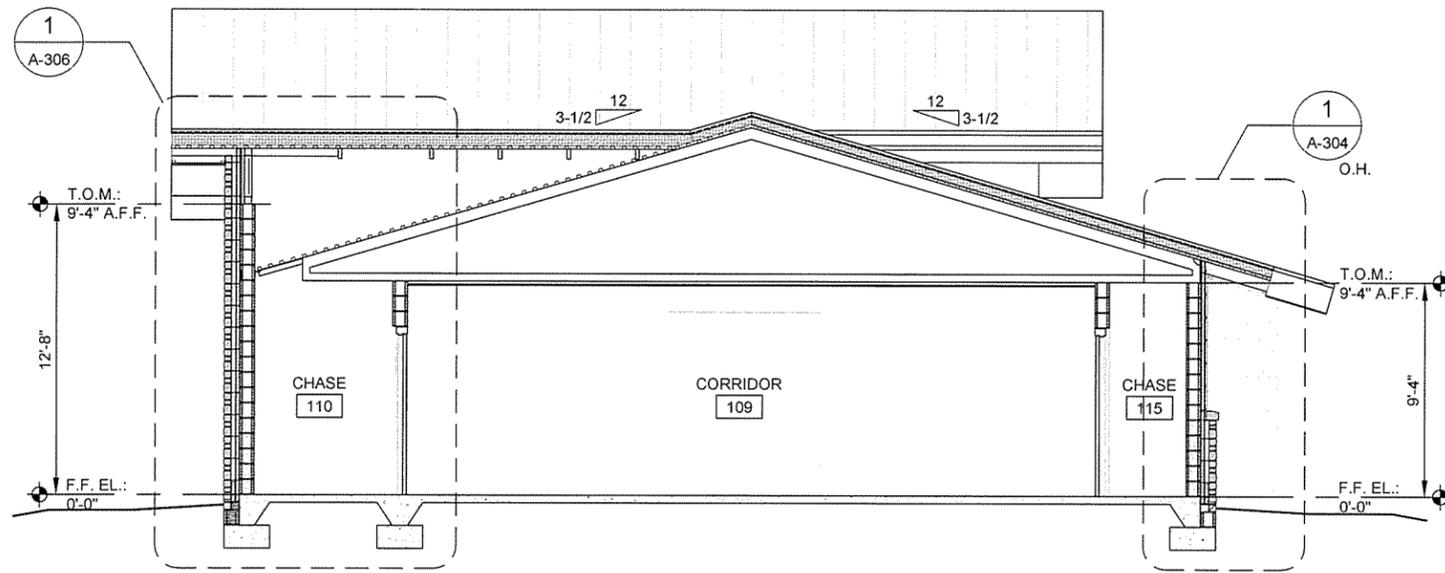

1 BUILDING SECTION
A-302 SCALE: 1/4" = 1'-0"

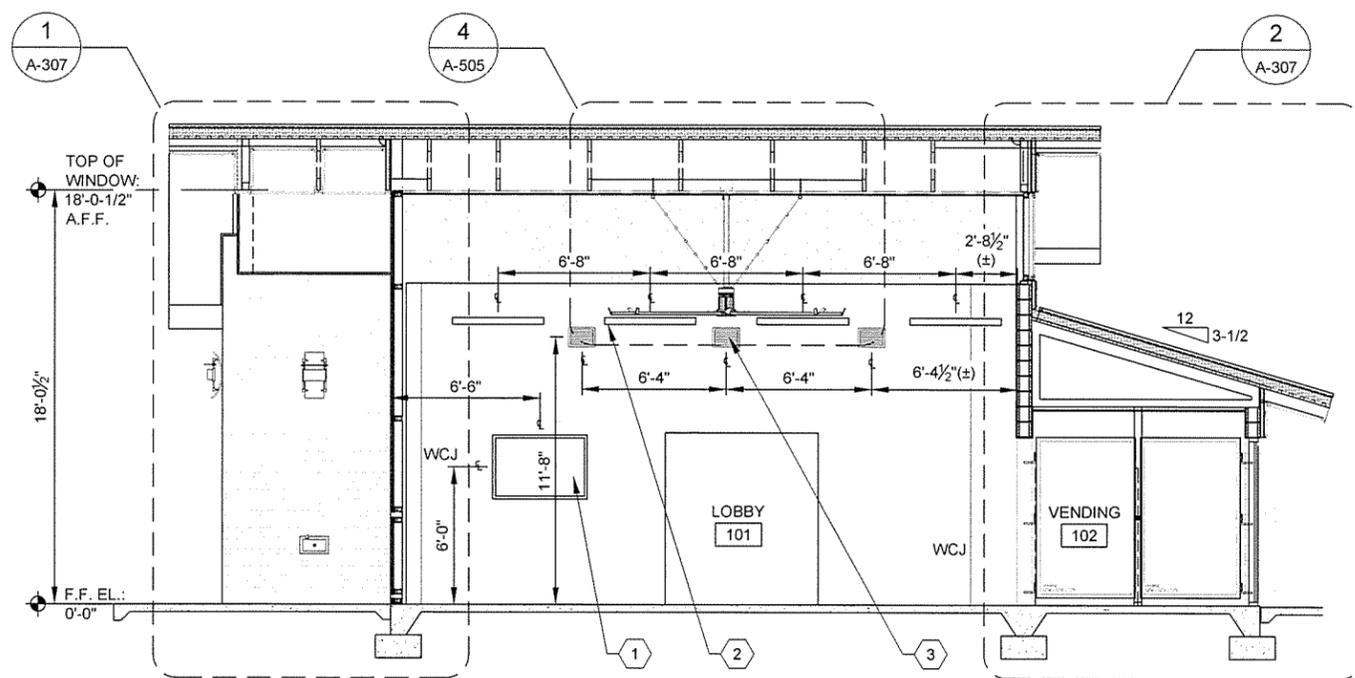

2 BUILDING SECTION
A-302 SCALE: 1/4" = 1'-0"

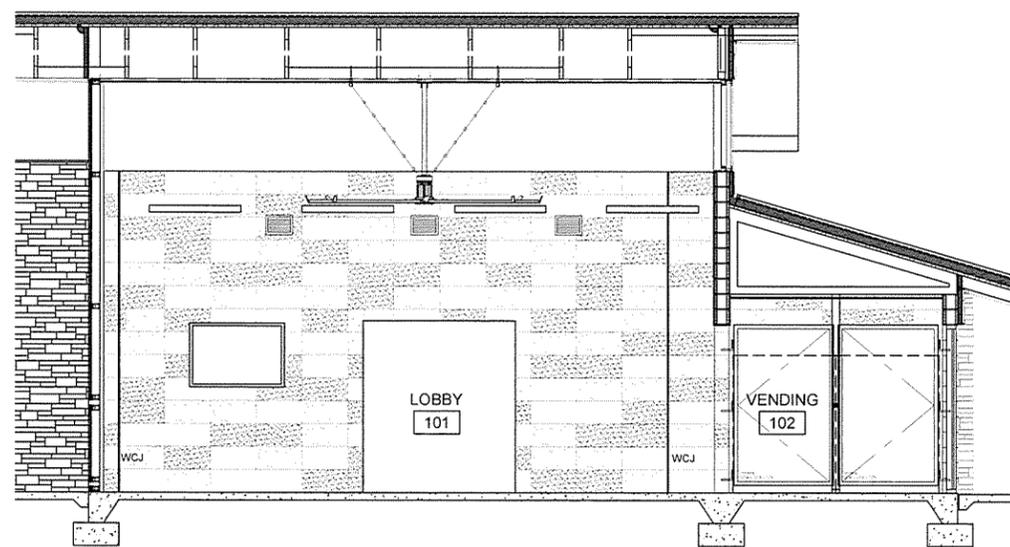

3 LOBBY WALL TILE DIAGRAM
A-302 SCALE: 1/4" = 1'-0"

KEYED NOTES

- 1 WALL-MOUNTED MONITOR SECURITY CABINET. SEE ALLOWANCE NO. 2, SECTION 012100 - ALLOWANCES. CONFIRM FINAL MOUNTING HEIGHT WITH OWNER/ARCHITECT.
- 2 LIGHT FIXTURE. SEE ELECTRICAL
- 3 HVAC SUPPLY GRILLE. SEE MECHANICAL

LEGEND

- CERAMIC WALL TILE, T1, 40% OF BLEND
- CERAMIC WALL TILE, T2, 30% OF BLEND
- CERAMIC WALL TILE, T3, 30% OF BLEND




IFC Symbol	Description	Date	Appr.
	ISSUED FOR CONSTRUCTION	10/1/15	JRR

Job Number	Submitted by	Director, Federal Services	Plot Scale	Plot Date	Drawn by	Checked by	File Name
069461	John T. Walkins, III, PE, SE	J. RAMSEY	1:1	10/1/15	J. RAMSEY	G. ARCHER	ARTSWR-A-302.DWG


ARKANSAS HIGHWAY AND TRANSPORTATION DEPARTMENT
 ARKANSAS TOURIST INFORMATION CENTER
 (WHITE RIVER) (S)
 JOB 061451
 TOURIST INFORMATION CENTER
 BUILDING SECTIONS

Sheet Reference Number:
A-302
 Sheet 50 of 130

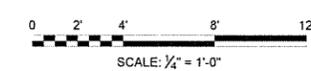


KEYED NOTES


- 1 CEILING FAN- PROVIDE 3 ADDITIONAL SAFETY ANCHORS PER MANUFACTURER'S RECOMMENDATION
- 2 ARKANSAS "DIAMOND" SIGN, SEE ALLOWANCE NO. 1; SECTION 012100 - ALLOWANCES

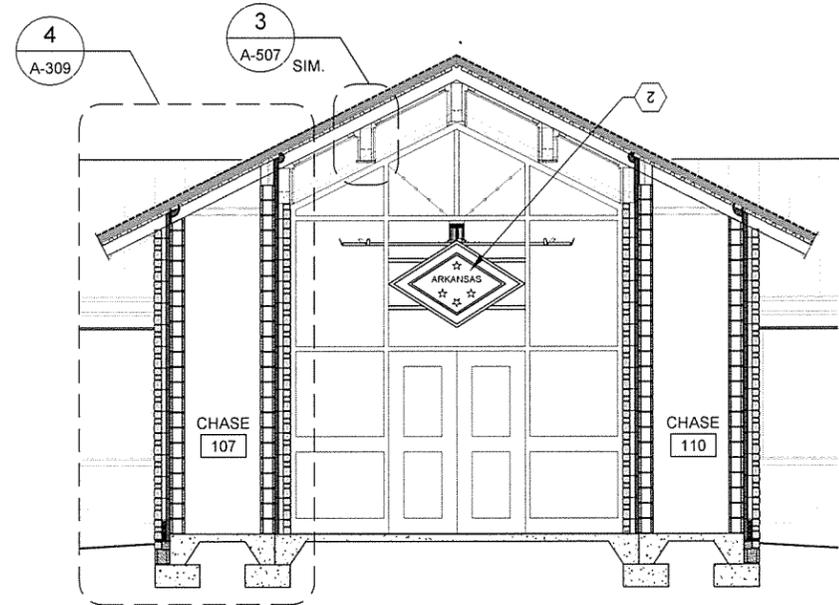

1 BUILDING SECTION
SCALE: 1/4" = 1'-0"

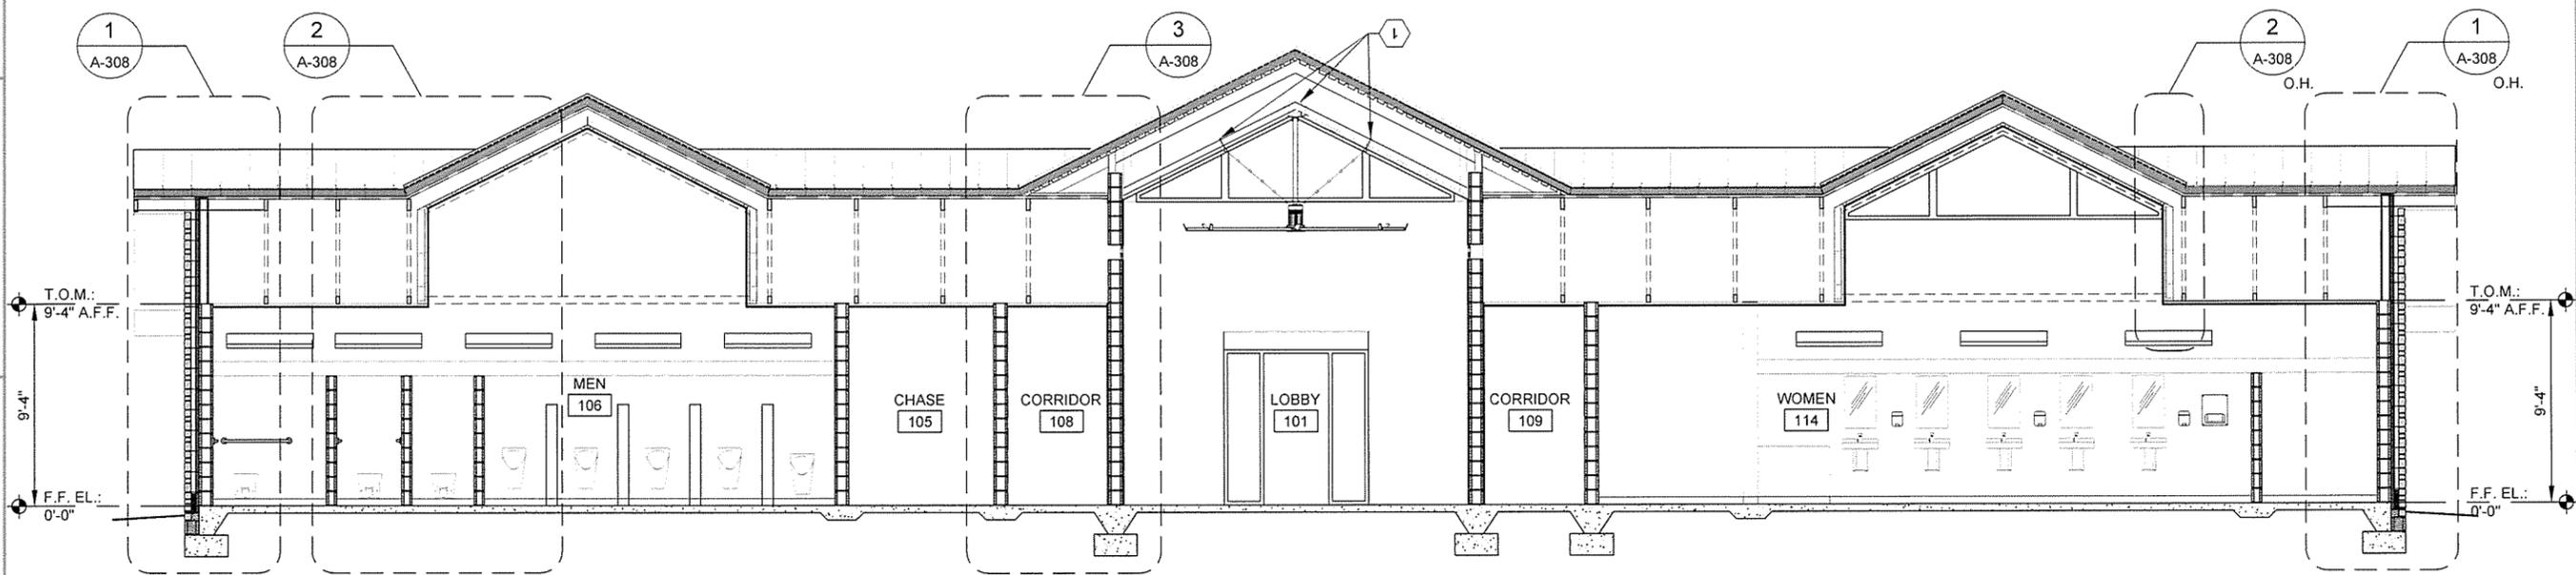

2 BUILDING SECTION
SCALE: 1/4" = 1'-0"

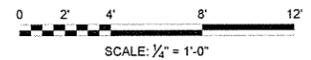

Job Number	060451	JRR
Submitted by	John T. Watkins, III, PE, SE Director, Federal Services	Appr.
Drawn by	J. RAMSEY	Date
Checked by	G. ARCHER	10/1/15
Plot Date	10/1/15	ISSUED FOR CONSTRUCTION
Plot Scale	1:1	Description
Drwg Code:		IFC
File Name	AHSWR-A-303.DWG	Symbol


Designed by	J. RAMSEY
Submitted by	John T. Watkins, III, PE, SE Director, Federal Services
Drawn by	J. RAMSEY
Checked by	G. ARCHER
Plot Date	10/1/15
Plot Scale	1:1
Drwg Code:	
File Name	AHSWR-A-303.DWG

ARKANSAS HIGHWAY AND TRANSPORTATION DEPARTMENT
ARKANSAS TOURIST INFORMATION CENTER
(WHITE RIVER) (S)
JOB 061451
TOURIST INFORMATION CENTER
BUILDING SECTIONS


Sheet Reference Number:
A-303
Sheet 51 of 130




4701 Northshore Drive
N Little Rock, AR 72118
501-376-3633
www.GarverUSA.com

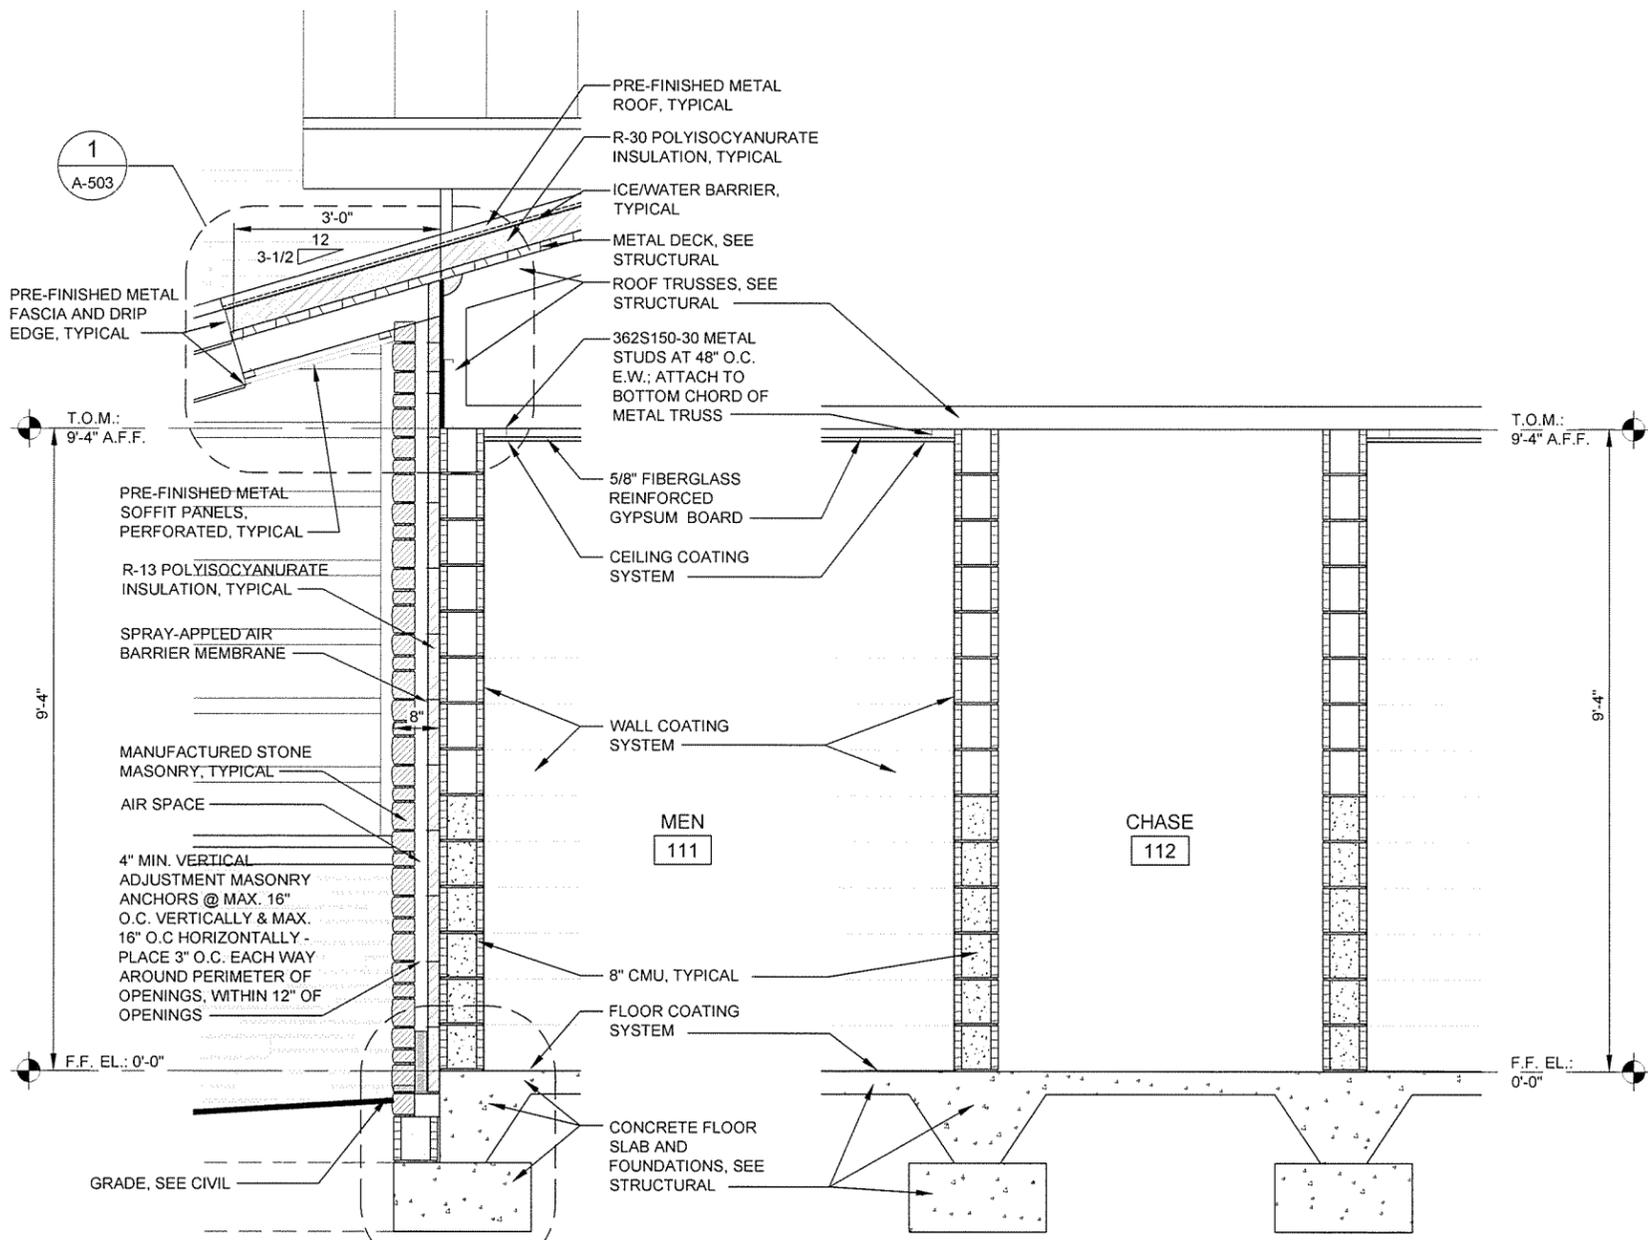


1 BUILDING SECTION
SCALE: 1/4" = 1'-0"

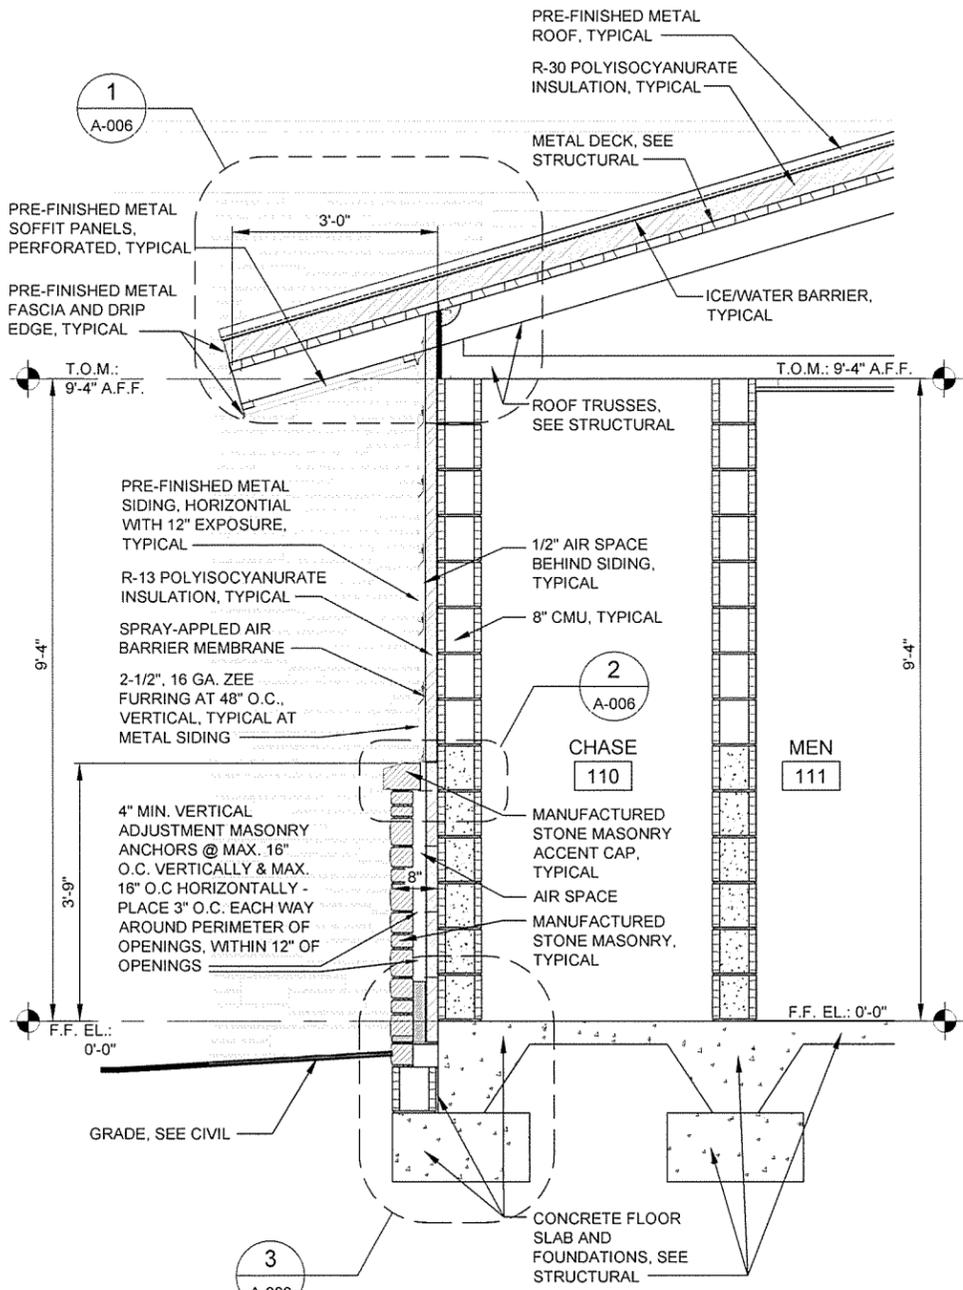

2 WALL SECTION
SCALE: 3/4" = 1'-0"

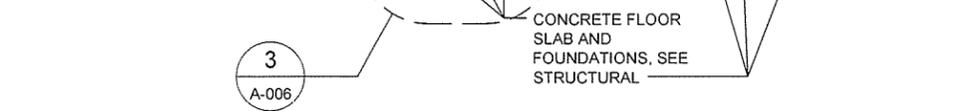

3 WALL SECTION
SCALE: 3/4" = 1'-0"

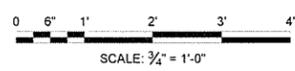


Job Number	060451	Job Title	N/A	Job Date	10/1/15	Job Code	N/A
Submitted by	John T. Walters, III, PE, SE Director, Federal Services	Plot Scale	11	Drawn by	J. RAMSEY	Checked by	G. ARCHER
Job Number	060451	Job Title	N/A	Job Date	10/1/15	Job Code	N/A
Submitted by	John T. Walters, III, PE, SE Director, Federal Services	Plot Scale	11	Drawn by	J. RAMSEY	Checked by	G. ARCHER
Job Number	060451	Job Title	N/A	Job Date	10/1/15	Job Code	N/A
Submitted by	John T. Walters, III, PE, SE Director, Federal Services	Plot Scale	11	Drawn by	J. RAMSEY	Checked by	G. ARCHER


Job Number	060451	Job Title	N/A	Job Date	10/1/15	Job Code	N/A
Submitted by	John T. Walters, III, PE, SE Director, Federal Services	Plot Scale	11	Drawn by	J. RAMSEY	Checked by	G. ARCHER
Job Number	060451	Job Title	N/A	Job Date	10/1/15	Job Code	N/A
Submitted by	John T. Walters, III, PE, SE Director, Federal Services	Plot Scale	11	Drawn by	J. RAMSEY	Checked by	G. ARCHER
Job Number	060451	Job Title	N/A	Job Date	10/1/15	Job Code	N/A
Submitted by	John T. Walters, III, PE, SE Director, Federal Services	Plot Scale	11	Drawn by	J. RAMSEY	Checked by	G. ARCHER

ARKANSAS HIGHWAY AND TRANSPORTATION DEPARTMENT
ARKANSAS TOURIST INFORMATION CENTER
(WHITE RIVER) (S)
JOB 061451


TOURIST INFORMATION CENTER
WALL SECTIONS

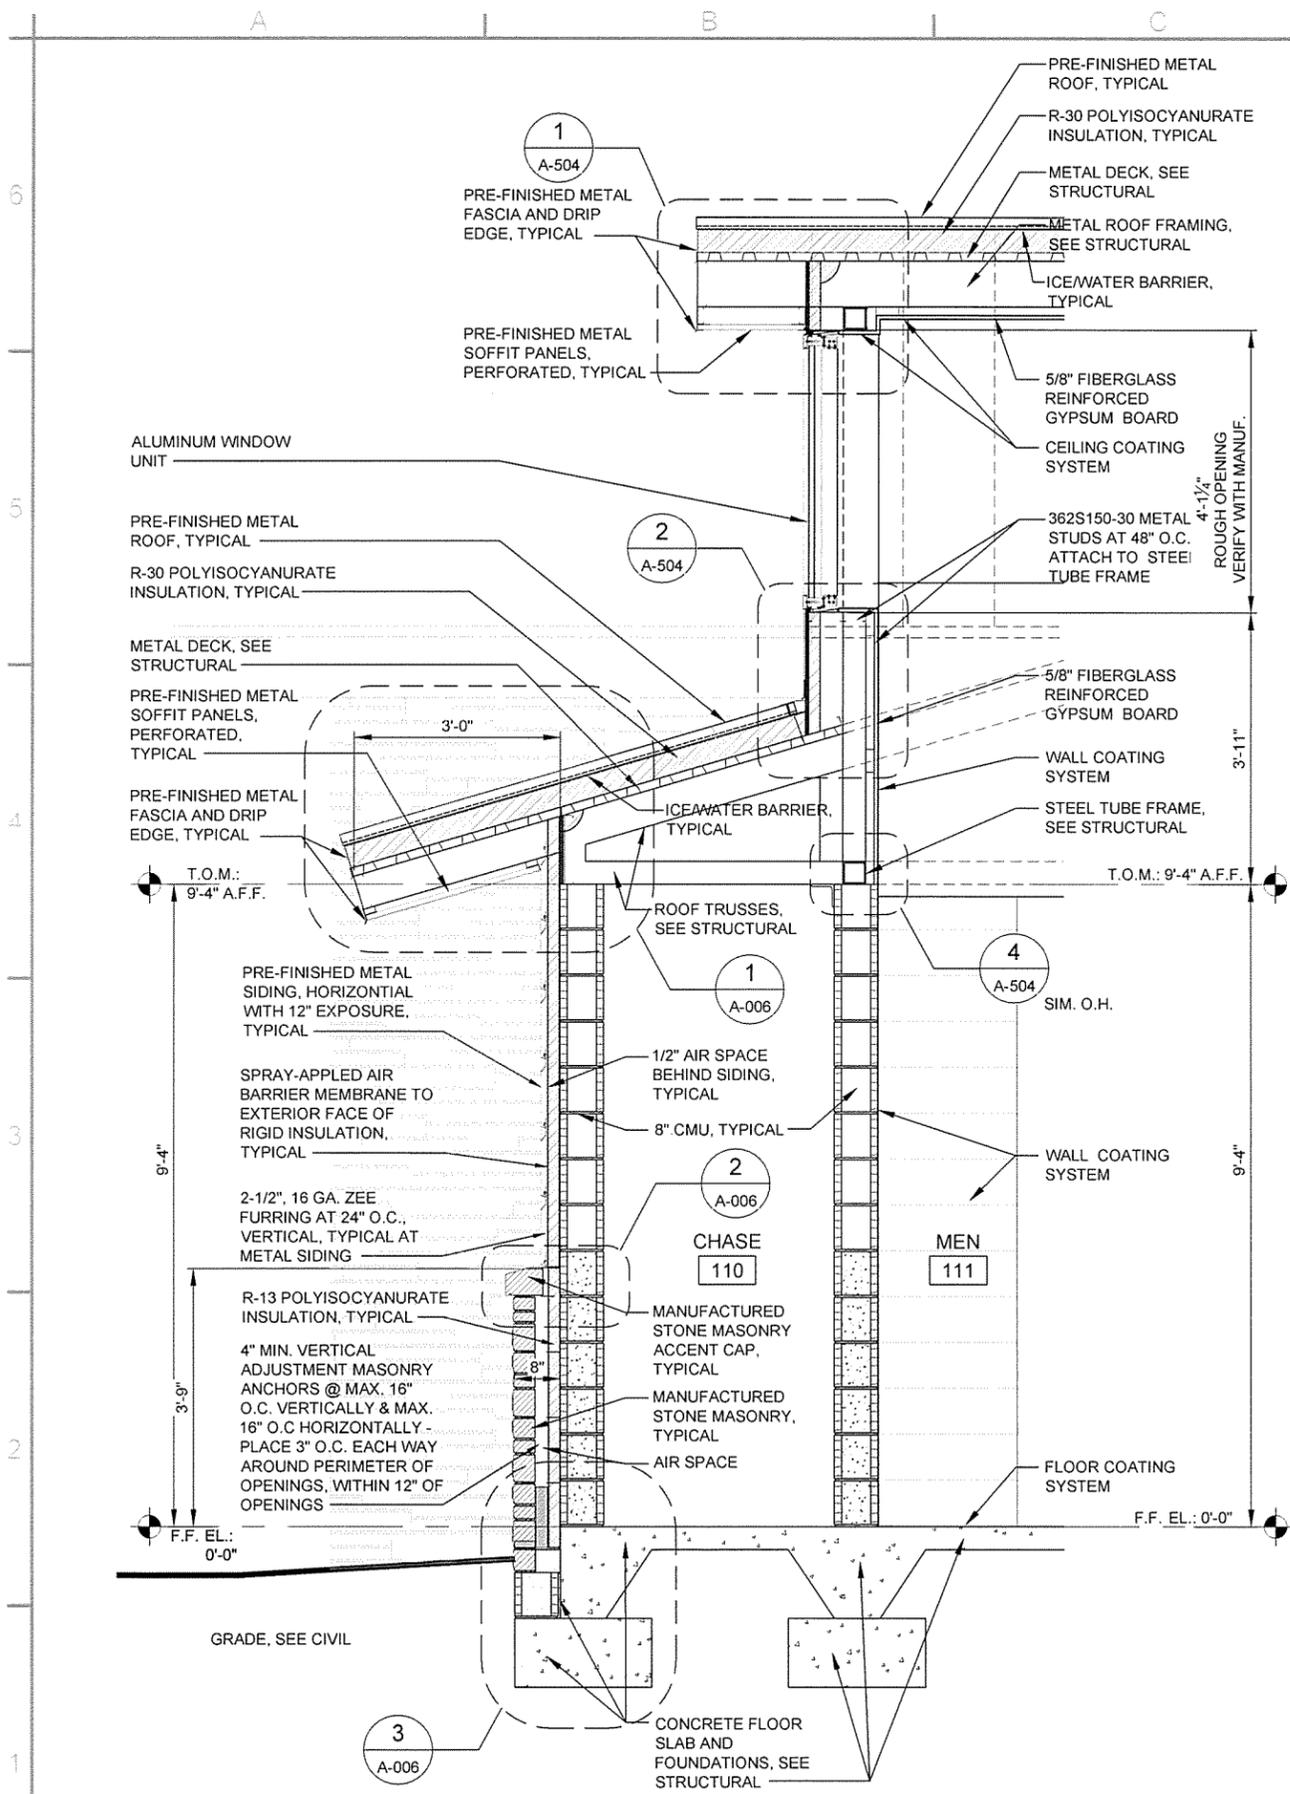

1 WALL SECTION
A-305 SCALE: 3/4" = 1'-0"

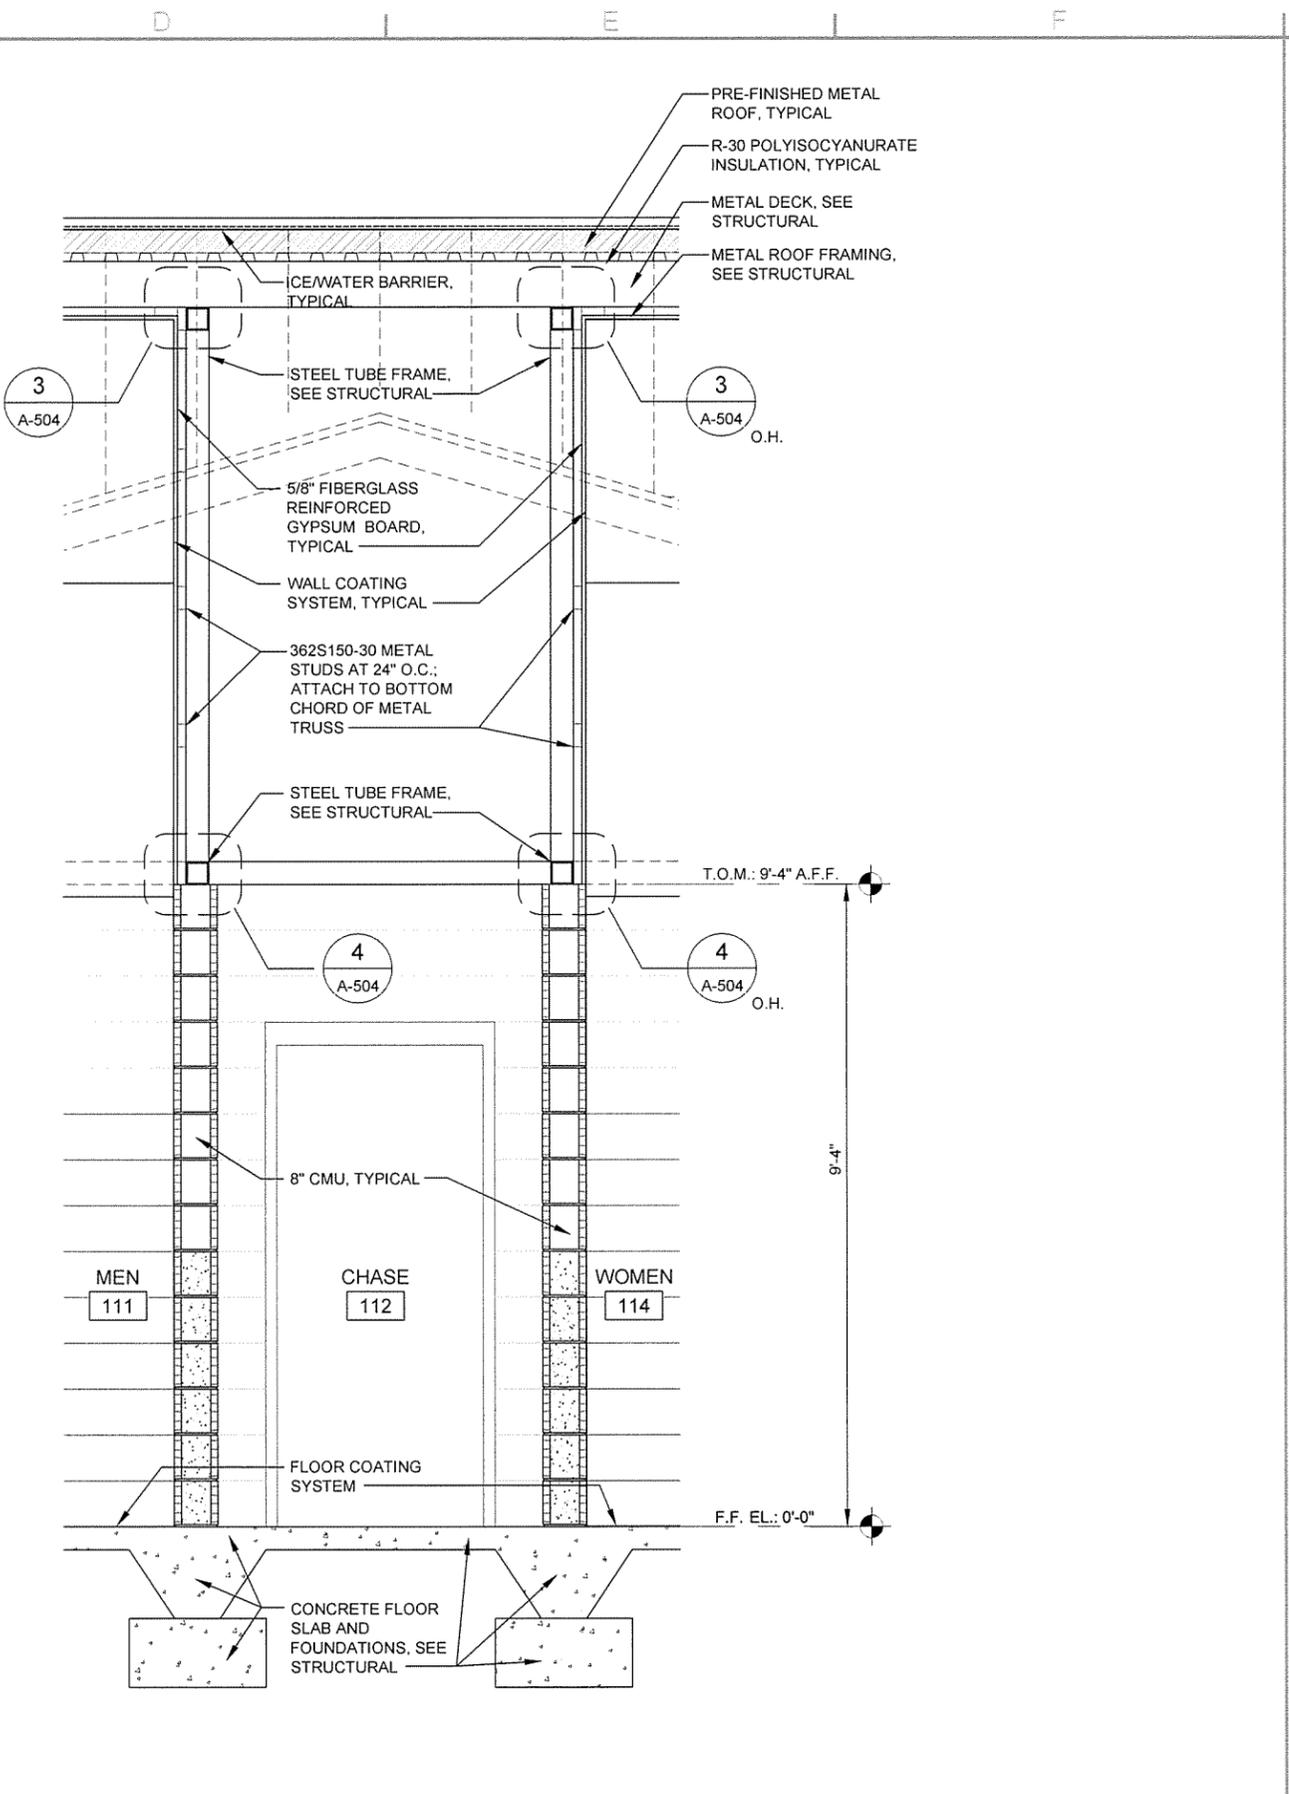

2 WALL SECTION
A-305 SCALE: 3/4" = 1'-0"

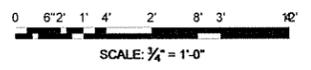



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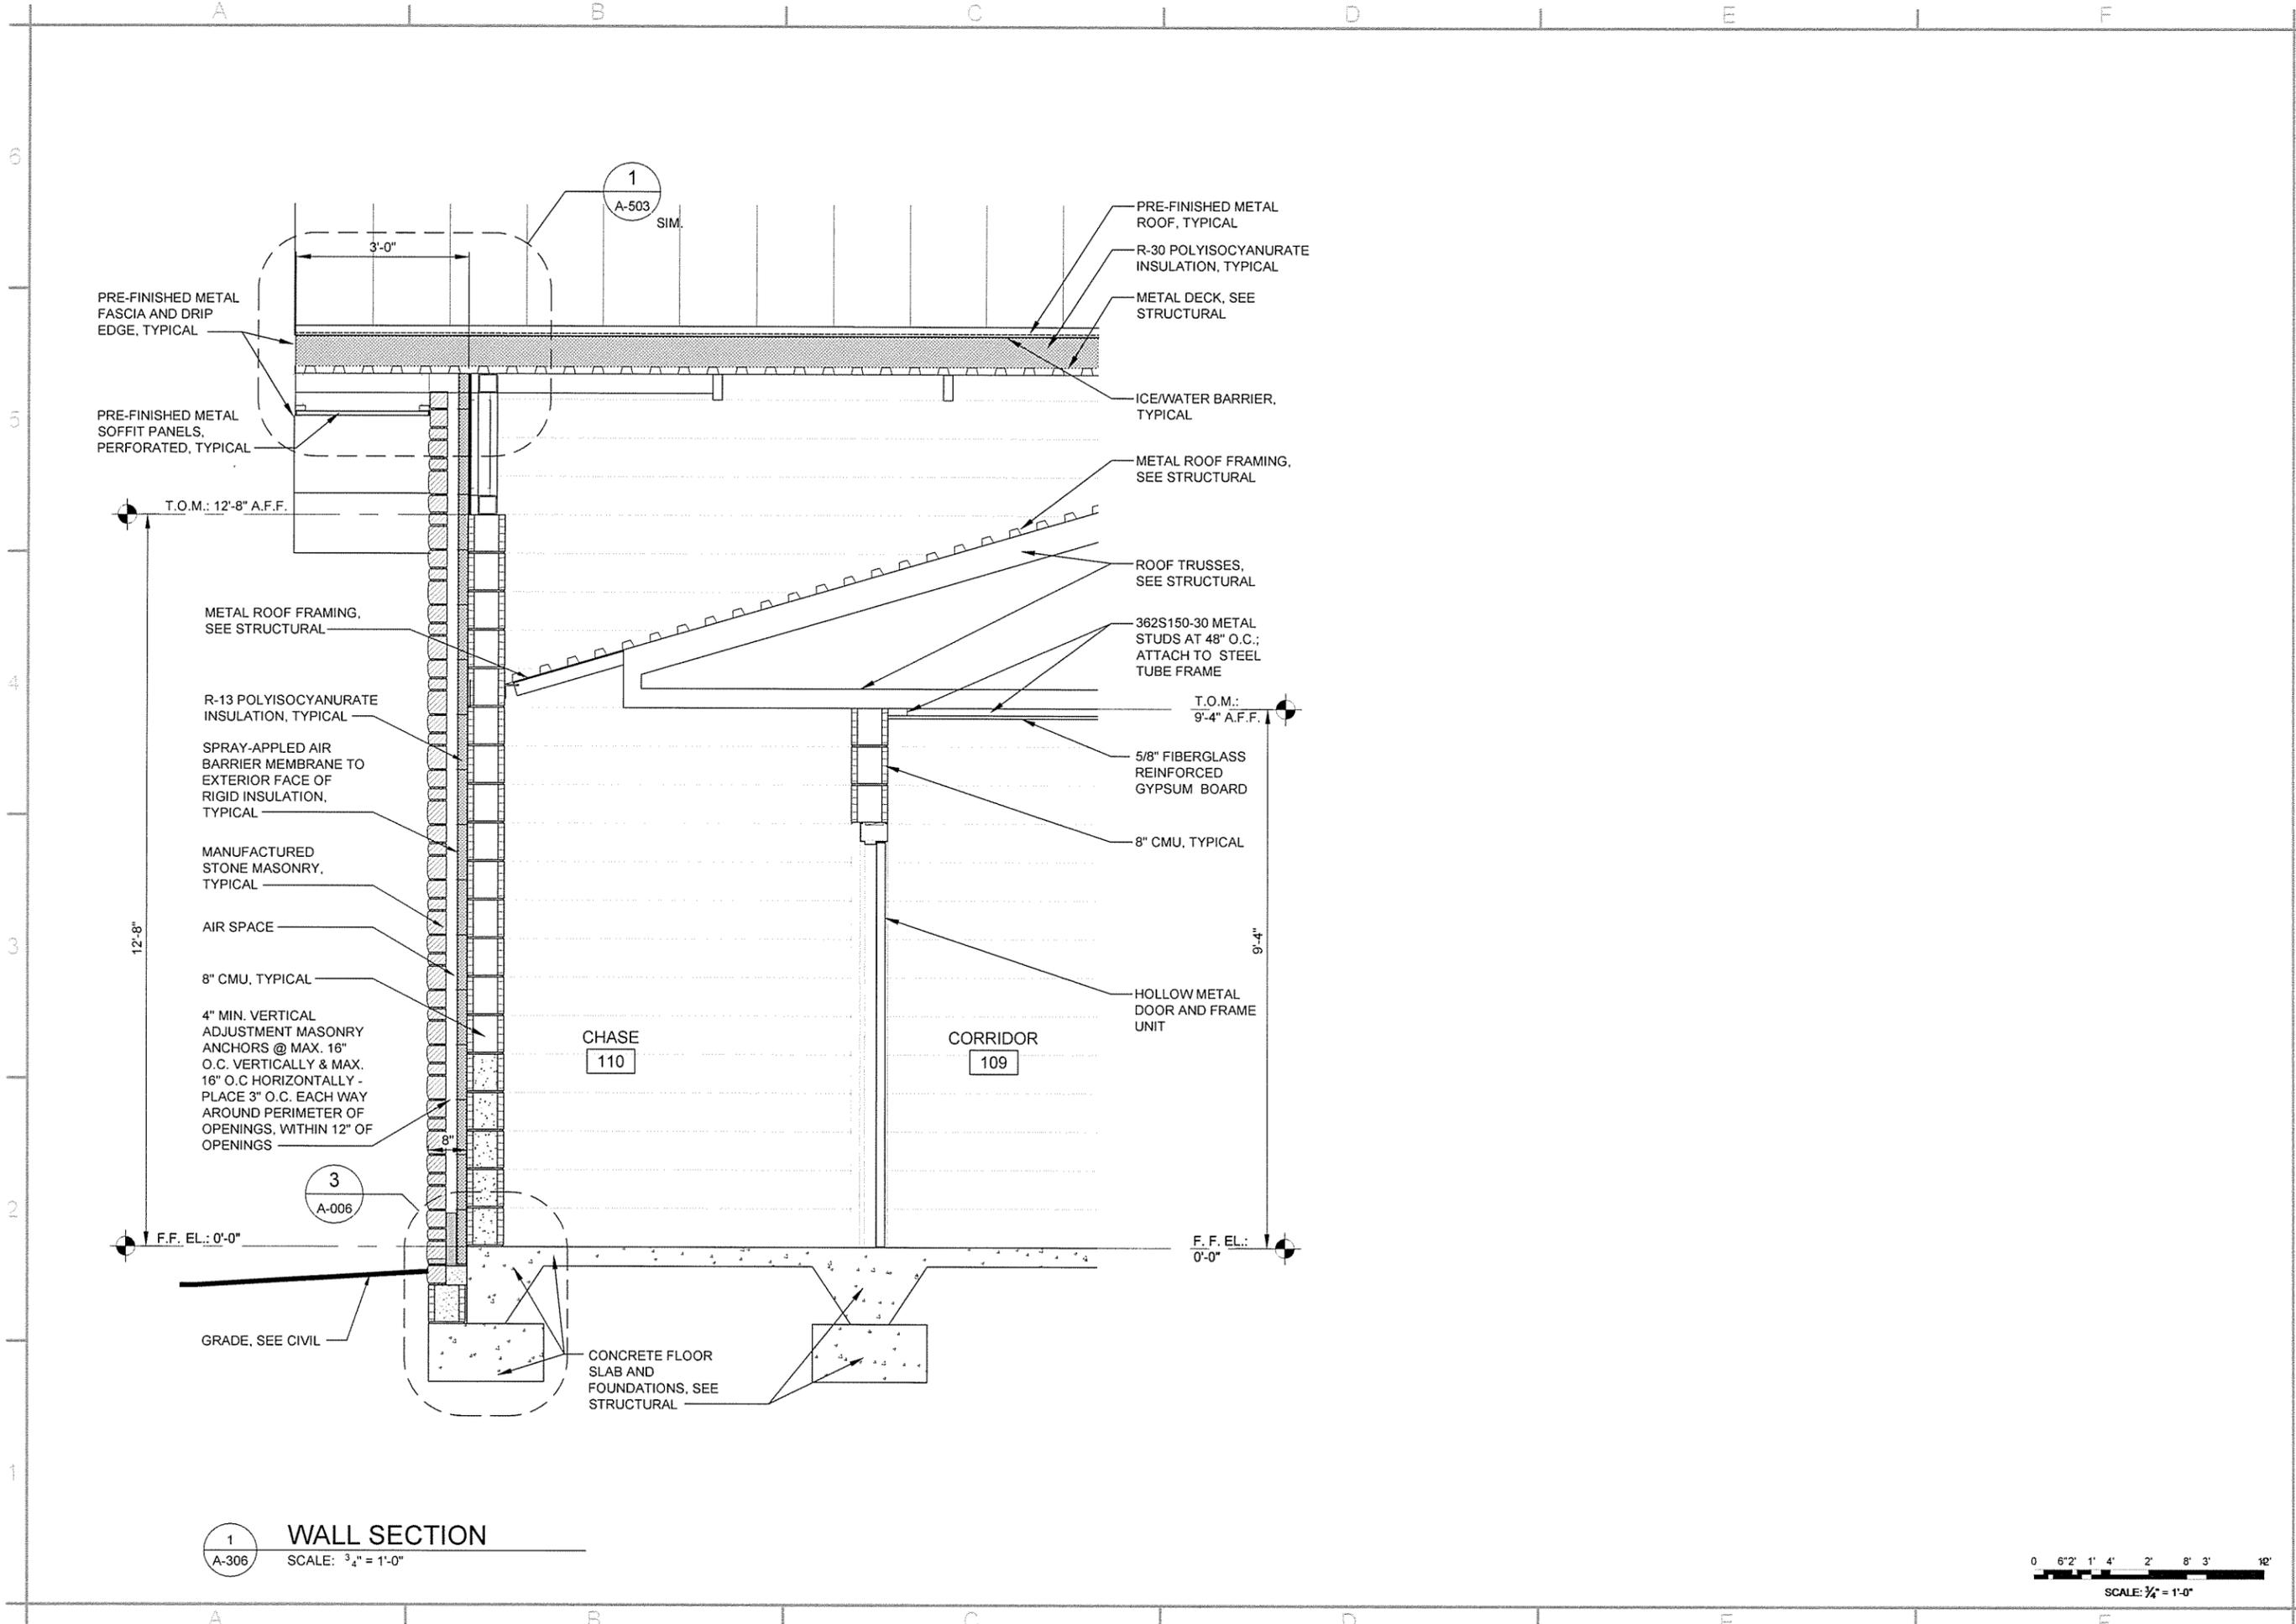
JRR Apr Date	ISSUED FOR CONSTRUCTION Description
10/1/15 Date	IPC Symbol
Job Number 000-51	N/A N/A N/A
Submitted by John T. Watkins, III, P.E., SE Director, Federal Services	Plot Scale 11
Designed by J. RAMSEY	Drawn by J. RAMSEY
Date 10/1/15	Dwg. Code Checked by G. ARCHIBALD
File Name AHTSWR-A-305.DWG	

ARKANSAS HIGHWAY AND TRANSPORTATION DEPARTMENT
ARKANSAS TOURIST INFORMATION CENTER
(WHITE RIVER) (S)
JOB 081451


TOURIST INFORMATION CENTER
WALL SECTIONS

Sheet Reference Number:
A-305

Sheet 53 of 130



1 WALL SECTION
 A-306 SCALE: 3/4" = 1'-0"

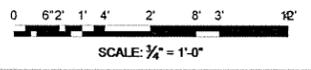

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REGISTERED ARCHITECT
 Garver, LLC
 License No. LL1111
 STATE OF ARKANSAS


REGISTERED ARCHITECT
 Greg A. Archer
 License No. 2677
 STATE OF ARKANSAS

JRR	Appr.
10/1/15	Date
ISSUED FOR CONSTRUCTION	Description
IFC	Symbol

Job Number 060451	N/A	N/A	N/A
Submitted by John T. Williams, III, P.E., SE Director, Federal Services	Plot Scale 1:1	Plot Date 10/1/15	Drawn by J. RAMSEY
Designed by J. RAMSEY	Checked by G. ARCHER	File Name A1515W-A-306 DWG	


ARKANSAS HIGHWAY AND TRANSPORTATION DEPARTMENT
 ARKANSAS TOURIST INFORMATION CENTER
 (WHITE RIVER) (S)
 JOB 061451

TOURIST INFORMATION CENTER
 WALL SECTIONS

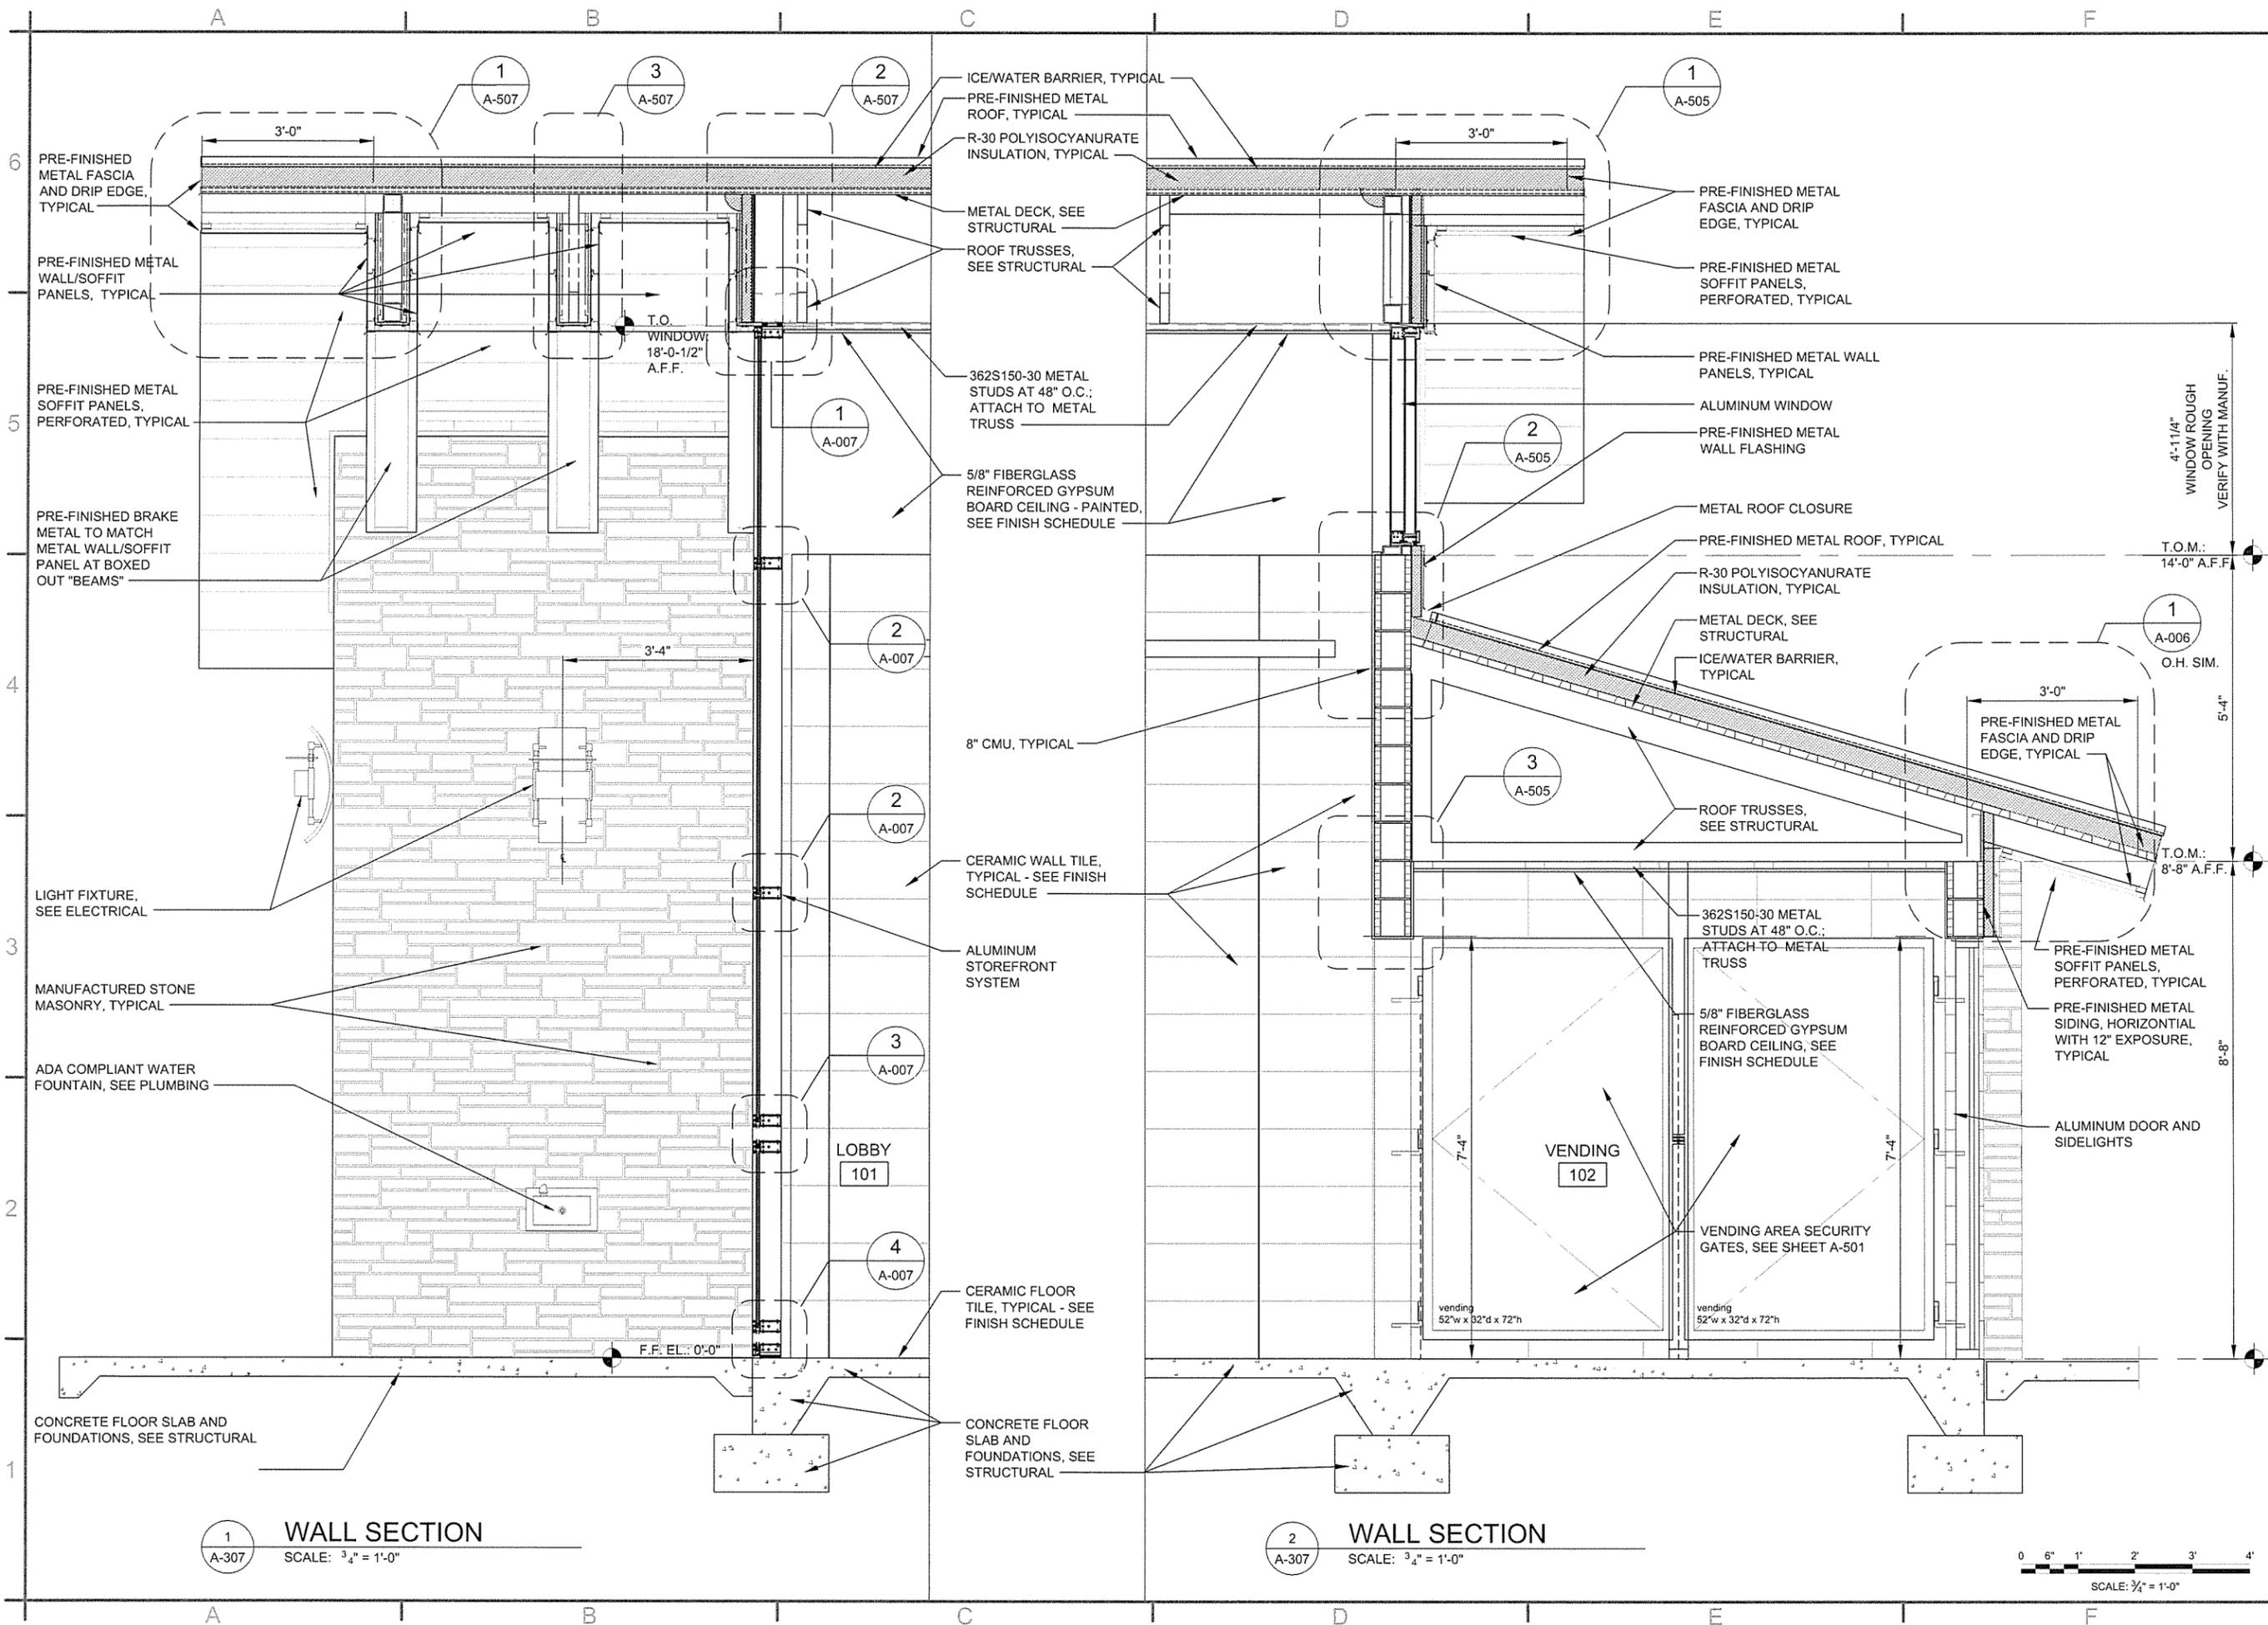

1 WALL SECTION
A-307 SCALE: 3/4" = 1'-0"

2 WALL SECTION
A-307 SCALE: 3/4" = 1'-0"

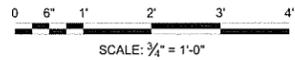

JRR	Appr.
10/11/15	Date

ISSUED FOR CONSTRUCTION	Description
IFC	Symbol

Job Number	060451	N/A	N/A	N/A
Submitted by	John T. Watkins, III PE, SE Director, Professional Services	Plot Scale	1:1	Draw Code:
Designed by	J. RAMSEY	Plot Date	10/27/15	Checked by
Drawn by	J. RAMSEY	File Name	ART15VIR-A-307.DWG	


ARKANSAS HIGHWAY AND TRANSPORTATION DEPARTMENT
 ARKANSAS TOURIST INFORMATION CENTER
 (WHITE RIVER) (S)
 JOB 061451
 TOURIST INFORMATION CENTER
 WALL SECTIONS

JRR	Apr.
Date	10/1/15
Description	ISSUED FOR CONSTRUCTION
Symbol	IPC

Job Number	060451	N/A	N/A	N/A
Submitted by	John T. Watkins, III, PE, SE Director, Federal Services	Plot Scale	1:1	Drwg Code
Designed by	J. RAMSEY	Drawn by	J. RAMSEY	Checked by
Plot Date	10/1/15	Drwg Code	G. ARCHER	File Name
				AHS15R-A-308.DWG

ARKANSAS HIGHWAY AND TRANSPORTATION DEPARTMENT
 ARKANSAS TOURIST INFORMATION CENTER
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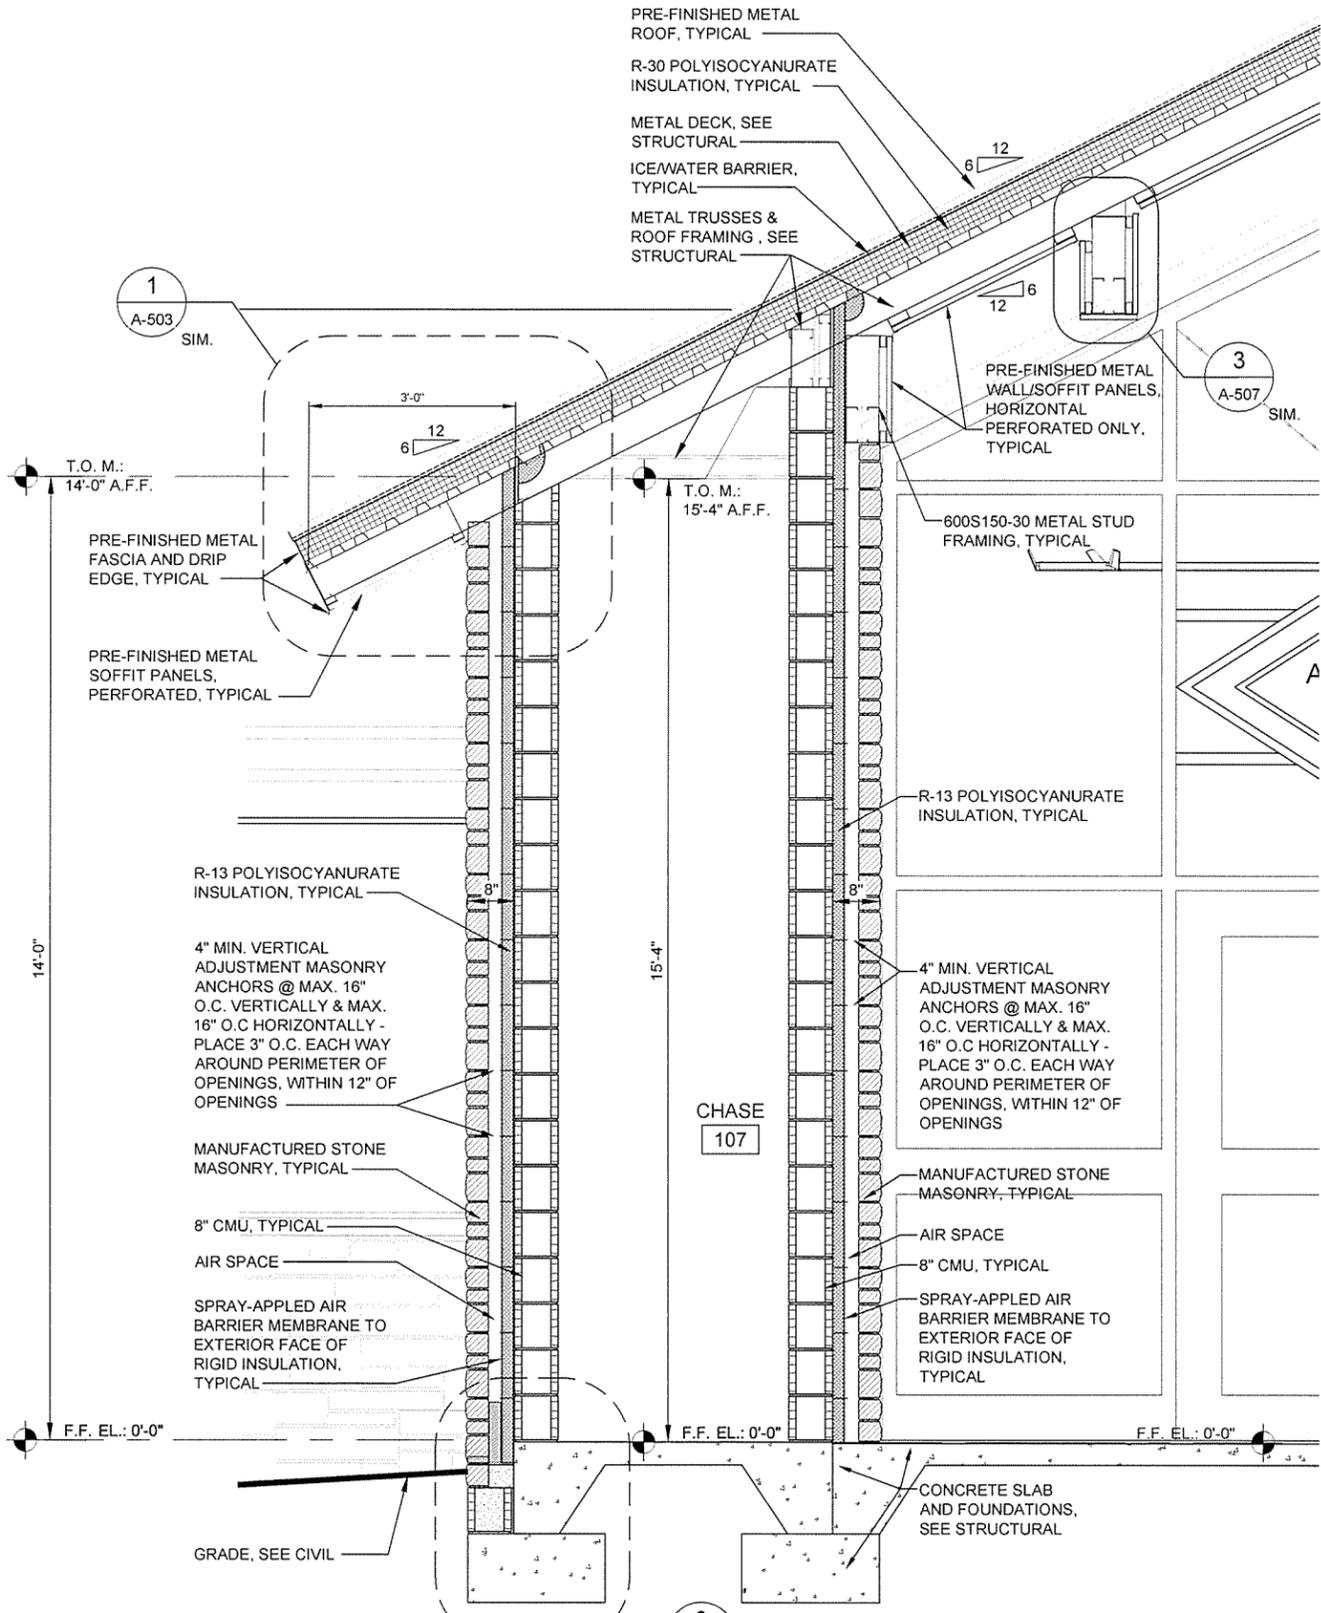
TOURIST INFORMATION CENTER
 WALL SECTIONS

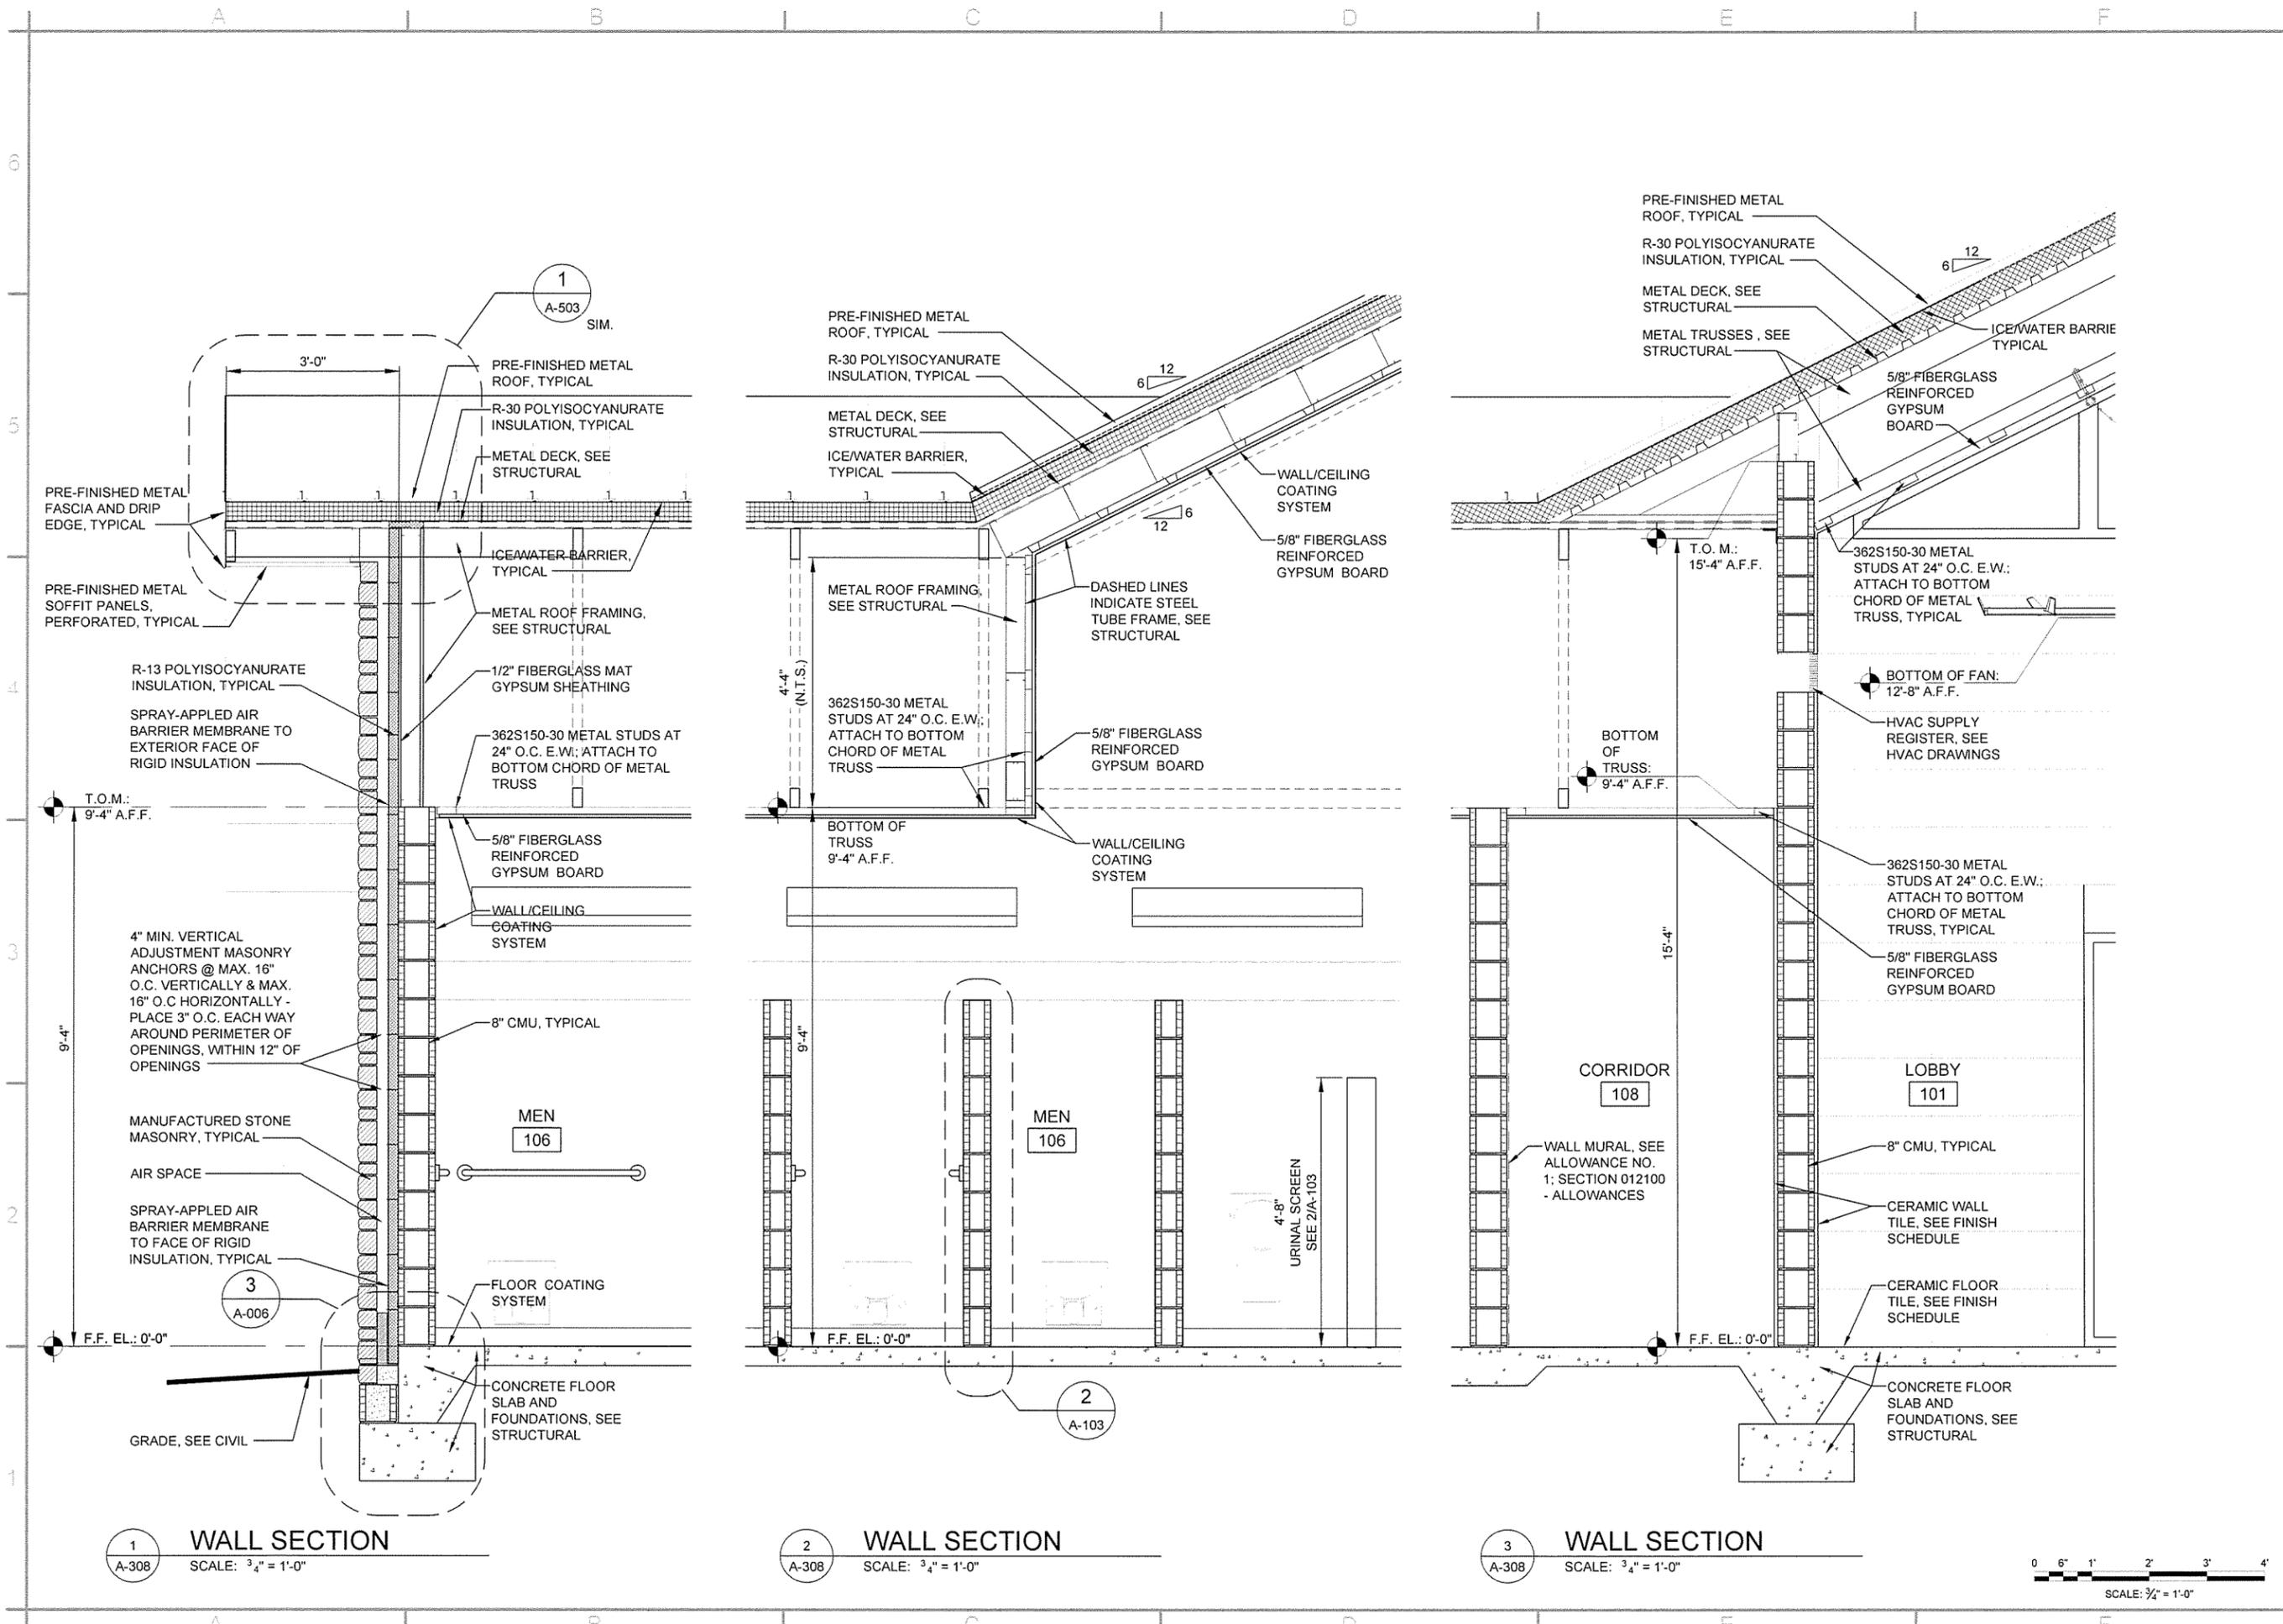



ISSUED FOR CONSTRUCTION	IFC Symbol
Date	Date
Appr.	Appr.
JRR	JRR


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Submitted by	John T. Walters, III, P.E., SE Director, Federal Services
Drawn by	J. RAMSEY
Checked by	G. ARCHER
Plot Date	10/1/15
Plot Scale	1:1
Dwg Code	
File Name	AR15VIR-A-309.DWG

ARKANSAS HIGHWAY AND TRANSPORTATION DEPARTMENT
 ARKANSAS TOURIST INFORMATION CENTER
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 JOB 061451
 TOURIST INFORMATION CENTER
 WALL SECTIONS




1
A-309
WALL SECTION
 SCALE: 3/4" = 1'-0"

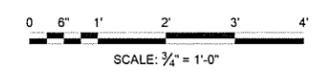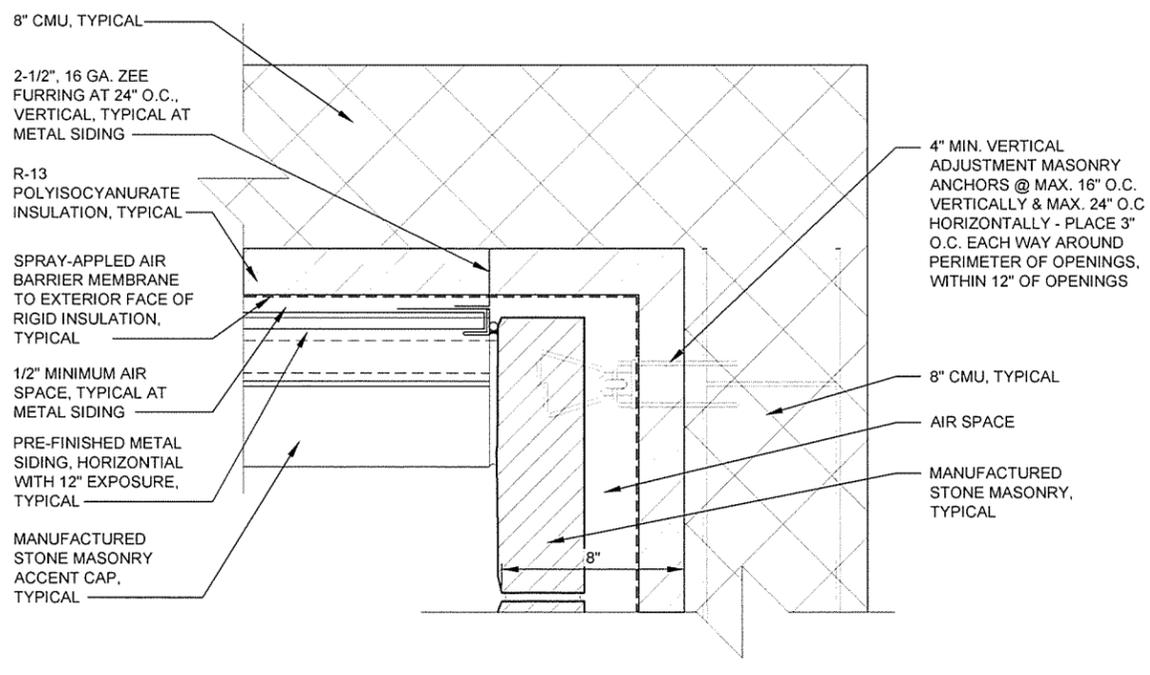

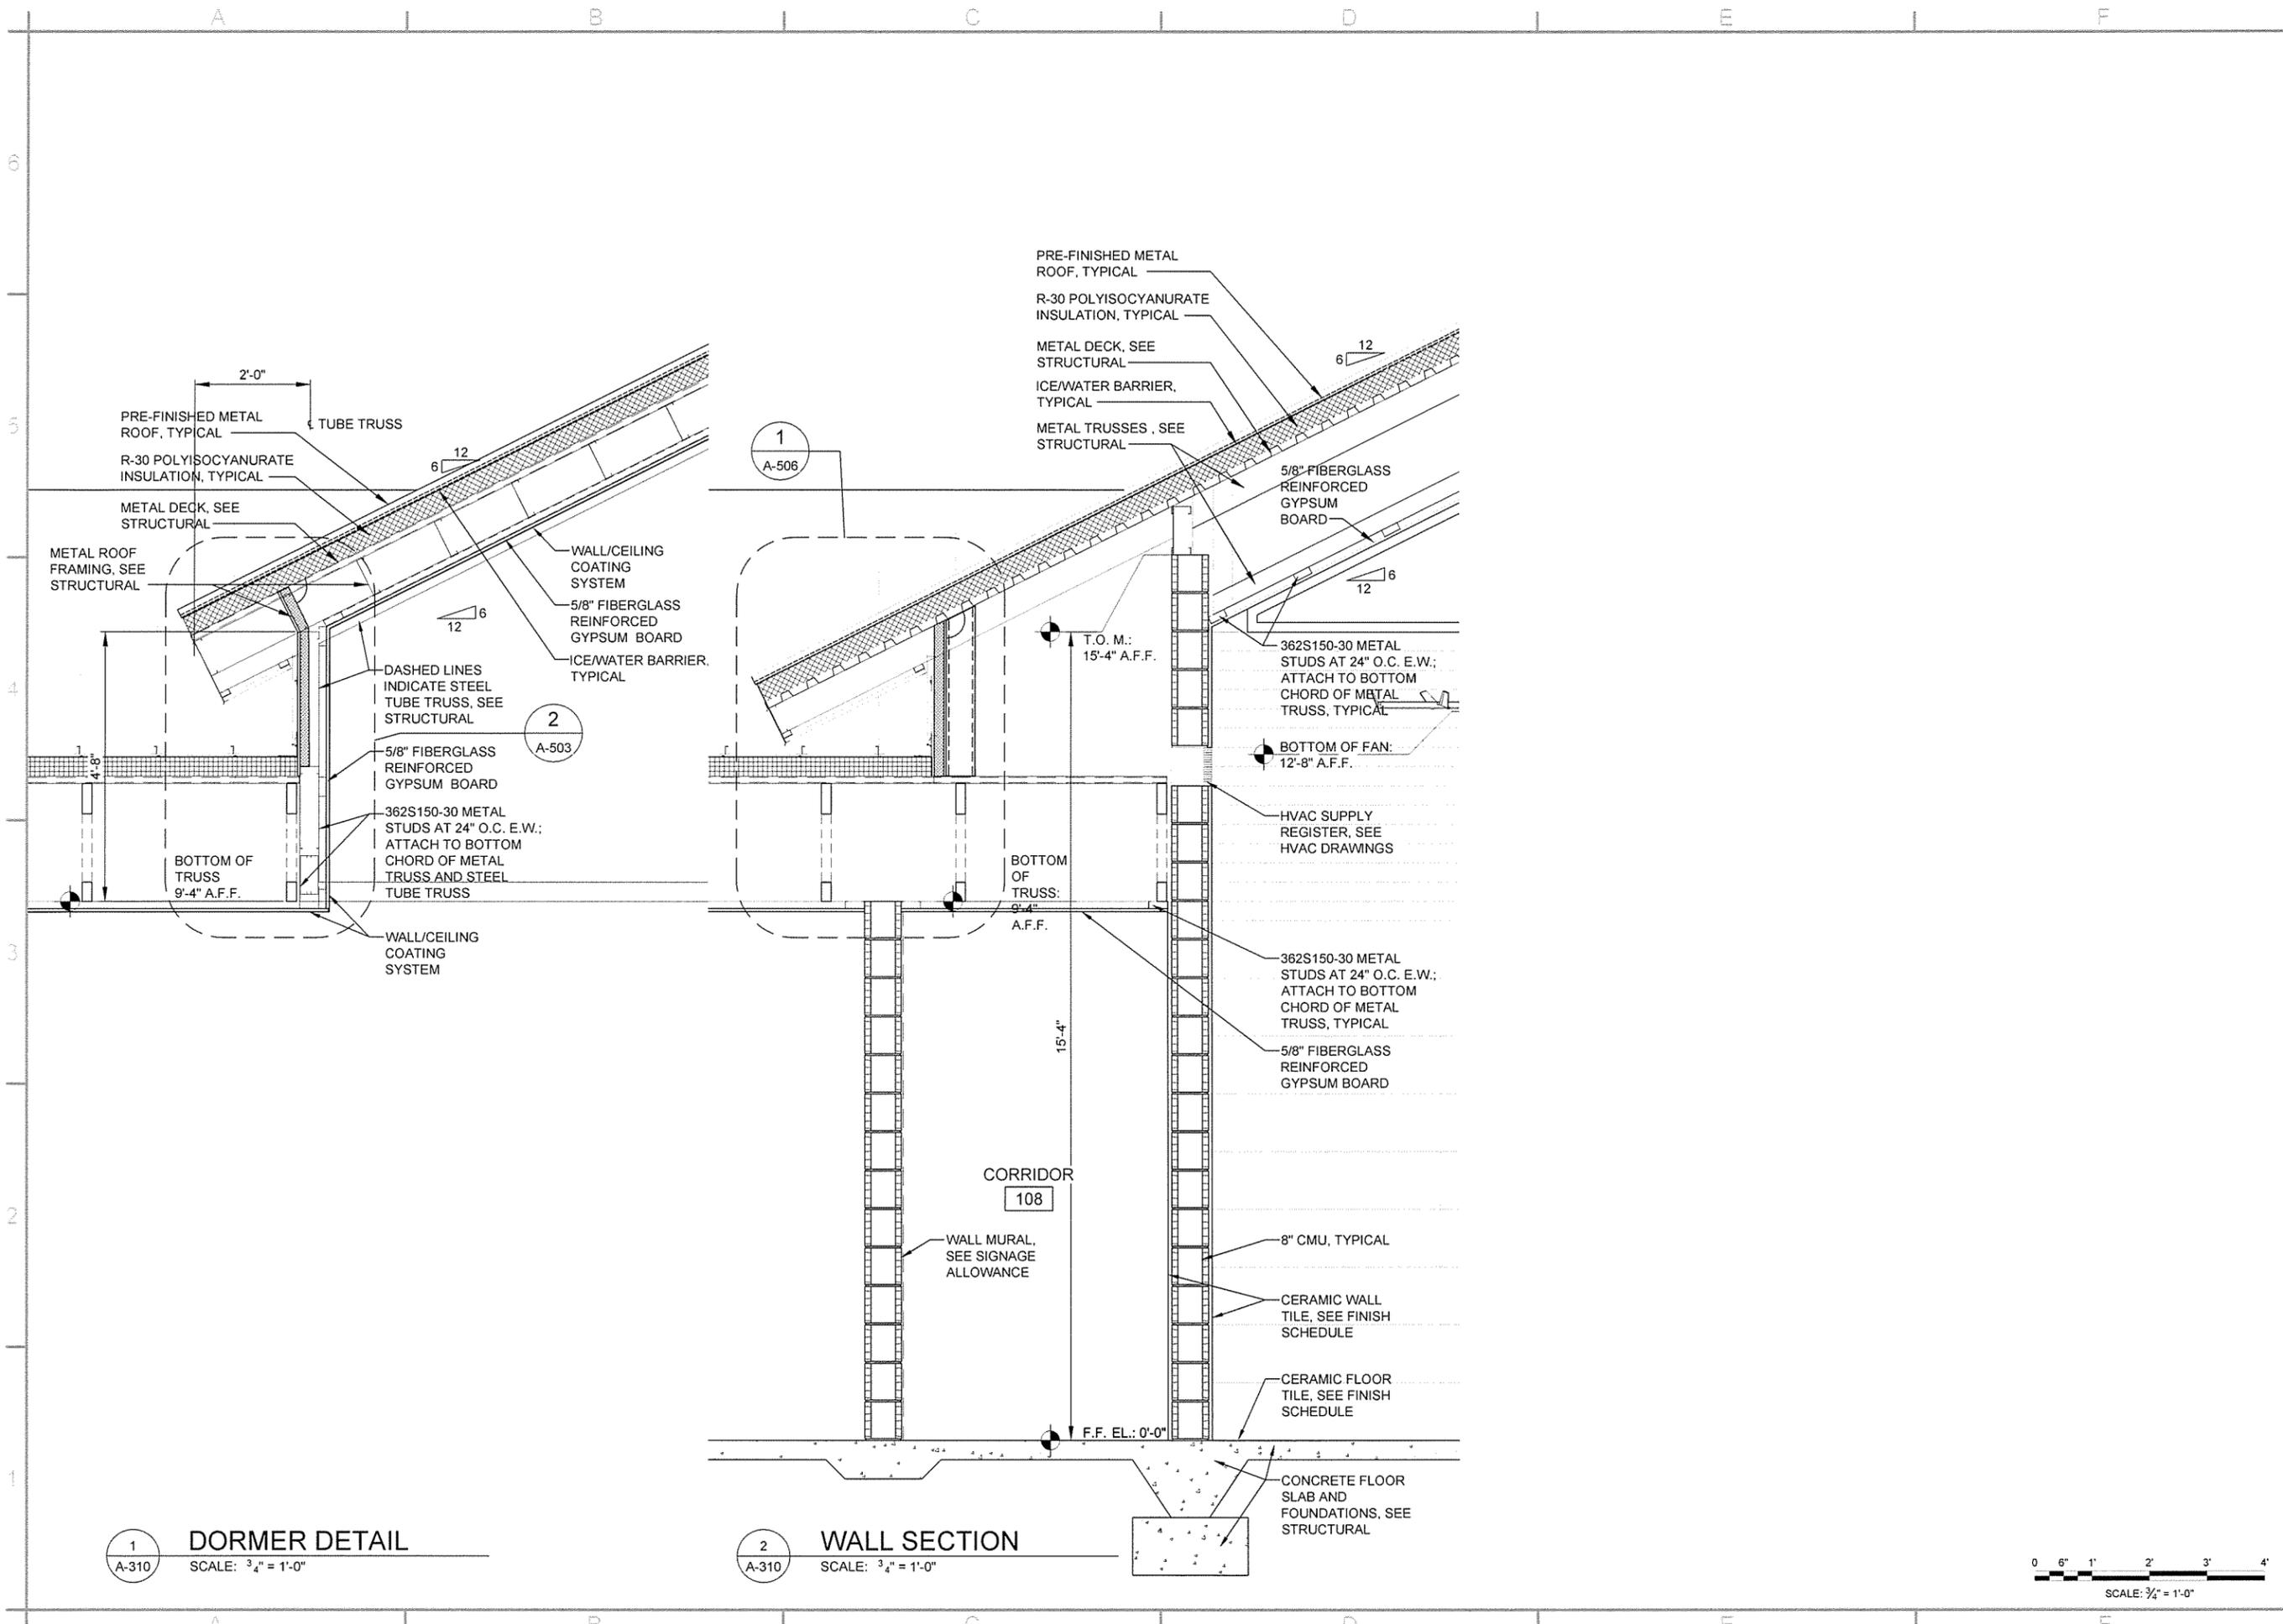

1 DORMER DETAIL
SCALE: 3/4" = 1'-0"

2 WALL SECTION
SCALE: 3/4" = 1'-0"

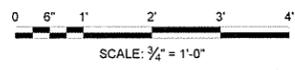

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REGISTERED ARCHITECT
Cass A. Archer
License No. 2671
STATE OF ARKANSAS

JRR
Appr.
10/1/15
Date

ISSUED FOR CONSTRUCTION
Description

IFC
Symbol

Job Number 060451	Submitted by John T. Watkins, III, PE, SE Director, Federal Services	Plot Scale 1:1	Divig Code
Drawn by J. RAMSEY	Plot Date 10/1/15	1:1	
Designed by J. RAMSEY	Checked by G. ARCHER		File Name AHSWR-A-310.DWG

ARKANSAS HIGHWAY AND TRANSPORTATION DEPARTMENT
ARKANSAS TOURIST INFORMATION CENTER
(WHITE RIVER) (S)
JOB 061451


TOURIST INFORMATION CENTER
WALL SECTIONS

Sheet Reference Number:
A-310
Sheet 58 of 130


Job Number	090451
Submitted by	John T. Walkers, III, PE, SE Director, Federal Services
Plat Date	10/1/15
Plat Scale	1:1
Drwg Code	
File Name	AH15WR-A-321 DWG
Issued For Construction	10/1/15
Date	
Appr.	
IFC Symbol	
Description	

Designed by	J. RAMSEY
Drawn by	J. RAMSEY
Checked by	G. ARCHER
Job Number	090451
Submitted by	John T. Walkers, III, PE, SE Director, Federal Services
Plat Date	10/1/15
Plat Scale	1:1
Drwg Code	
File Name	AH15WR-A-321 DWG

ARKANSAS HIGHWAY AND TRANSPORTATION DEPARTMENT
 ARKANSAS TOURIST INFORMATION CENTER
 (WHITE RIVER) (S)
 JOB 061451
 MAINTENANCE BUILDING
 BUILDING SECTION

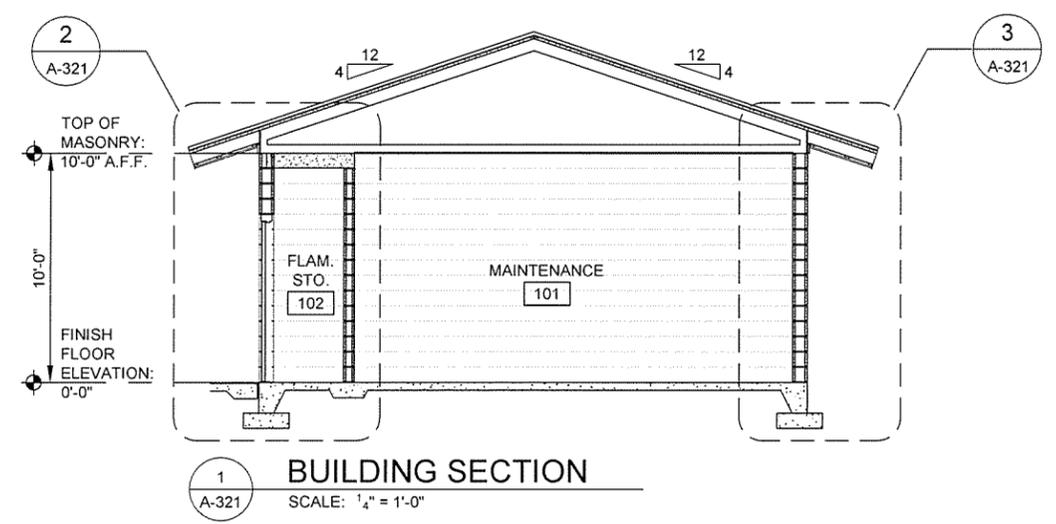


1 BUILDING SECTION
 SCALE: 1/4" = 1'-0"

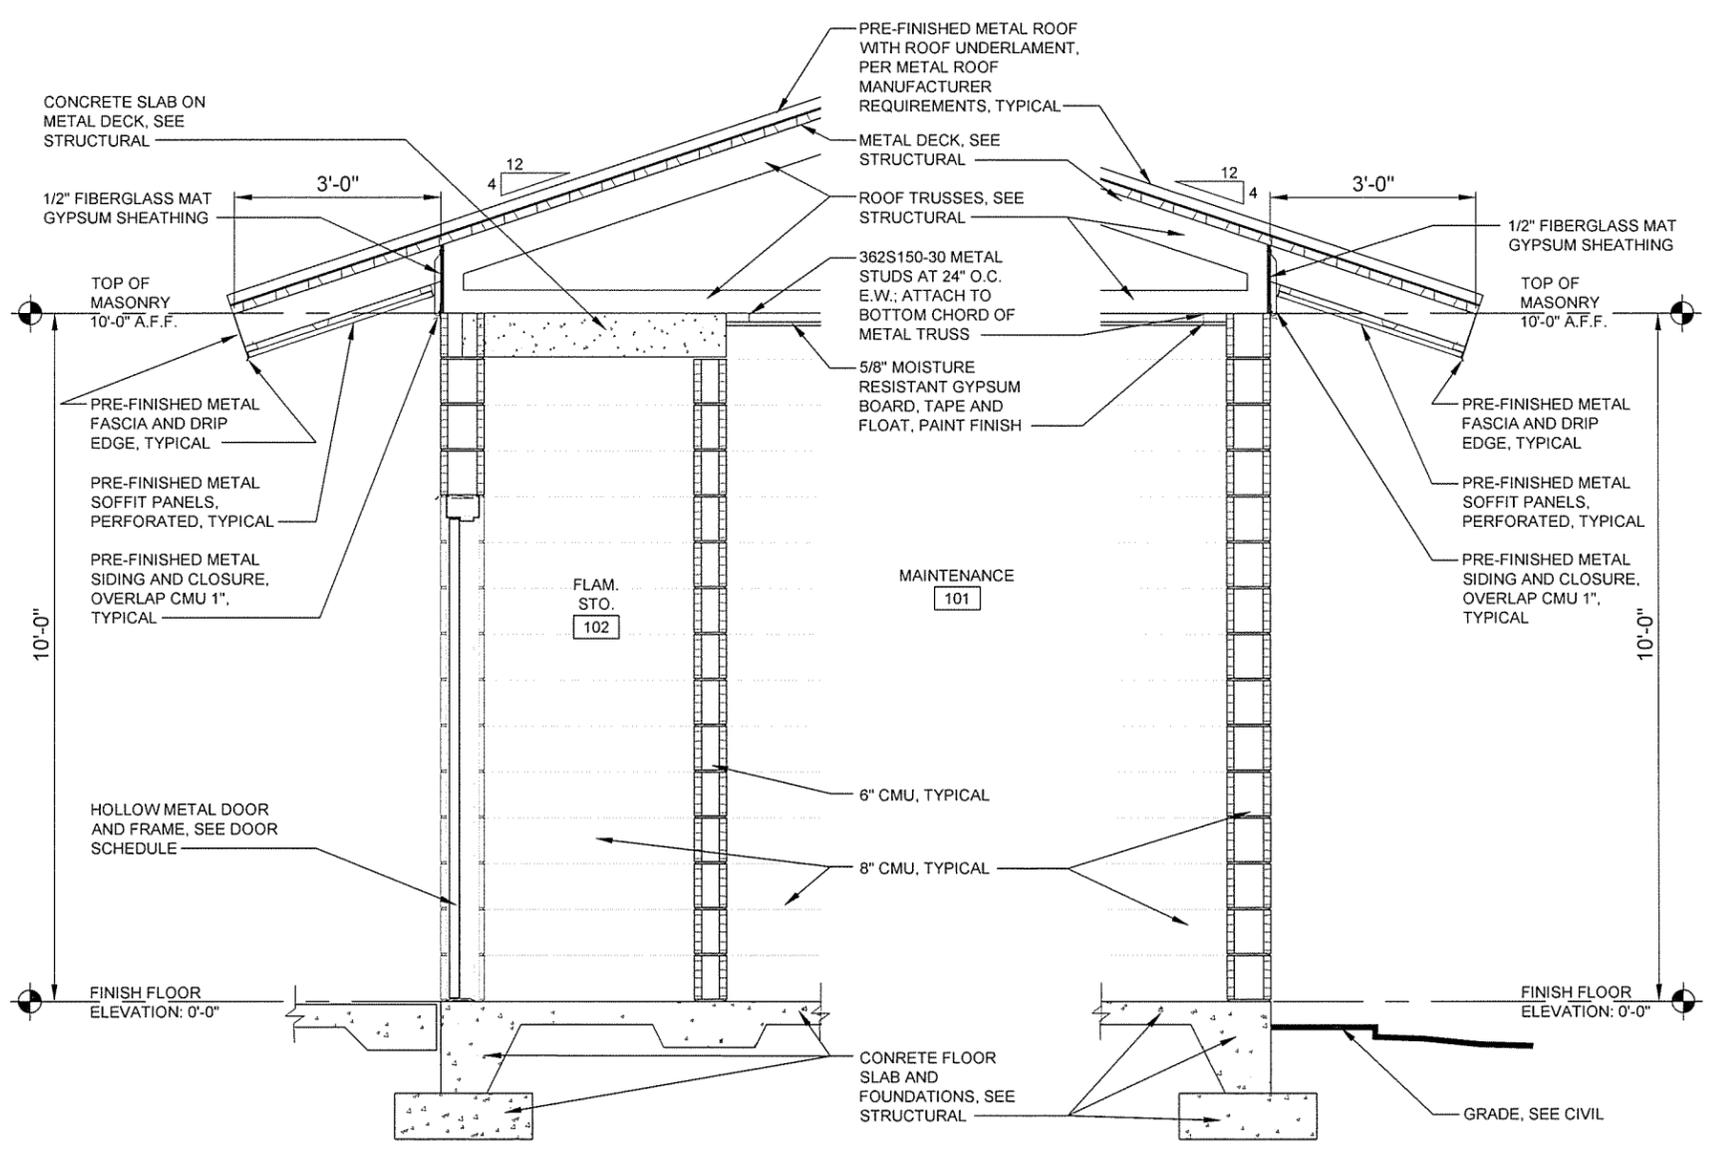


2 WALL SECTION
 SCALE: 3/4" = 1'-0"

3 WALL SECTION
 SCALE: 3/4" = 1'-0"

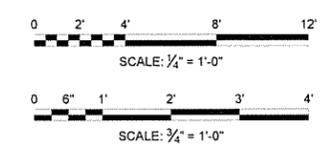


A B C D E F

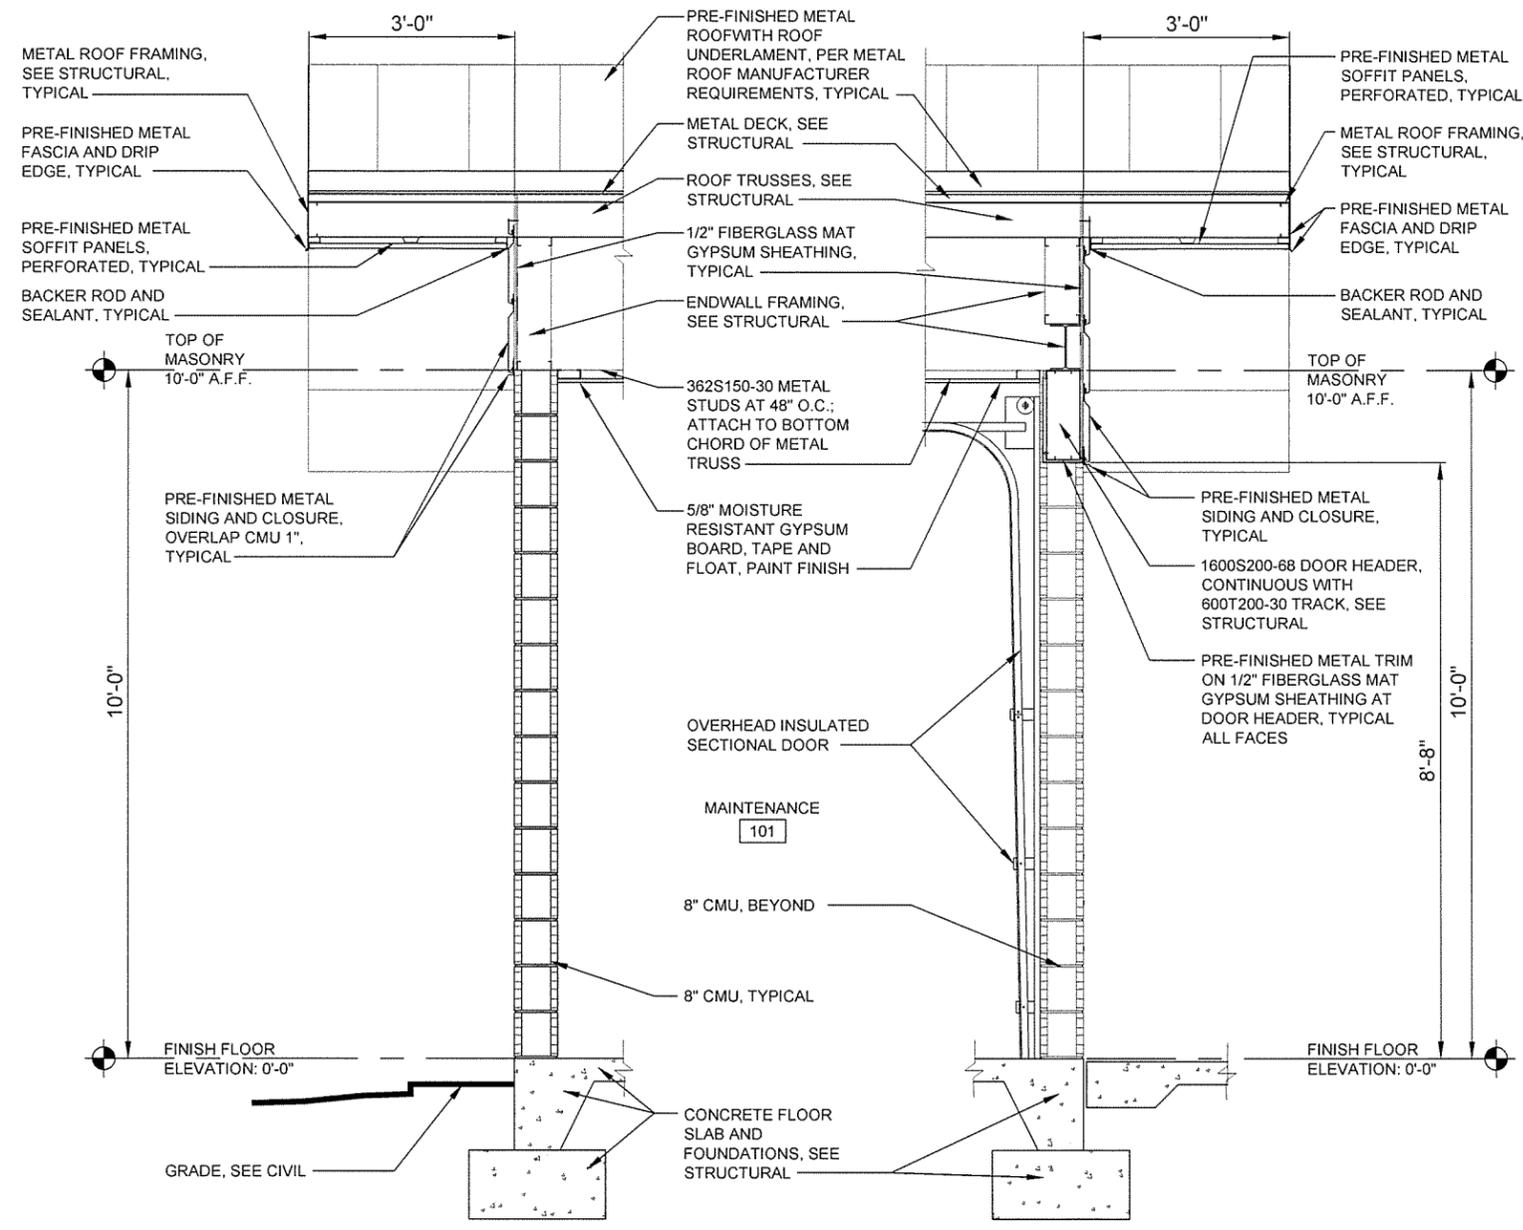

1 WALL SECTION
SCALE: 3/4" = 1'-0"

2 WALL SECTION
SCALE: 3/4" = 1'-0"

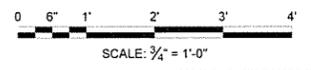


JRR	Appr.
10/1/15	Date
ISSUED FOR CONSTRUCTION	Description
IFC	Symbol

Job Number	009451
Submitted by	John T. Watkins, III, PE, SE Director, Federal Services
Drawn by	J. RAMSEY
Checked by	G. ARCHER
Plot Date	10/1/15
Plot Scale	1:1
Draw Code	
File Name	AH19WR-A-322.DWG


ARKANSAS HIGHWAY AND TRANSPORTATION DEPARTMENT
ARKANSAS TOURIST INFORMATION CENTER
(WHITE RIVER) (S)
JOB 061451

MAINTENANCE BUILDING
WALL SECTIONS


Sheet Reference Number:
A-322
Sheet 60 of 130

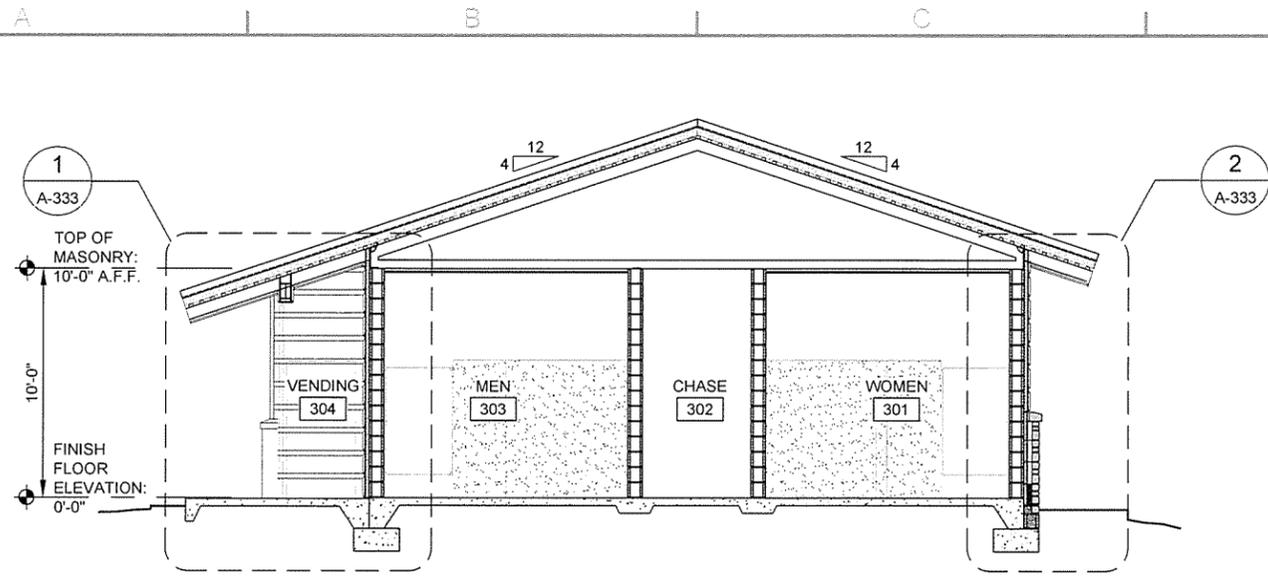


1 BUILDING SECTION
A-331 SCALE: 1/4" = 1'-0"

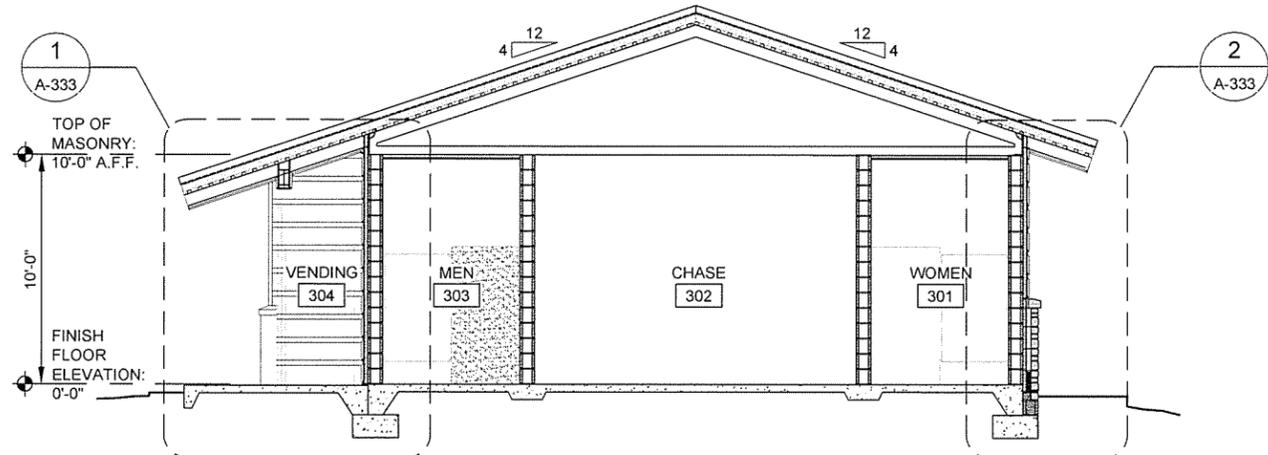

2 BUILDING SECTION
A-331 SCALE: 1/4" = 1'-0"

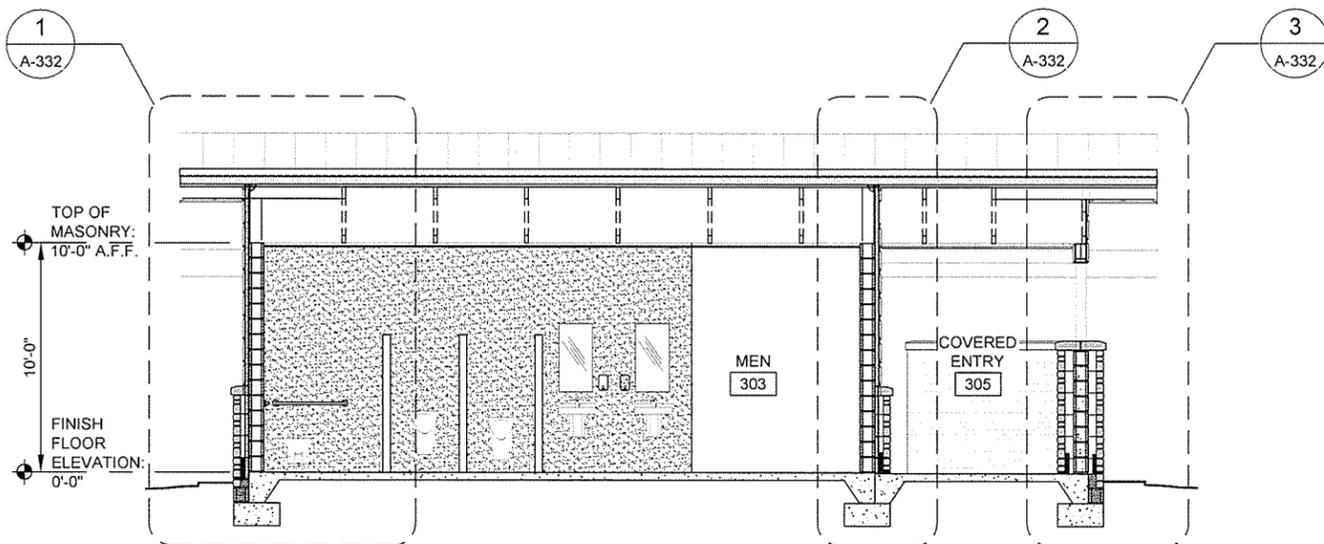

3 BUILDING SECTION
A-331 SCALE: 1/4" = 1'-0"

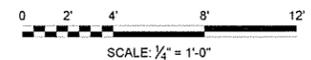

JRR	Appr.
10/1/15	Date

ISSUED FOR CONSTRUCTION	Description
IFC	Symbol

Submitted by John T. Watkins, III, PE, SE Director, Federal Services	Job Number 000451
Plot Date 10/1/15	Plot Scale 1:1
Drawn by J. RAMSEY	Dwg. Code N/A
Checked by G. ARCHER	File Name AHSVR-A-331.DWG

ARKANSAS HIGHWAY AND TRANSPORTATION DEPARTMENT
ARKANSAS TOURIST INFORMATION CENTER
(WHITE RIVER) (S)
JOB 081451
TRUCKER-VENDING BUILDING
BUILDING SECTIONS


Sheet Reference Number:
A-331
Sheet 61 of 130

JRR	Appr.
10/1/15	Date
ISSUED FOR CONSTRUCTION	Description
IPC	Symbol

Job Number	000-51	N/A	N/A	N/A
Submitted by	John T. Walters, III, PE, SE Director, Federal Services	Plot Date	10/1/15	Drawn by
Designed by	J. RAMSEY	Plot Scale	1:1	Checked by
Drawn by	J. RAMSEY	Dirng Code		G. ARCHER
File Name	AHTSWR-A-332.DWG			

ARKANSAS HIGHWAY AND TRANSPORTATION DEPARTMENT
 ARKANSAS TOURIST INFORMATION CENTER
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 JOB 081451


TRUCKER-VENDING BUILDING
 WALL SECTIONS

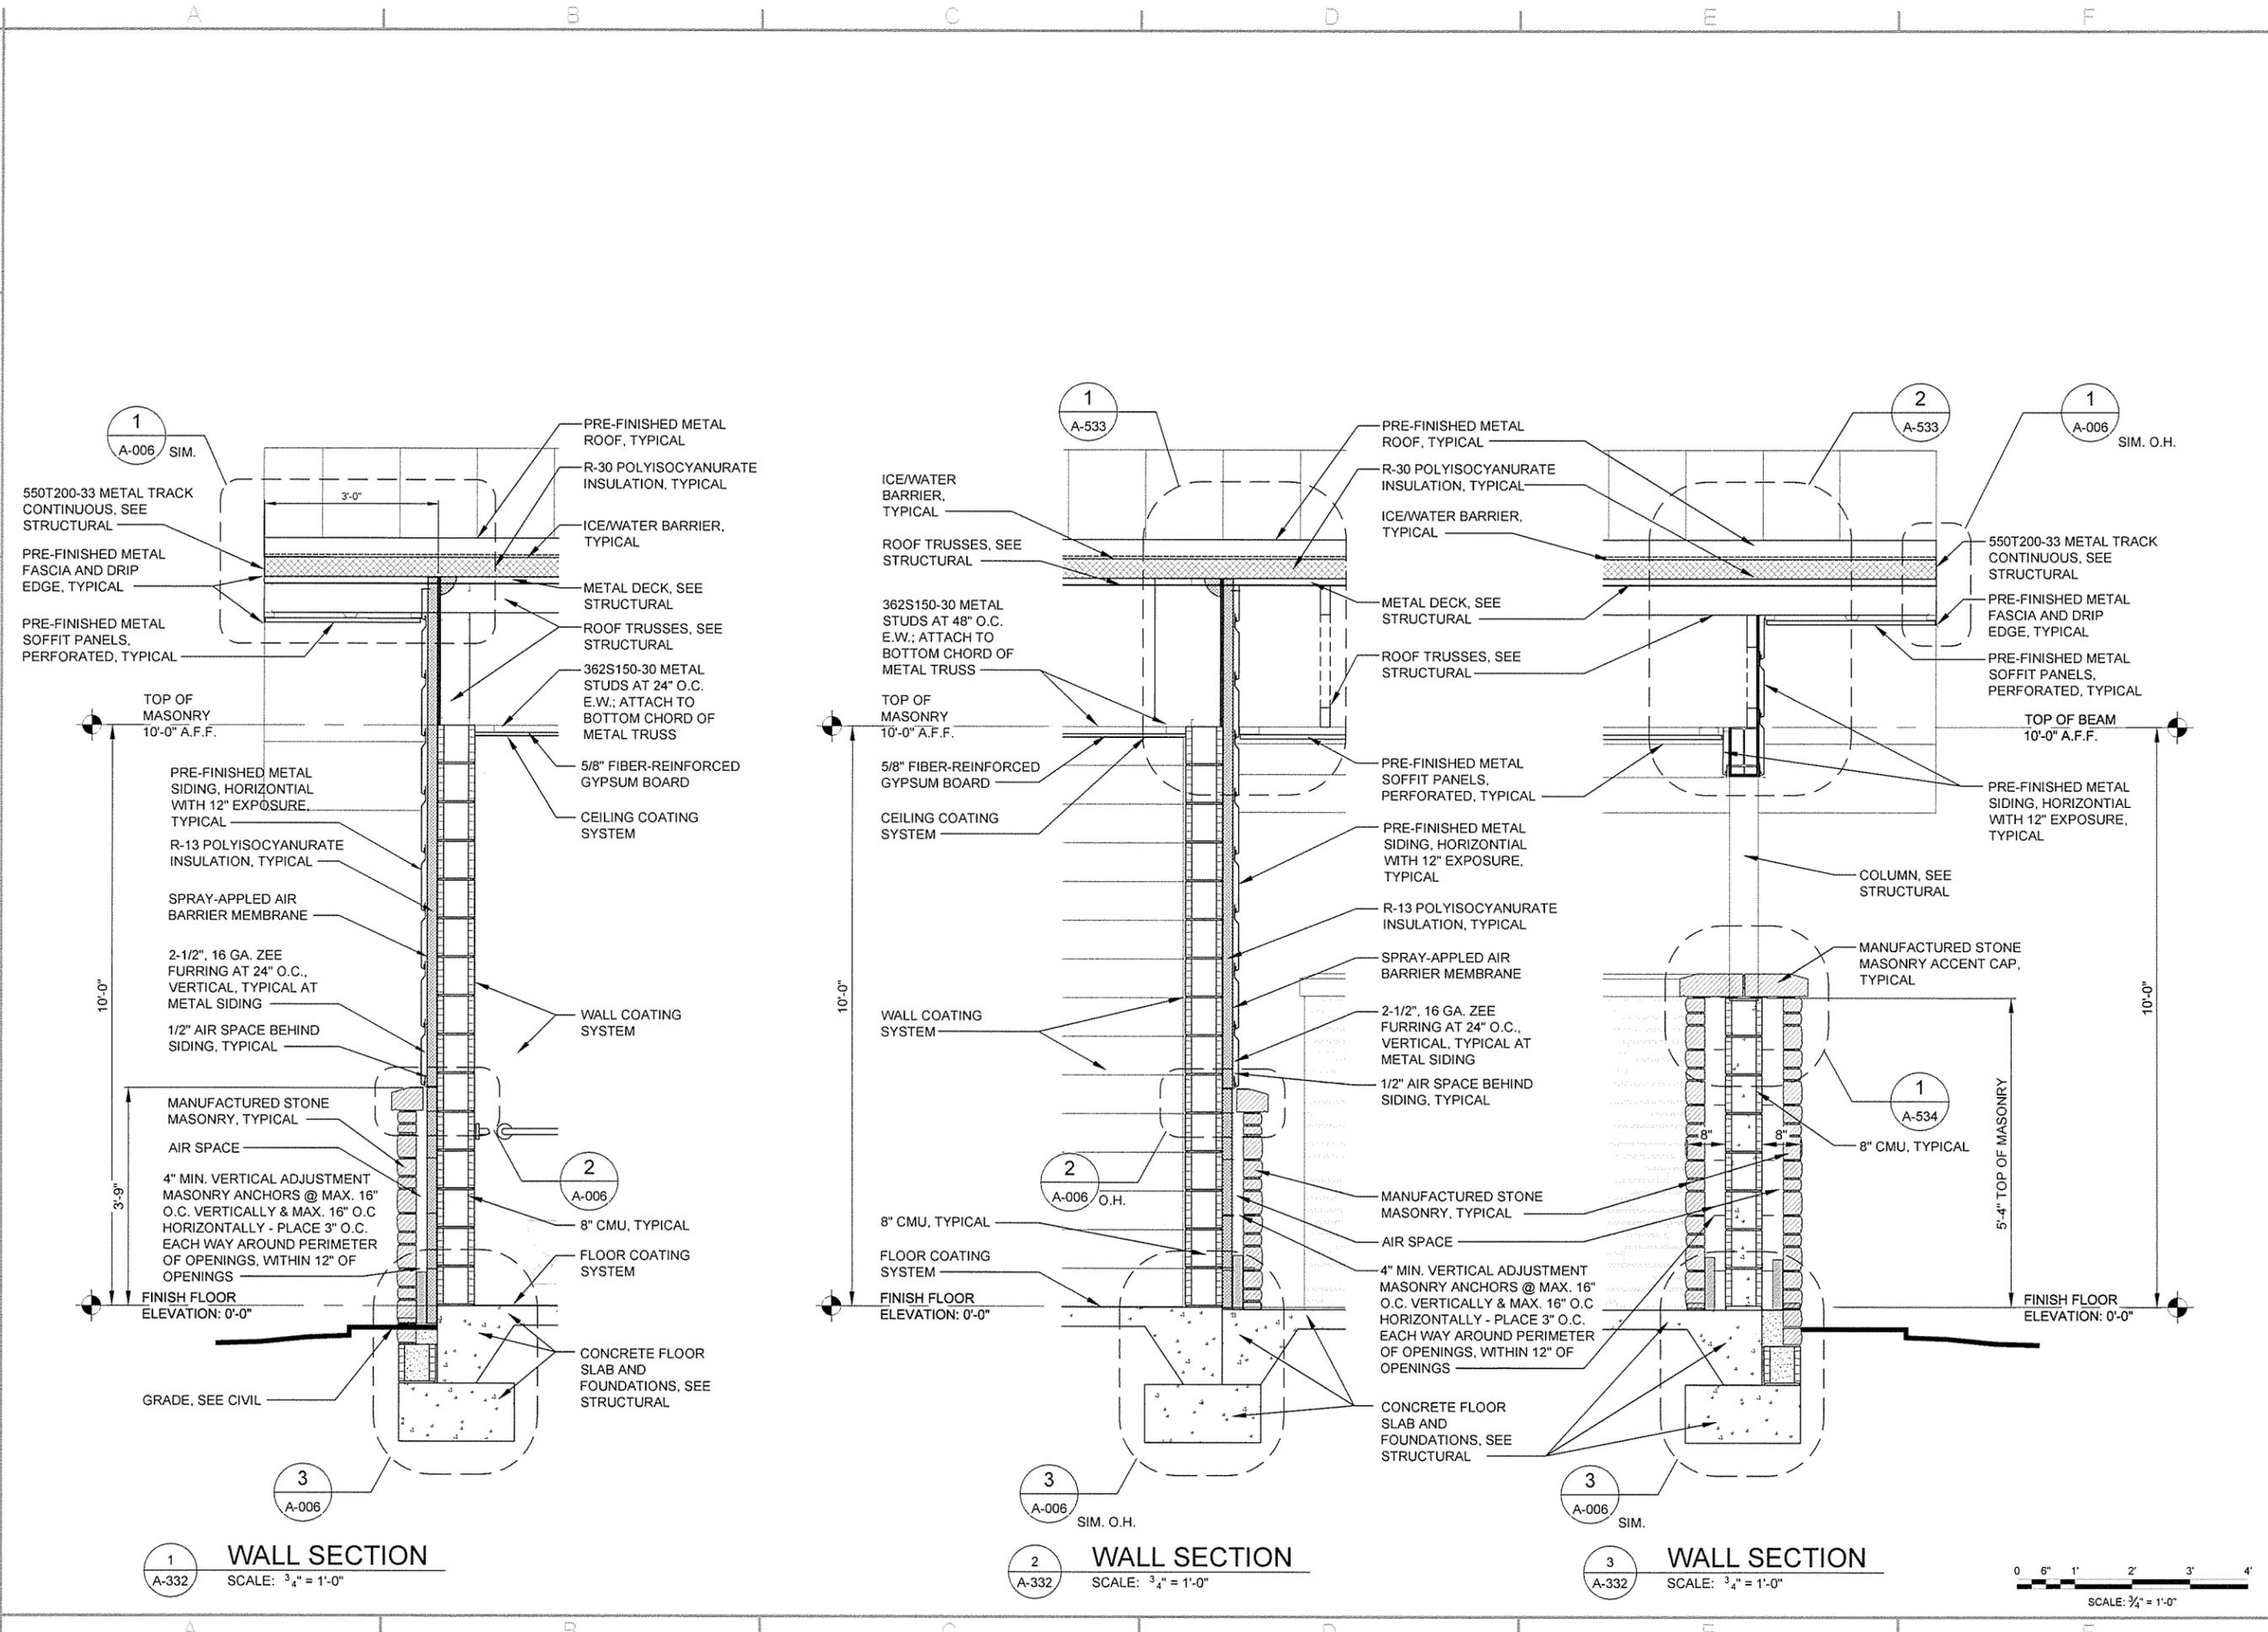


1
 A-332 **WALL SECTION**
 SCALE: 3/4" = 1'-0"

2
 A-332 **WALL SECTION**
 SCALE: 3/4" = 1'-0"

3
 A-332 **WALL SECTION**
 SCALE: 3/4" = 1'-0"


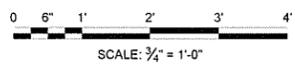


A B C D E F

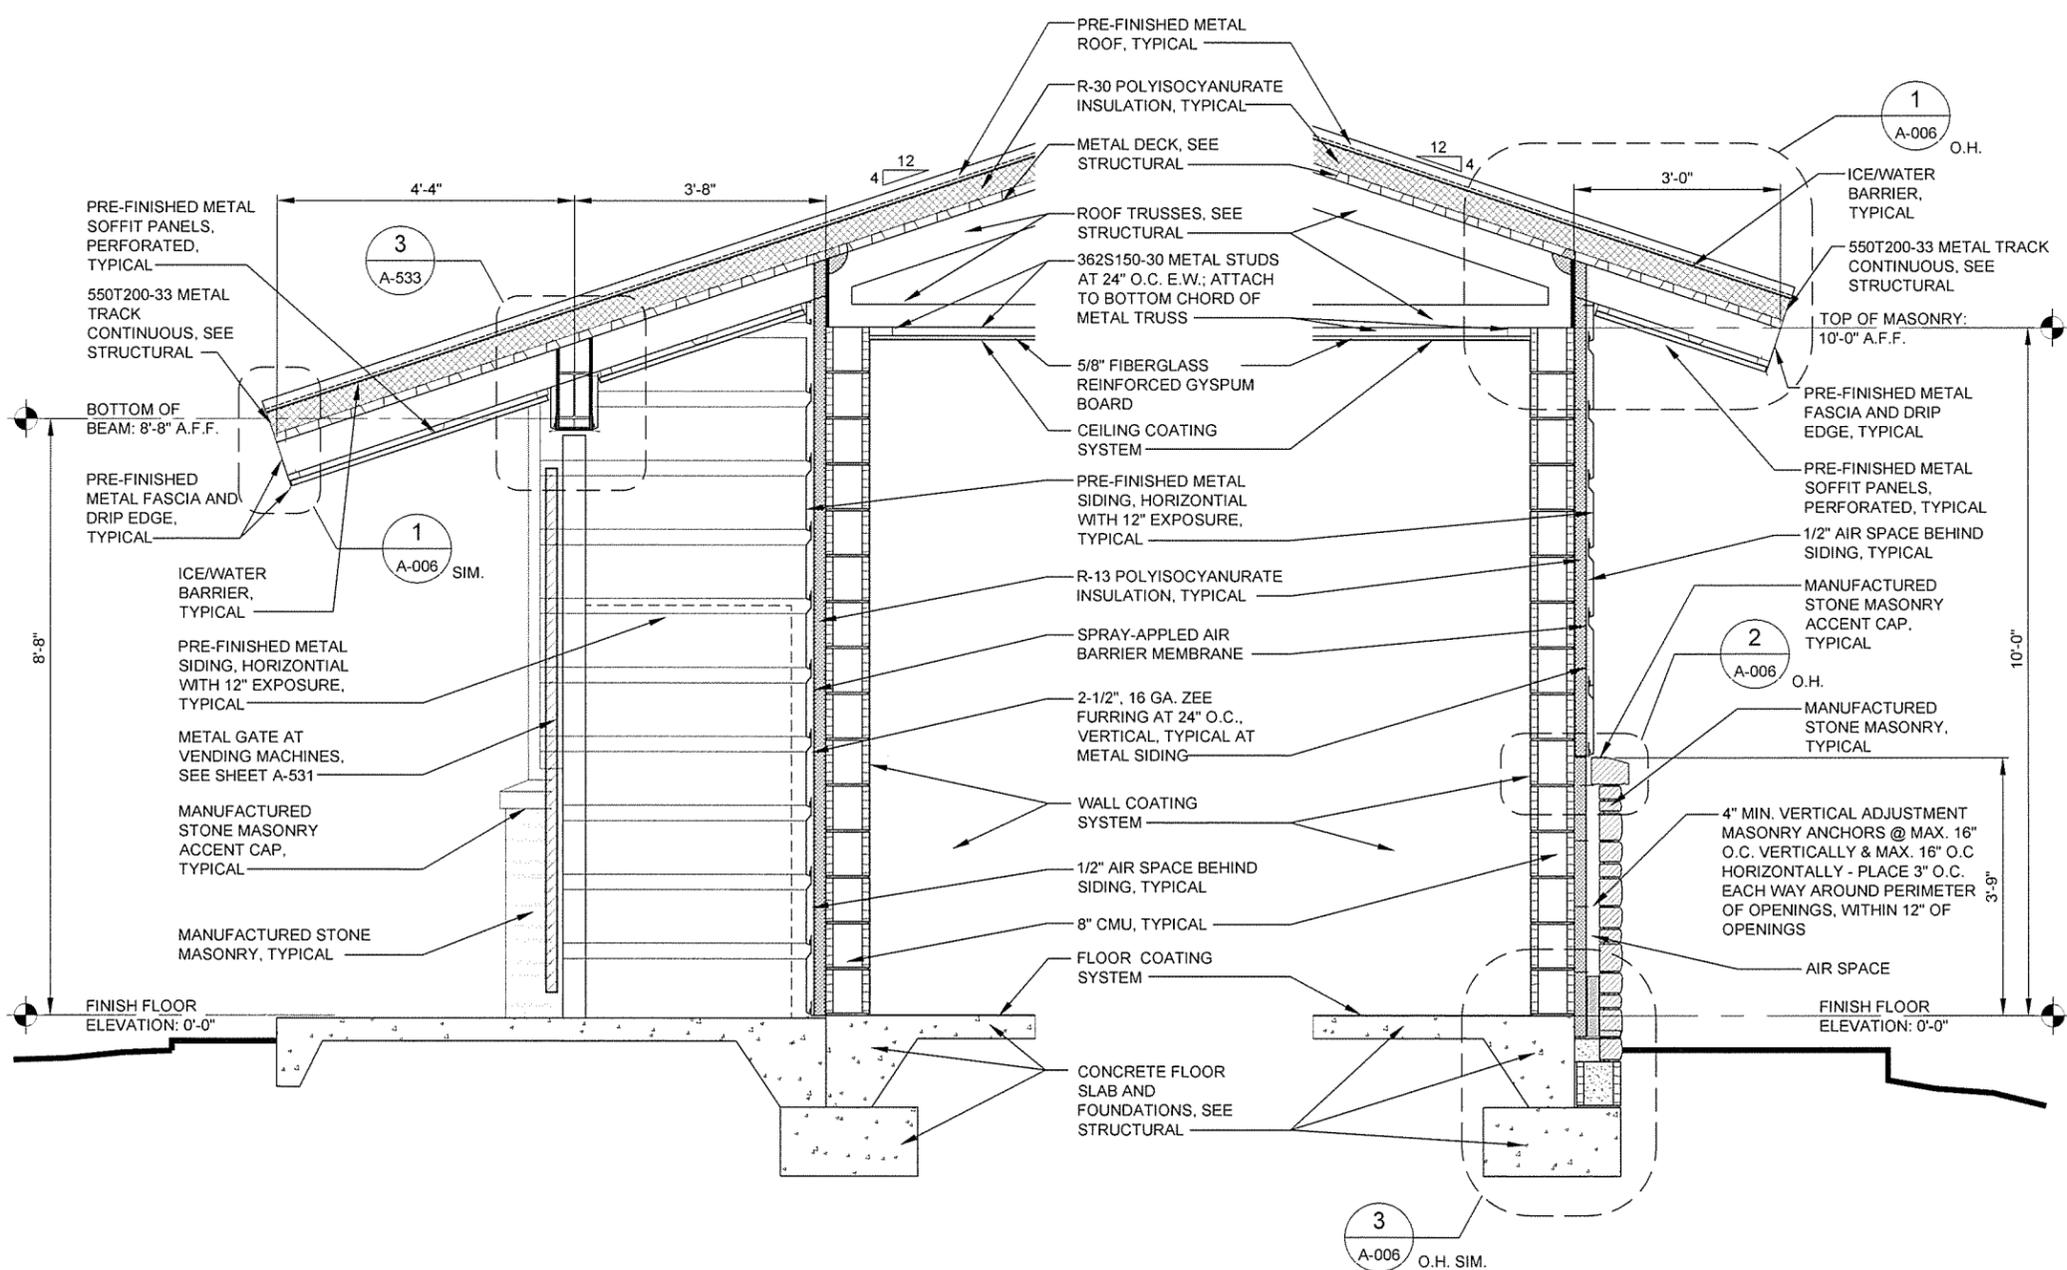


1 WALL SECTION
 A-333 SCALE: 3/4" = 1'-0"

2 WALL SECTION
 A-333 SCALE: 3/4" = 1'-0"

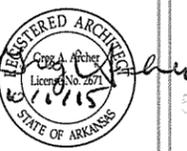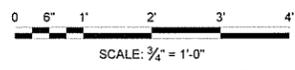


Job Number	000451	Job Title	N/A	Job Date	10/1/15	Job Code	N/A
Submitted by	John T. Watkins, III, PE, SE Director, Federal Services	Plot Scale	1:1	Plot Date	10/1/15	Drawn by	J. RAMSEY
Designed by	J. RAMSEY	Checked by	G. ARCHER	File Name	AH15WR-A-333 DWG	Drawn by	J. RAMSEY
Issued For Construction		Symbol		Date	10/1/15	Appr.	JRR


ARKANSAS HIGHWAY AND TRANSPORTATION DEPARTMENT
 ARKANSAS TOURIST INFORMATION CENTER
 (WHITE RIVER) (S)
 JOB 081451
 TRUCKER-VENDING BUILDING
 WALL SECTIONS

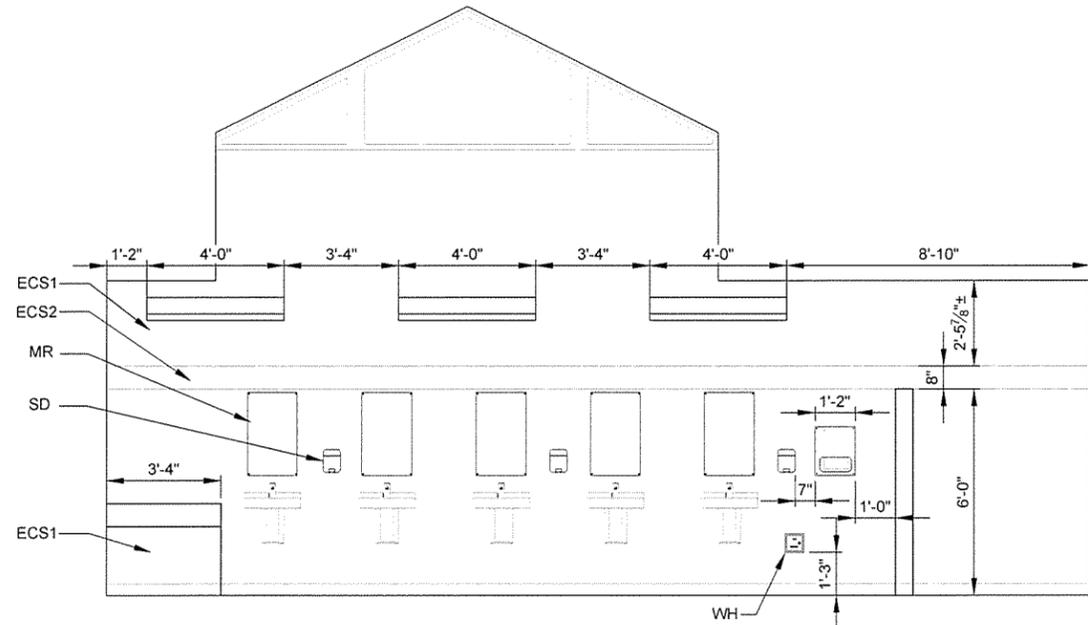


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 WOMEN'S RESTROOM 114
 SCALE: 3/8" = 1'-0"

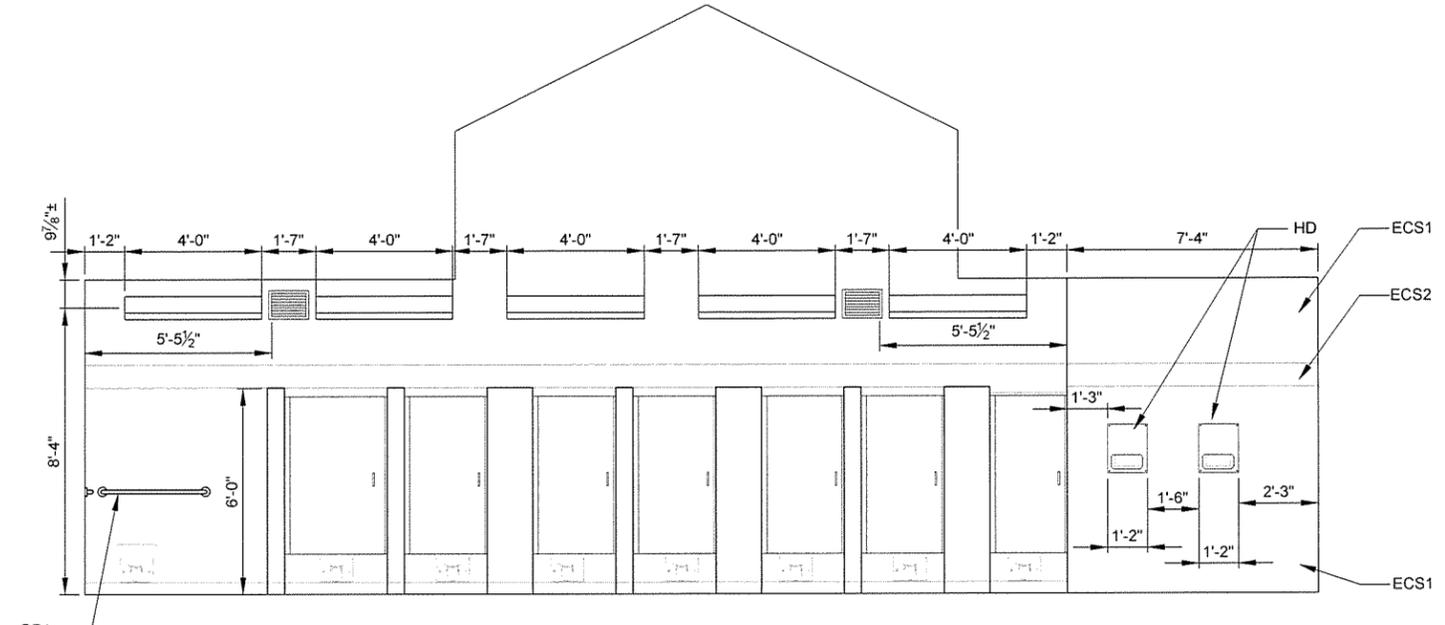

3
 WOMEN'S RESTROOM 114
 SCALE: 3/8" = 1'-0"

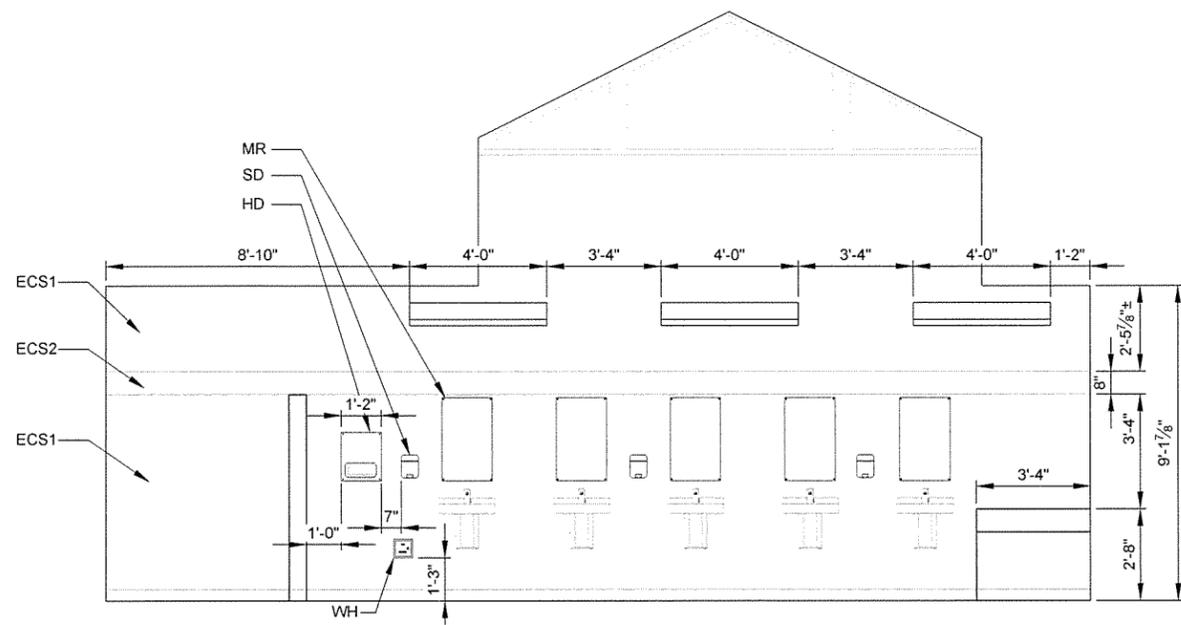


2
 MEN'S RESTROOM 111
 SCALE: 3/8" = 1'-0"

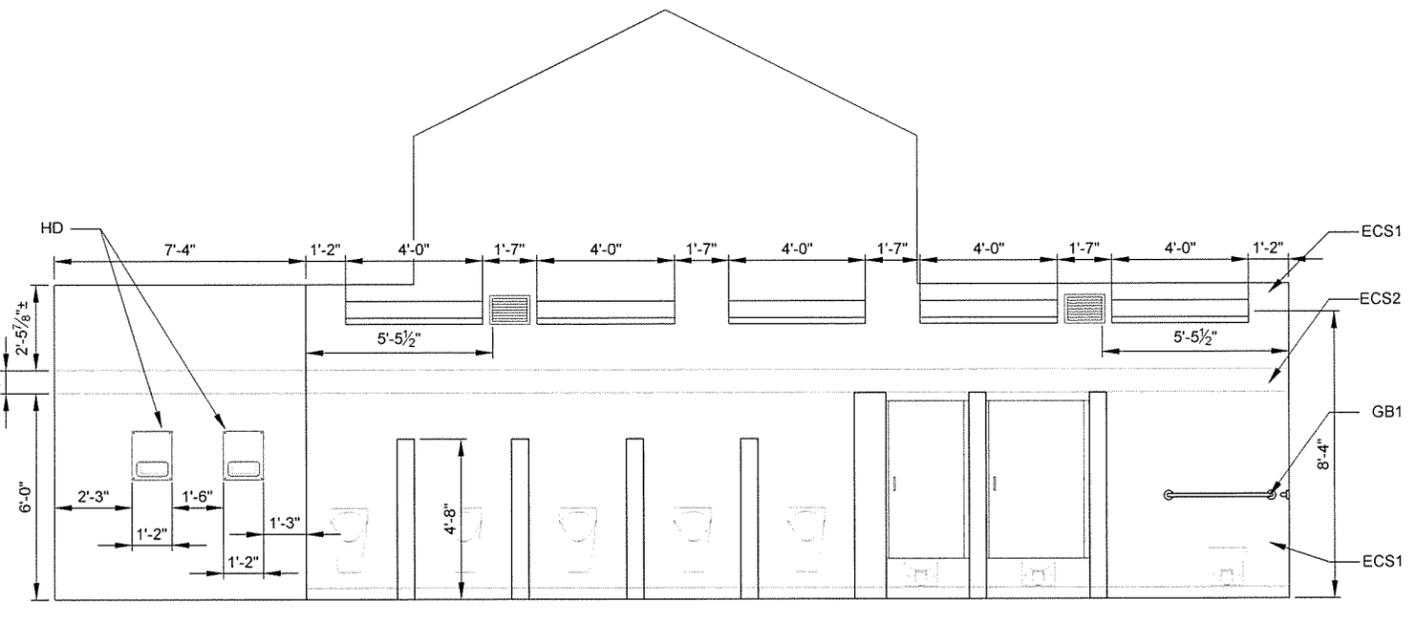

4
 MEN'S RESTROOM 111
 SCALE: 3/8" = 1'-0"


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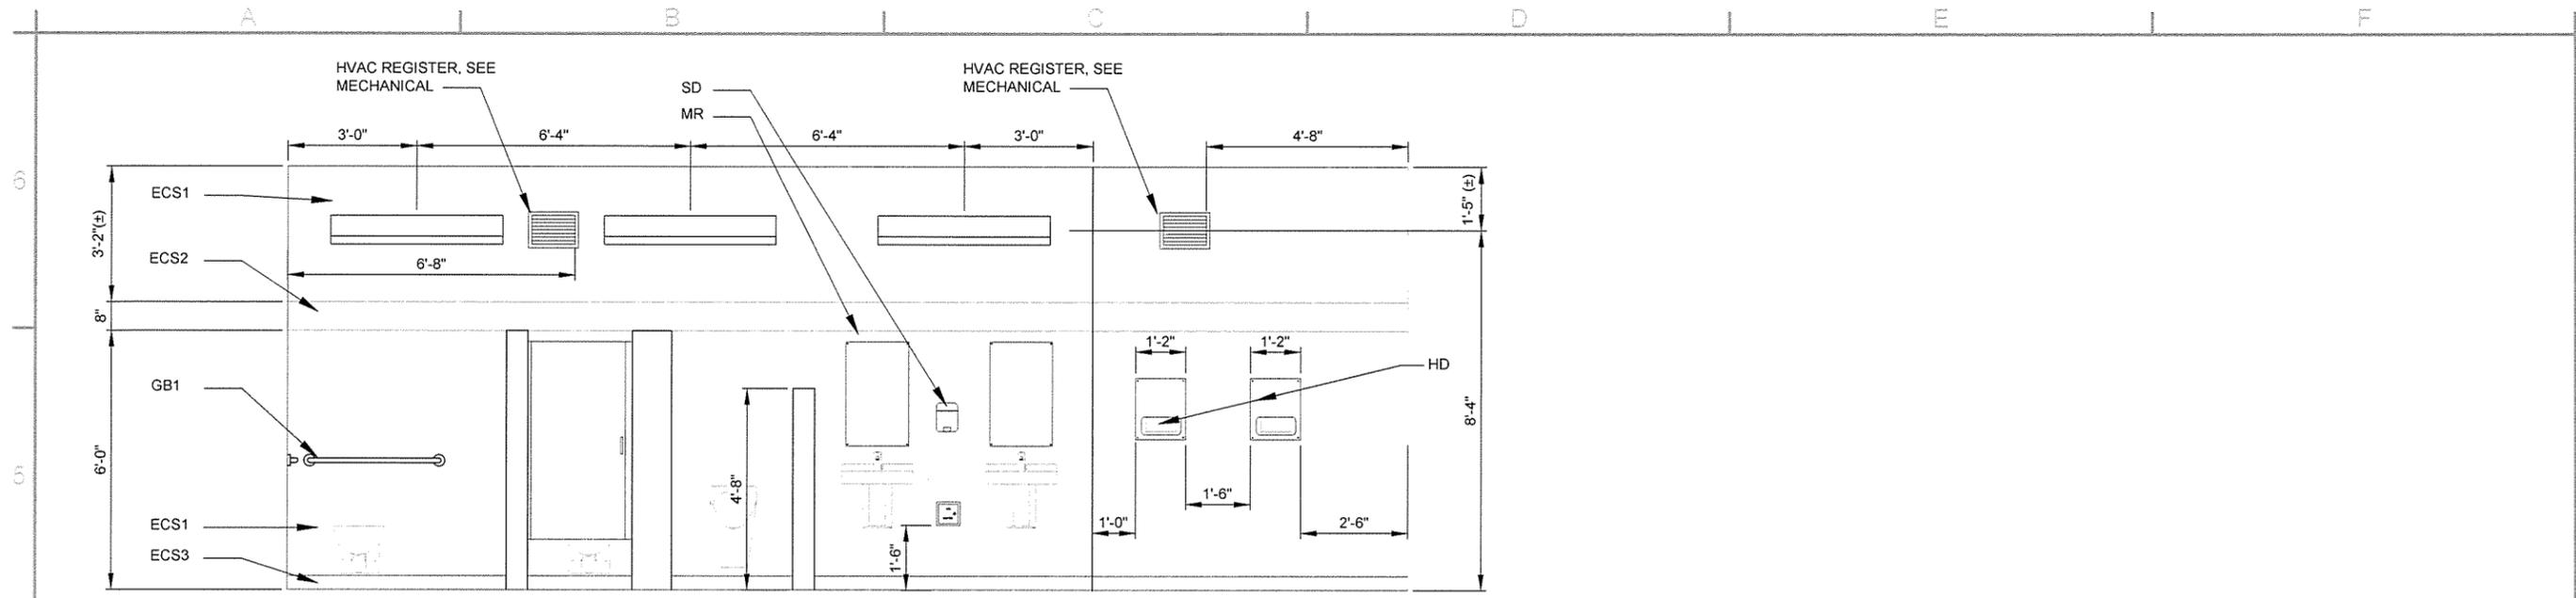


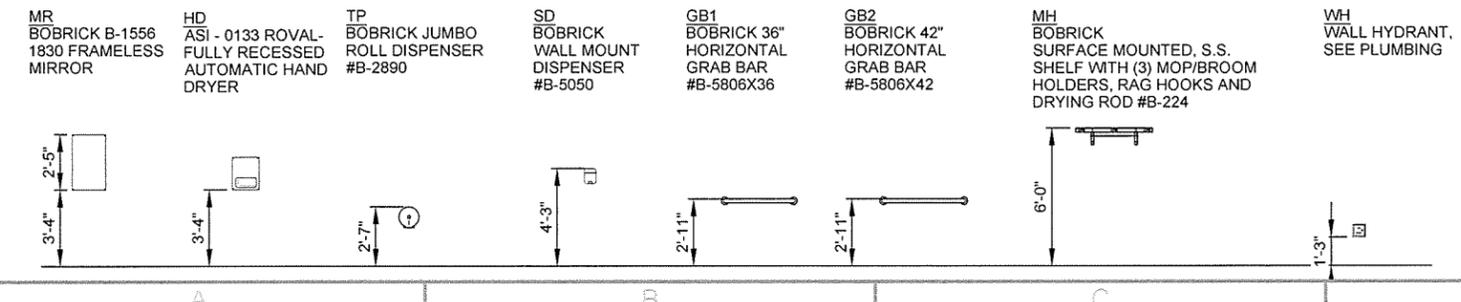GENERAL NOTES


- SEE SHEET A-103 FOR ADDITIONAL DIMENSIONS
- ECS1, ECS2 & ECS3; SEE ALLOWANCE NO. 3; SECTION 012100 - ALLOWANCES
- SEE SHEET A-103 FOR CMU TOILET PARTITION AND PARTITION DOOR DETAILS
- CENTER MIRRORS OVER LAVATORIES, TYPICAL
- CENTER SOAP DISPENSERS BETWEEN MIRRORS

LEGEND



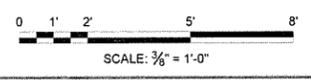


1 INTERIOR ELEVATION - MEN
 A-431 SCALE: 1/2" = 1'-0"

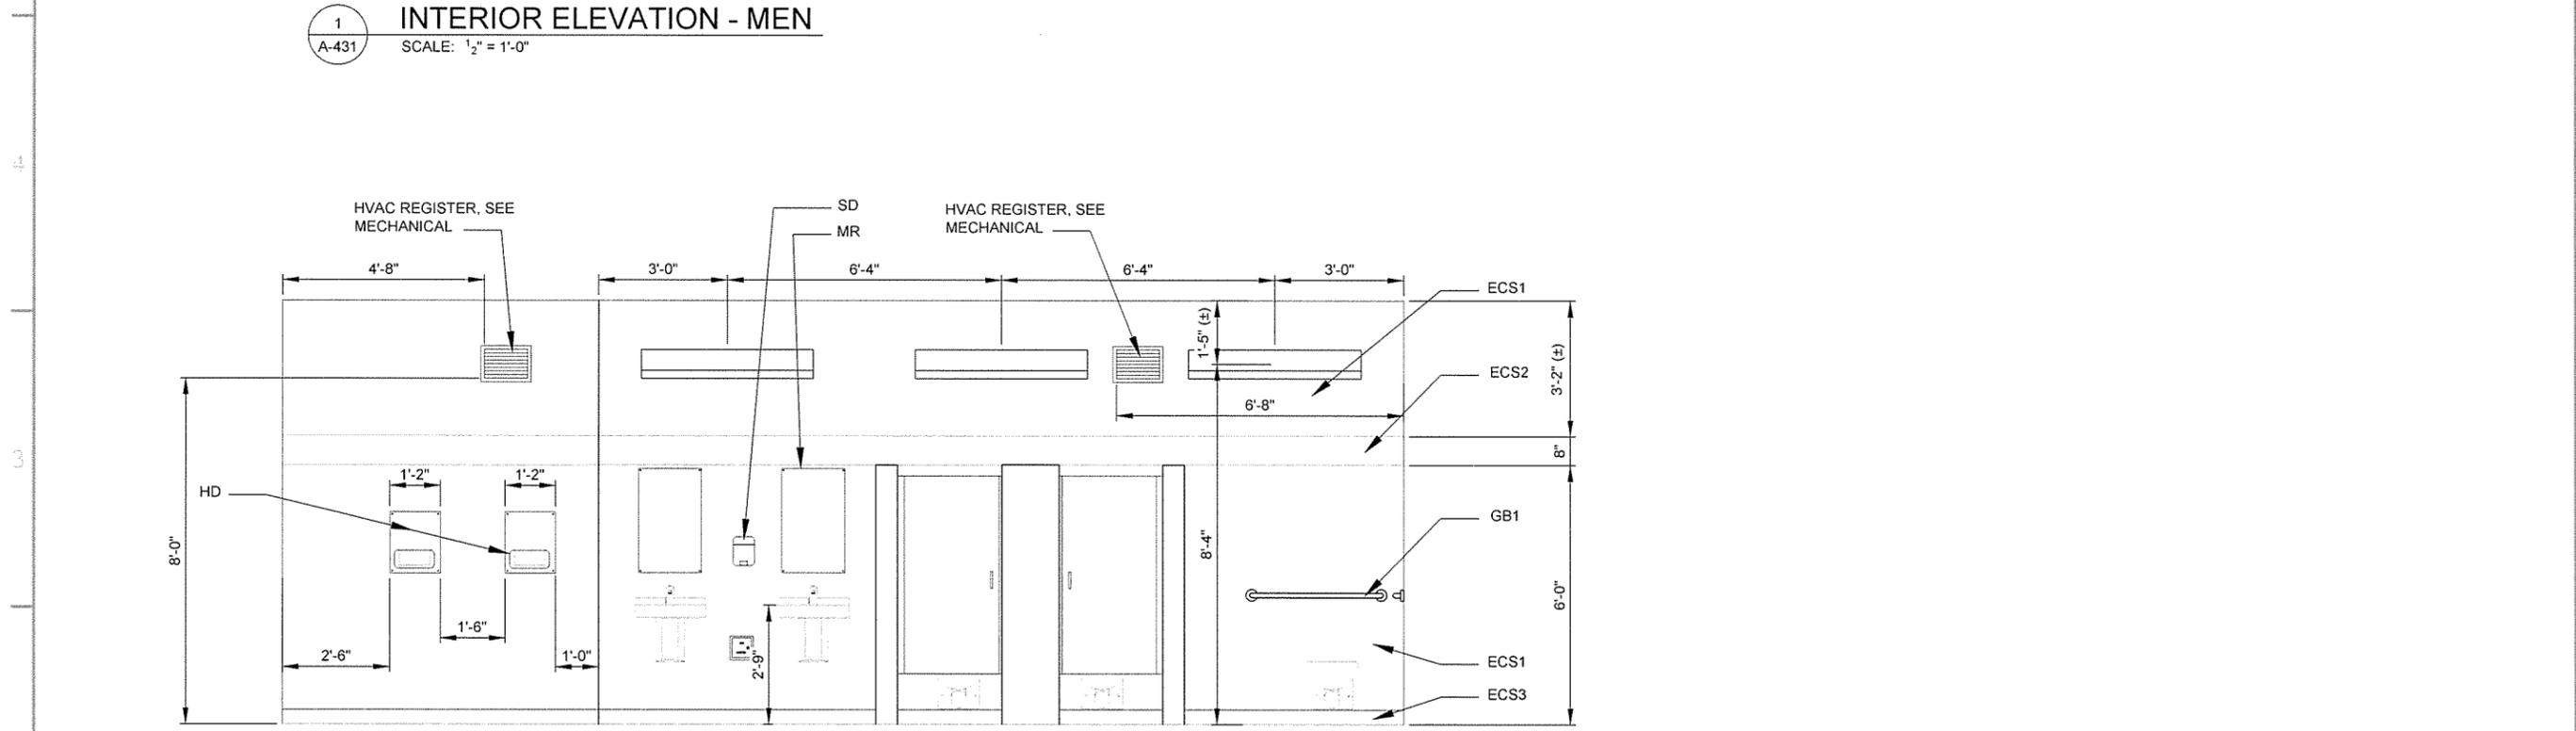



2 INTERIOR ELEVATION - WOMEN
 A-431 SCALE: 1/2" = 1'-0"

MOUNTING HEIGHTS

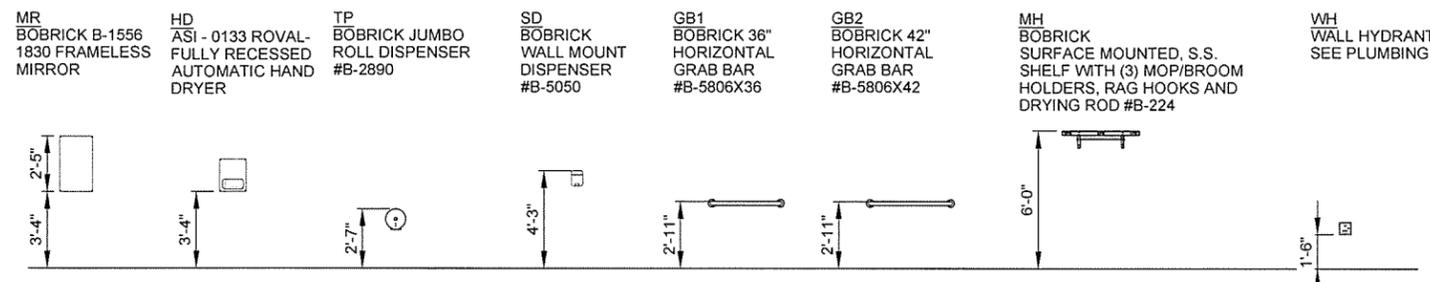

GENERAL NOTES


- SEE SHEET A-131 FOR ADDITIONAL DIMENSIONS
- ECS1, ECS2 & ECS3; SEE ALLOWANCE NO. 3; SECTION 012100 - ALLOWANCES
- SEE SHEET A-103 FOR CMU TOILET PARTITION AND PARTITION DOOR DETAILS
- CENTER MIRRORS OVER LAVATORIES, TYPICAL
- CENTER SOAP DISPENSERS BETWEEN MIRRORS

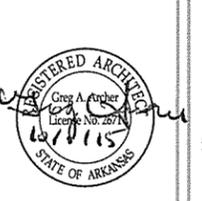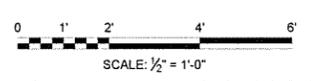


Job Number	06451
Submitted by	John T. Walkers, III, PE, SE Director, Federal Services
Drawn by	J. RAMSEY
Checked by	G. ARCHER
Plot Date	10/1/15
Plot Scale	1:1
Draw Code	
File Name	AH15WR-A-431 DWG
ICB Symbol	
ICB Description	ISSUED FOR CONSTRUCTION
Date	10/1/15
Appr	JRR

Job Number	06451
Submitted by	John T. Walkers, III, PE, SE Director, Federal Services
Drawn by	J. RAMSEY
Checked by	G. ARCHER
Plot Date	10/1/15
Plot Scale	1:1
Draw Code	
File Name	AH15WR-A-431 DWG


ARKANSAS HIGHWAY AND TRANSPORTATION DEPARTMENT
 ARKANSAS TOURIST INFORMATION CENTER
 (WHITE RIVER) (S)
 JOB 061451
 TRUCKER-VENDING BUILDING
 INTERIOR ELEVATIONS

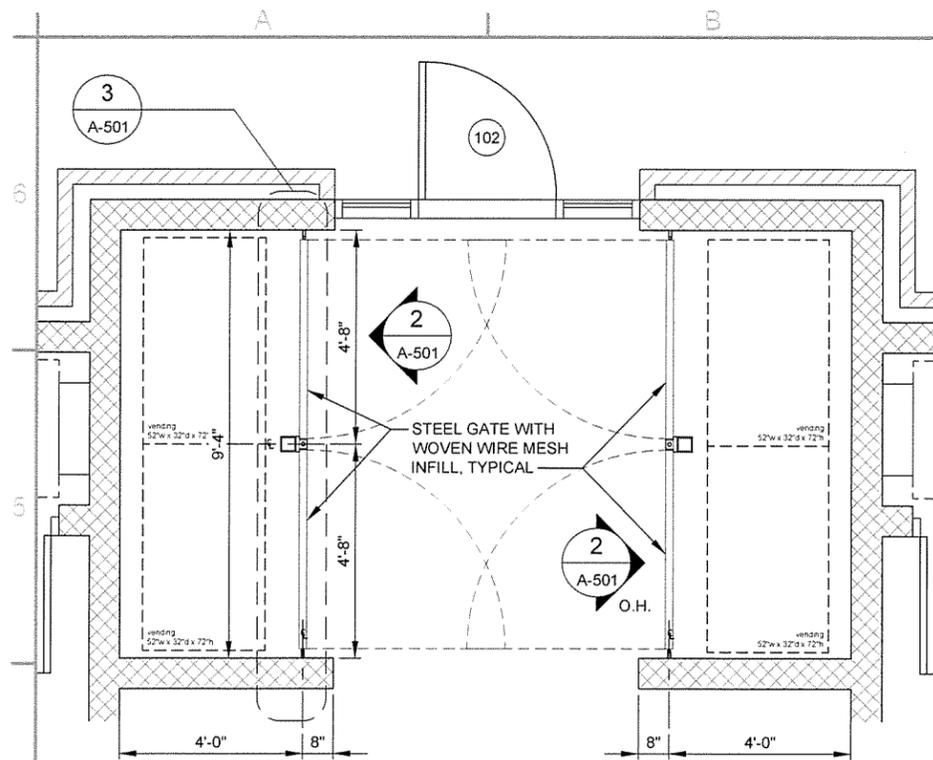


1 ENLARGED VENDING AREA PLAN
 A-501 SCALE: 1/2" = 1'-0"
 PLAN NORTH

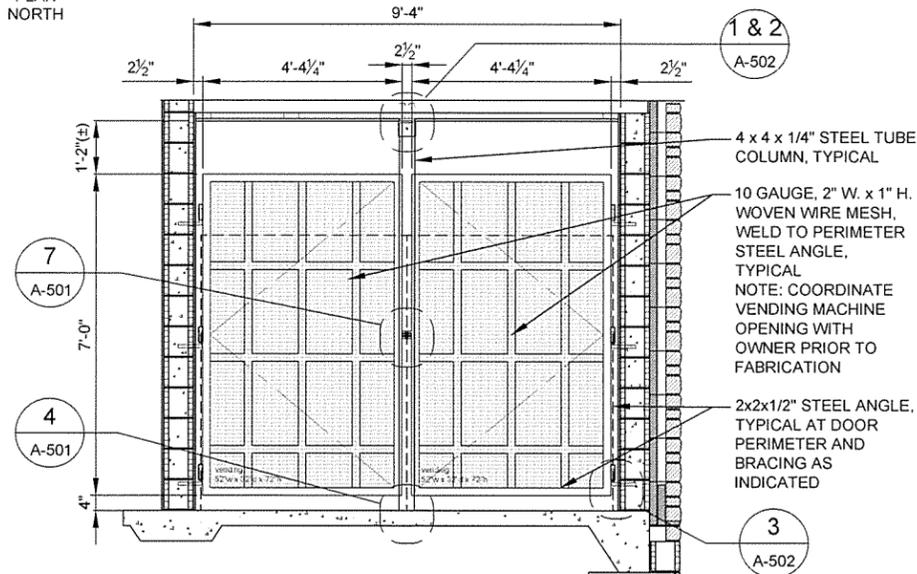


2 VENDING GATE ELEVATION
 A-501 SCALE: 1/2" = 1'-0"

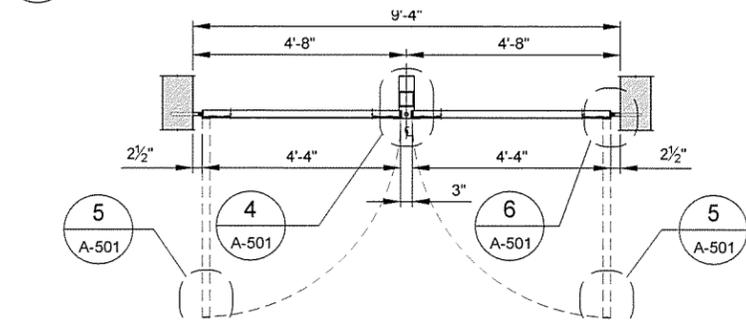


3 VENDING GATE PLAN
 A-501 SCALE: 1/2" = 1'-0"

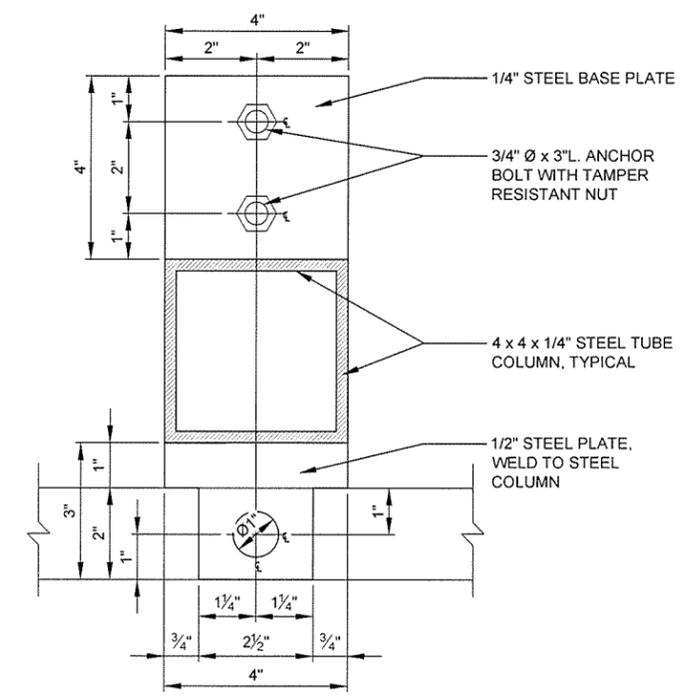


4 REMOVABLE JAMB
 A-501 SCALE: HALF SIZE

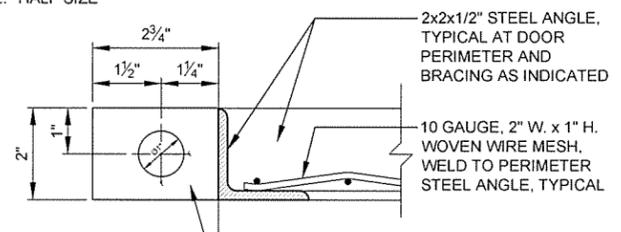


5 GATE JAMB/LOCK DETAIL
 A-501 SCALE: HALF SIZE

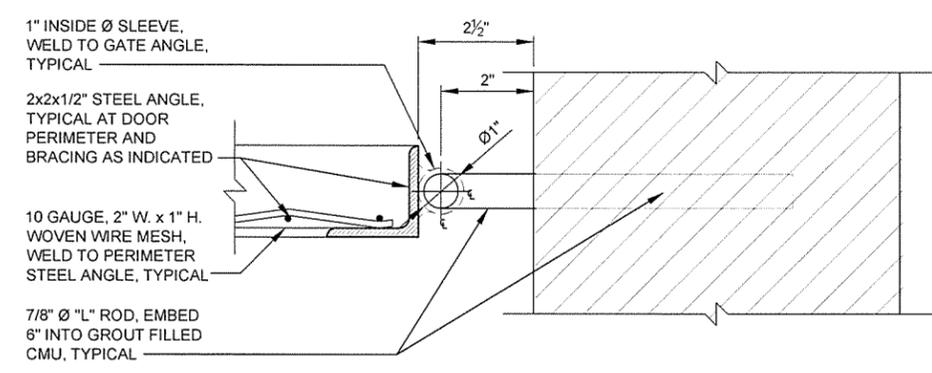

6 GATE PIVOT DETAIL
 A-501 SCALE: HALF SIZE

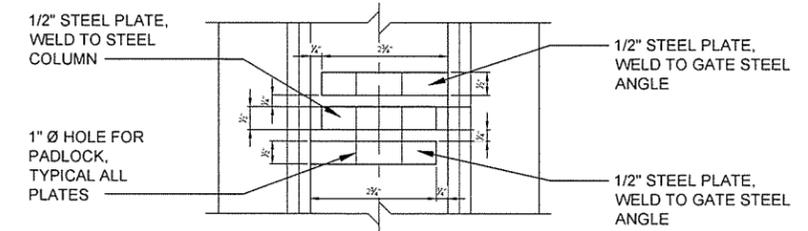


7 PADLOCK DETAIL
 A-501 SCALE: HALF SIZE

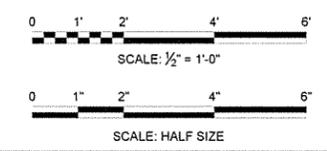


Job Number	009451	JRR	Appr.
Submitted by	John T. Watkins, III, PE SE Director, Federal Services	10/1/15	Date
Designed by	J. RAMSEY	10/1/15	Date
Drawn by	J. RAMSEY	10/1/15	Date
Checked by	G. ARCHER	10/1/15	Date
File Name	AHTBWR-A-501.DWG		
Job Name	ARKANSAS HIGHWAY AND TRANSPORTATION DEPARTMENT		
Job Location	ARKANSAS TOURIST INFORMATION CENTER (WHITE RIVER) (S) JOB 061451		
Job Description	ISSUED FOR CONSTRUCTION		
Job Status	ISSUED FOR CONSTRUCTION		

ARKANSAS HIGHWAY AND TRANSPORTATION DEPARTMENT
 ARKANSAS TOURIST INFORMATION CENTER
 (WHITE RIVER) (S)
 JOB 061451
 TOURIST INFORMATION CENTER
 DETAILS

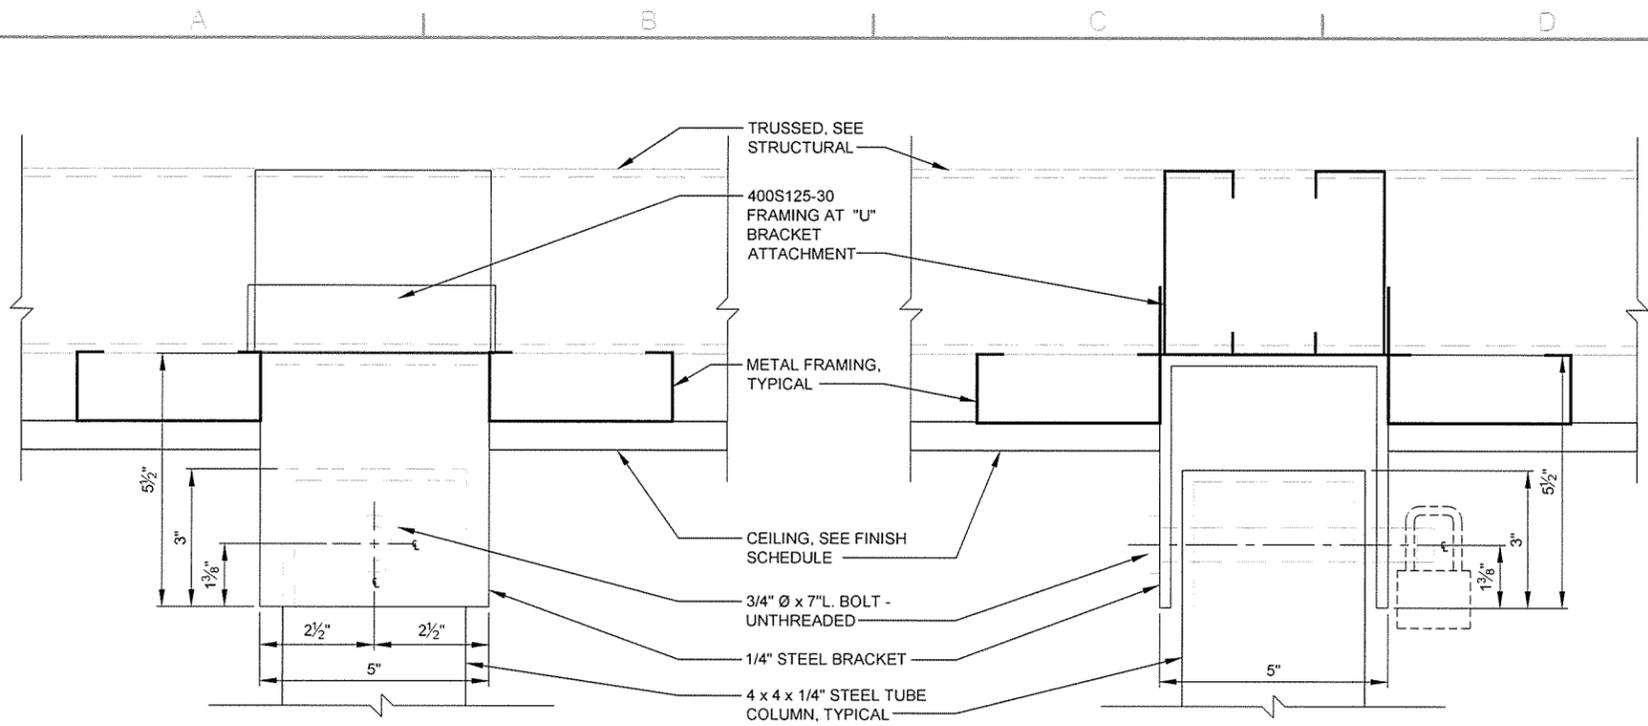

1 COLUMN HEAD DETAIL - FRONT
SCALE: HALF SIZE

2 COLUMN HEAD DETAIL - SIDE
SCALE: HALF SIZE

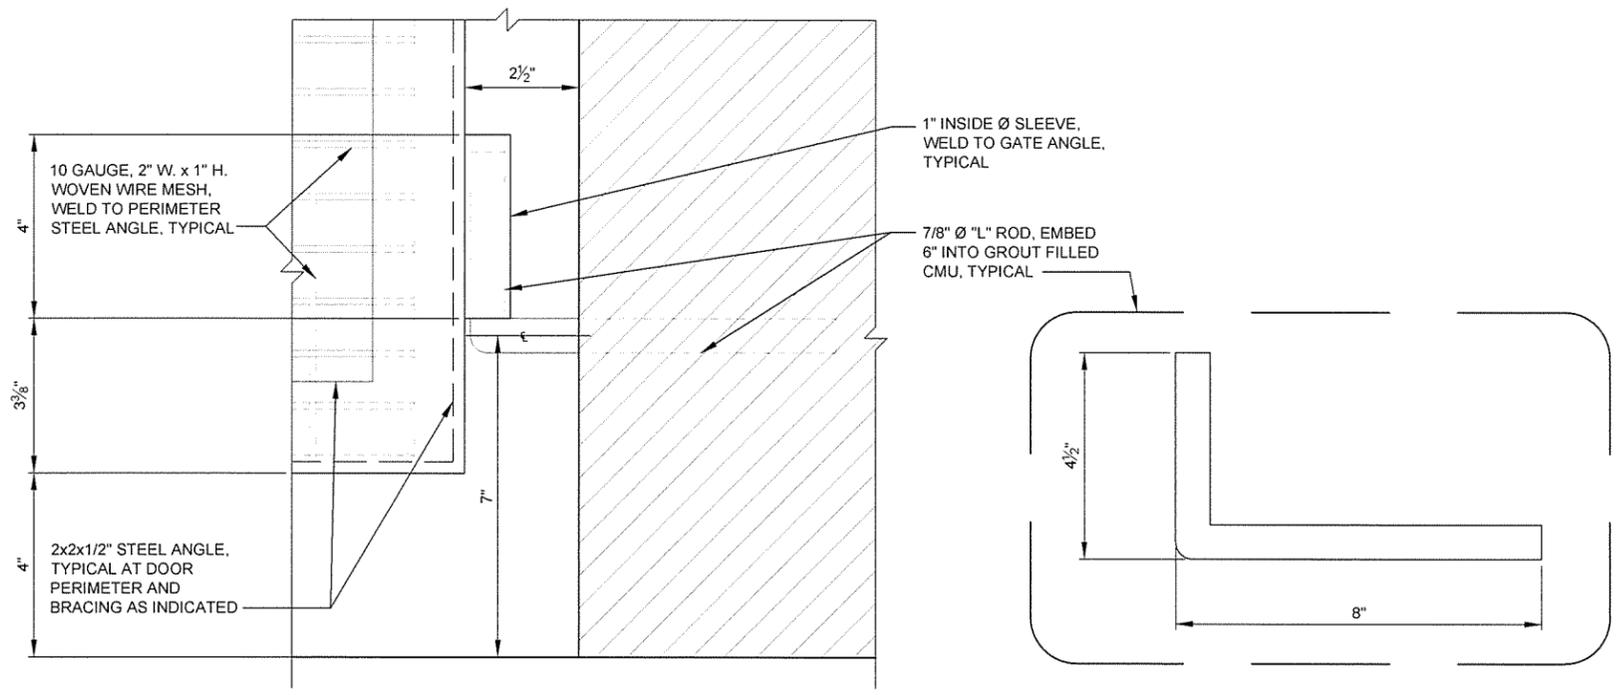

3 GATE PIVOT DETAIL
SCALE: HALF SIZE

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N Little Rock, AR 72118
501-376-3633
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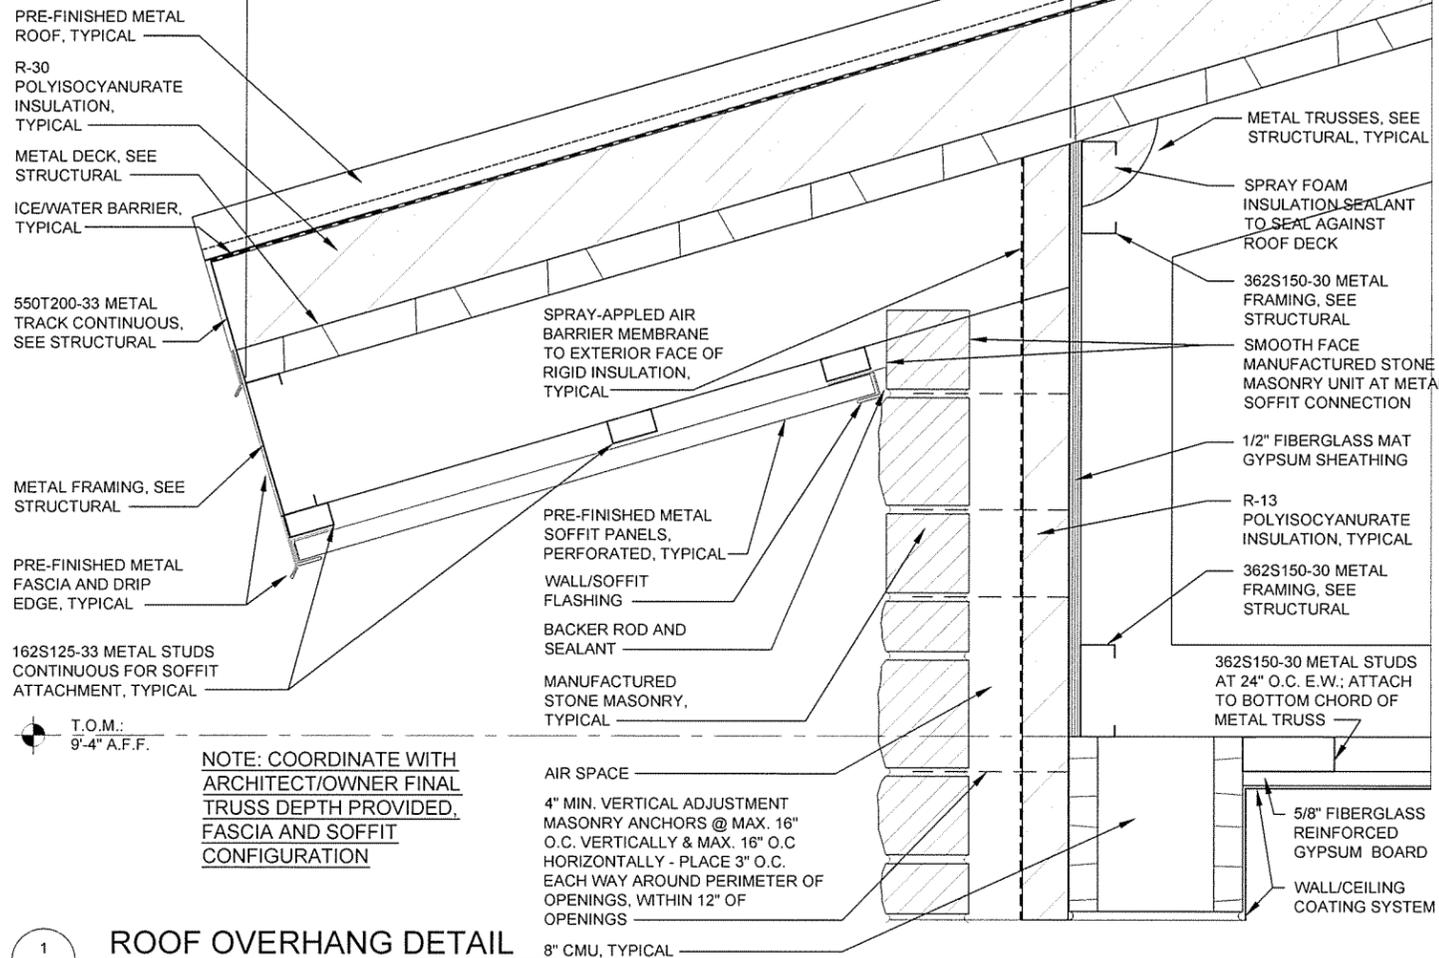
REGISTERED ARCHITECT
Garver, LLC
License No. LL1111
STATE OF ARKANSAS

REGISTERED ARCHITECT
Greg A. Archer
License No. 2671
STATE OF ARKANSAS


JRR	Appr.
10/1/15	Date
ISSUED FOR CONSTRUCTION	
IFC	Symbol

Designed by:	J. RAMSEY	Submitted by:	John T. Watkins, III, PE, SE Director, Federal Services	Job Number:	060451
Drawn by:	J. RAMSEY	Plot Date:	10/1/15	Play Scale:	N/A
Checked by:	G. ARCHER	Dwg Code:			N/A
File Name:	AH15WFA-502.DWG				N/A


ARKANSAS HIGHWAY AND TRANSPORTATION DEPARTMENT
ARKANSAS TOURIST INFORMATION CENTER
(WHITE RIVER) (S)
JOB 061451
TOURIST INFORMATION CENTER
DETAILS



1 ROOF OVERHANG DETAIL
 SCALE: 3" = 1'-0"

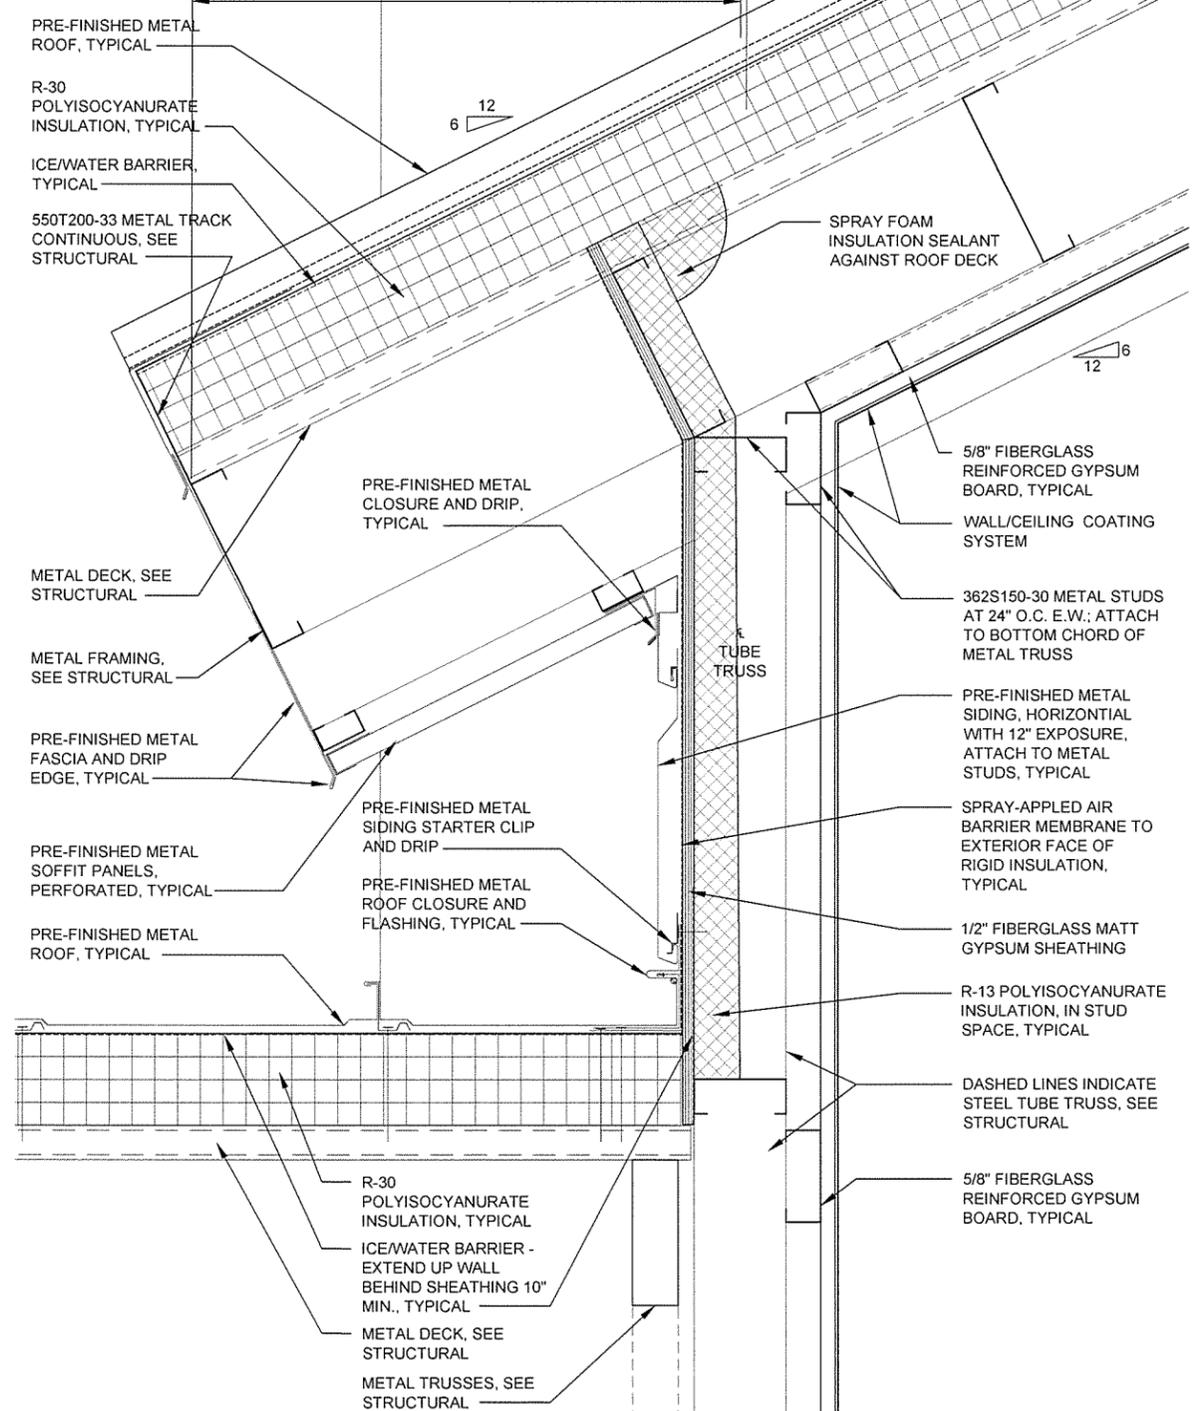

2 DORMER OVERHANG DETAIL
 SCALE: 3" = 1'-0"

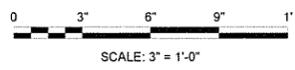


JRR	Apr
Date	
10/11/15	
ISSUED FOR CONSTRUCTION	Description
IFC	Symbol


Job Number	000451	N/A	N/A	N/A
Submitted by	John T. Watkins, III, P.E. SE	Director, Federal Services	Plot Scale	1:1
Designed by	J. RAMSEY	Drawn by	J. RAMSEY	Checked by
Date	10/11/15	Divg Code		
File Name	AHTSWR-A-503.DWG			

ARKANSAS HIGHWAY AND TRANSPORTATION DEPARTMENT
 ARKANSAS TOURIST INFORMATION CENTER
 (WHITE RIVER) (S)
 JOB 081451


TOURIST INFORMATION CENTER
 DETAILS

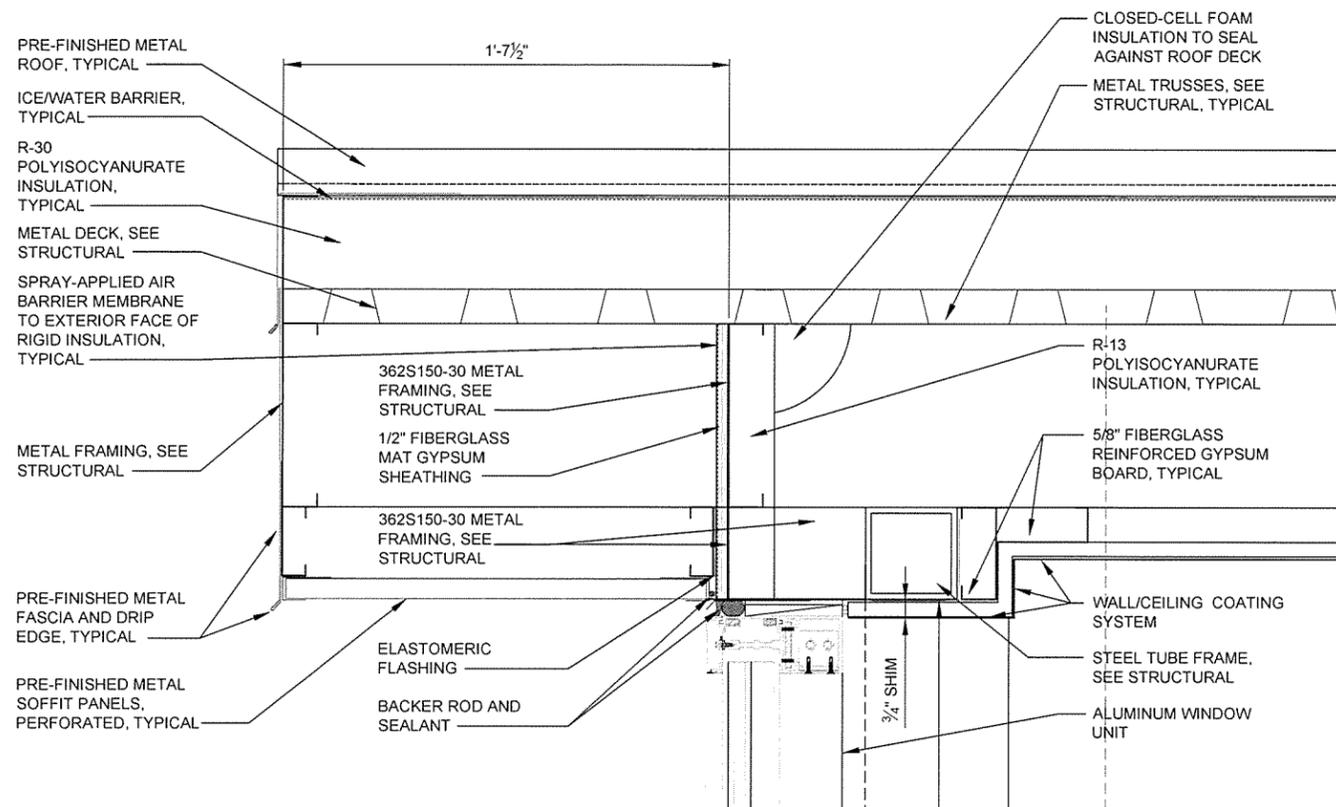


1 DORMER OVERHANG
A-504 SCALE: 3" = 1'-0"

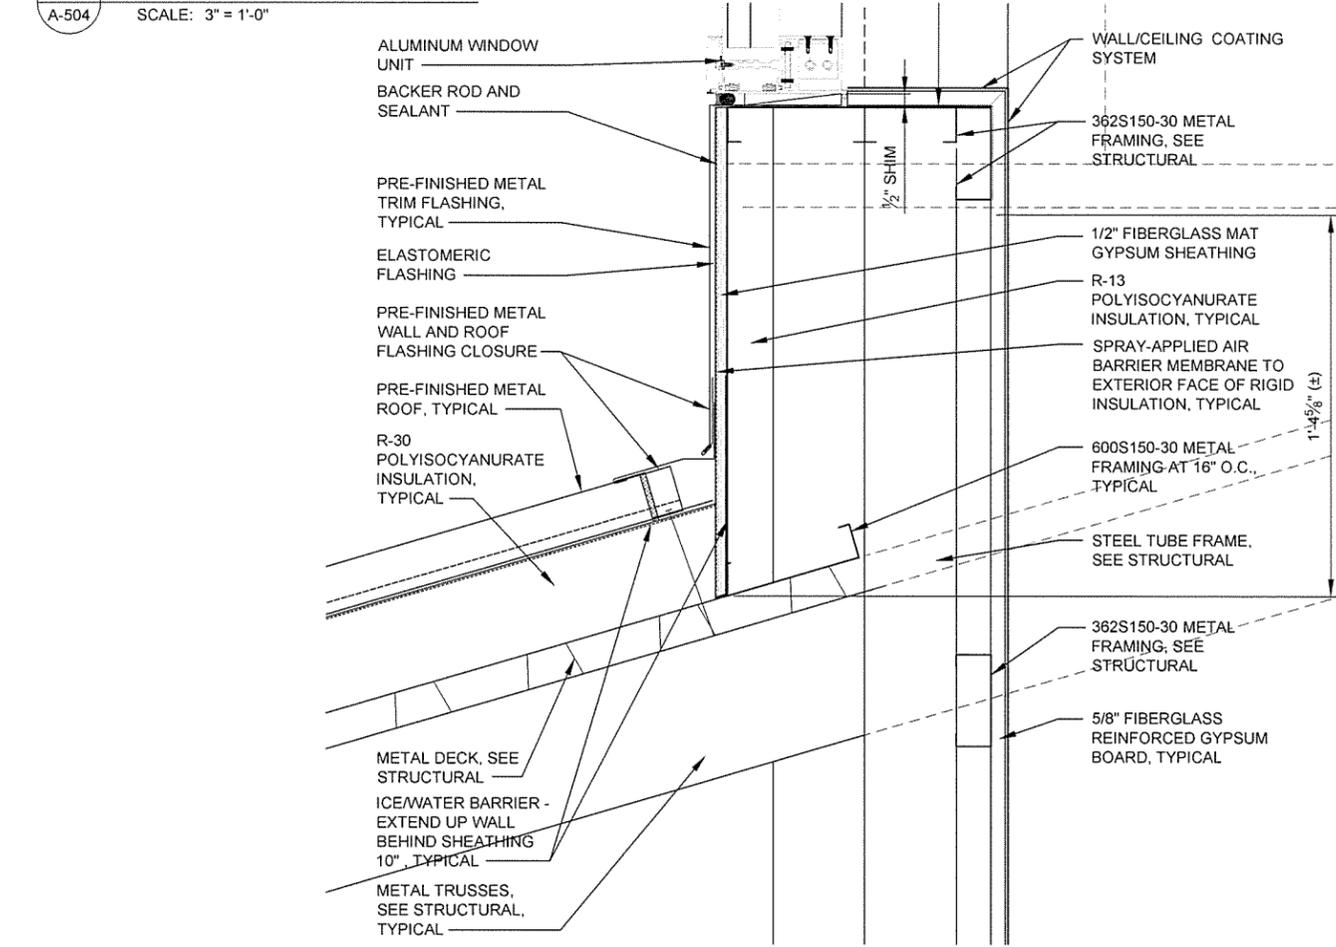


2 DORMER ROOF
A-504 SCALE: 3" = 1'-0"

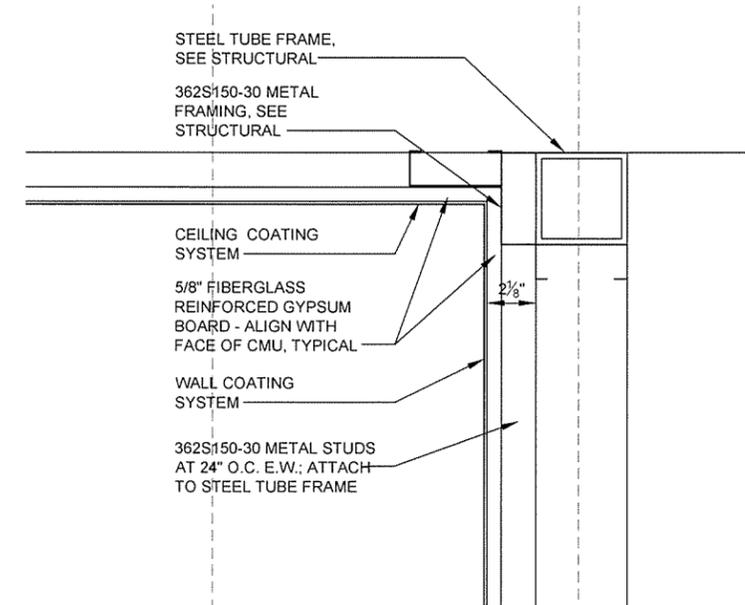

3 CEILING/WALL DETAIL
A-504 SCALE: 3" = 1'-0"

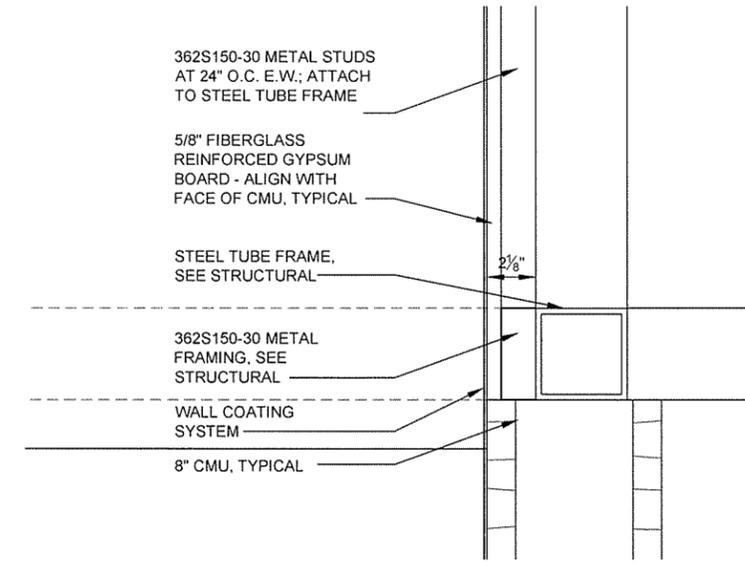

4 WALL/METAL FRAMING DETAIL
A-504 SCALE: 3" = 1'-0"

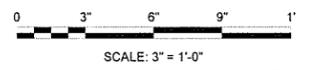


JRR
Appr
10/1/15
Date

ISSUED FOR CONSTRUCTION
Description
IPC
Symbol


Job Number	099451	N/A	N/A	N/A
Submitted by	John T. Watkins, III, PE, SE Director, Federal Services	Plot Scale	1:1	
Designed by	J. RAMSEY	Plot Date	10/1/15	Divg Code
Drawn by	J. RAMSEY	Checked by	G. ARCHER	File Name
				AH504R-A-504.DWG

ARKANSAS HIGHWAY AND TRANSPORTATION DEPARTMENT
ARKANSAS TOURIST INFORMATION CENTER
(WHITE RIVER) (S)
JOB 081451
TOURIST INFORMATION CENTER
DETAILS


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A-504
Sheet 69 of 130

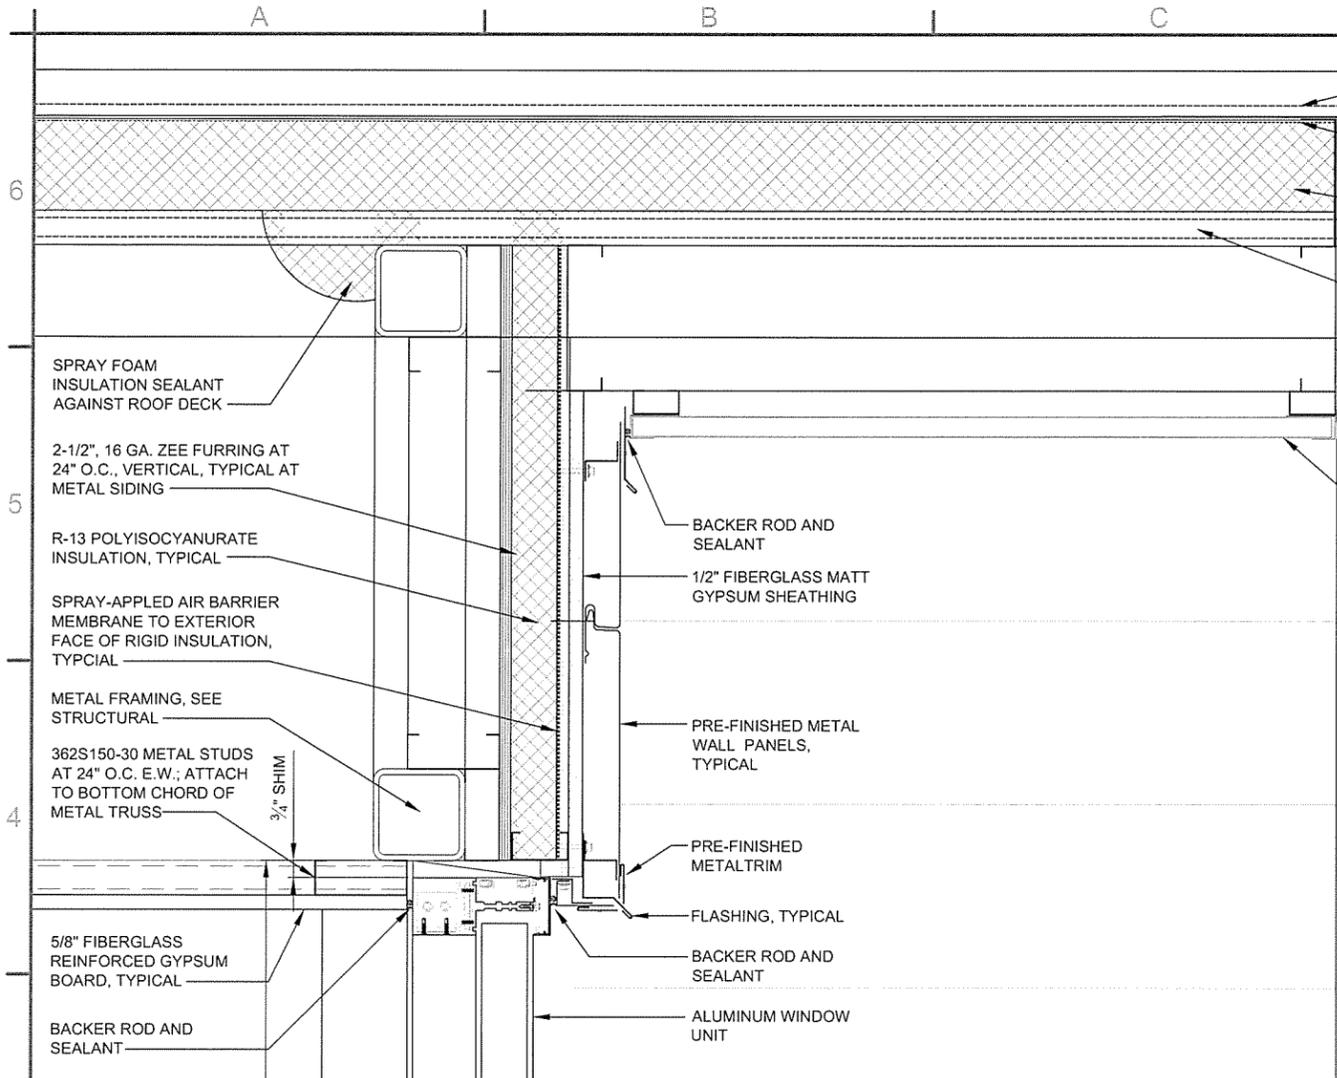


1 WINDOW HEAD ROOF DETAIL
A-505 SCALE: 3" = 1'-0"

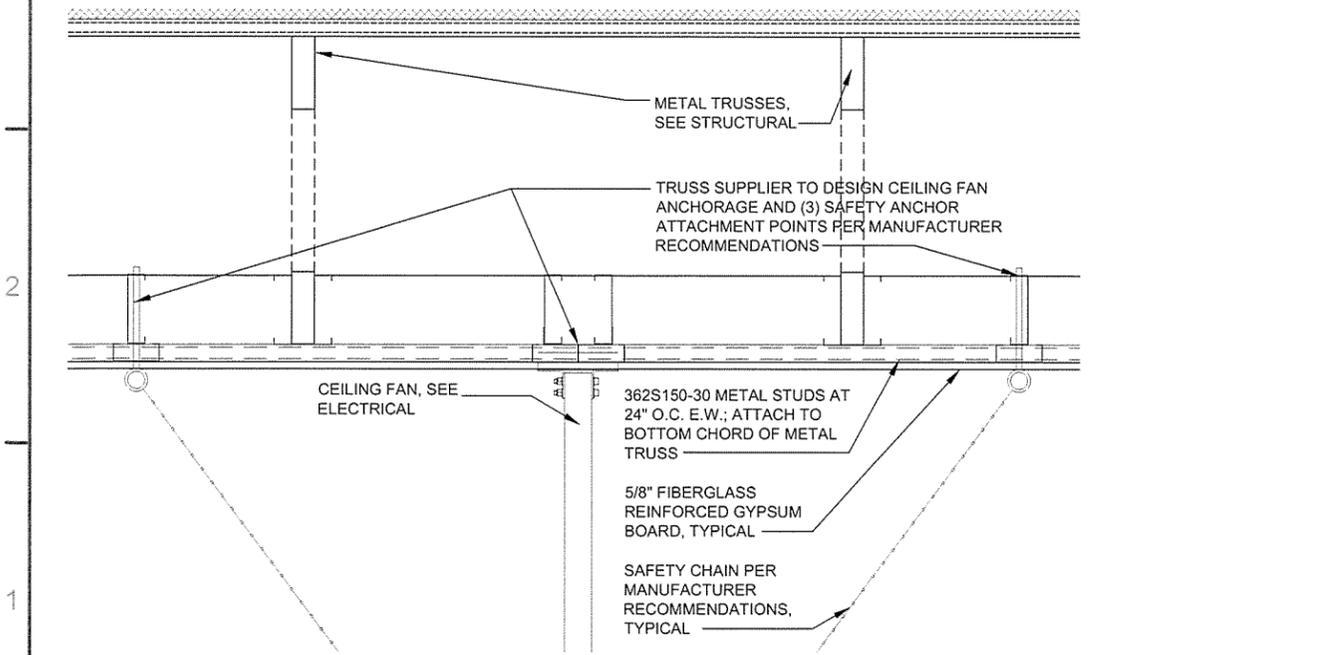


4 CEILING FAN DETAIL
A-505 SCALE: 1 1/2" = 1'-0"

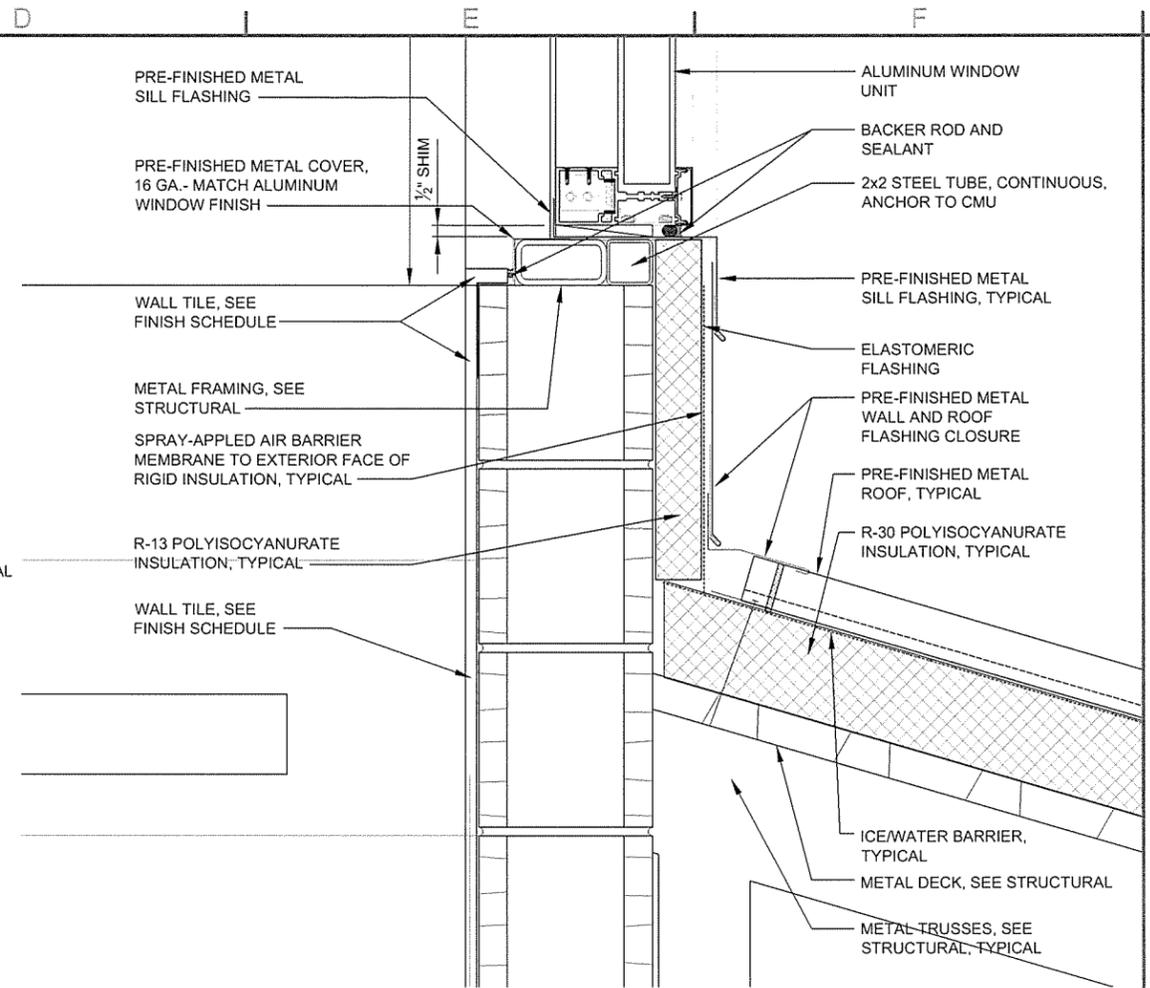

2 WINDOW SILL ROOF DETAIL
A-505 SCALE: 3" = 1'-0"

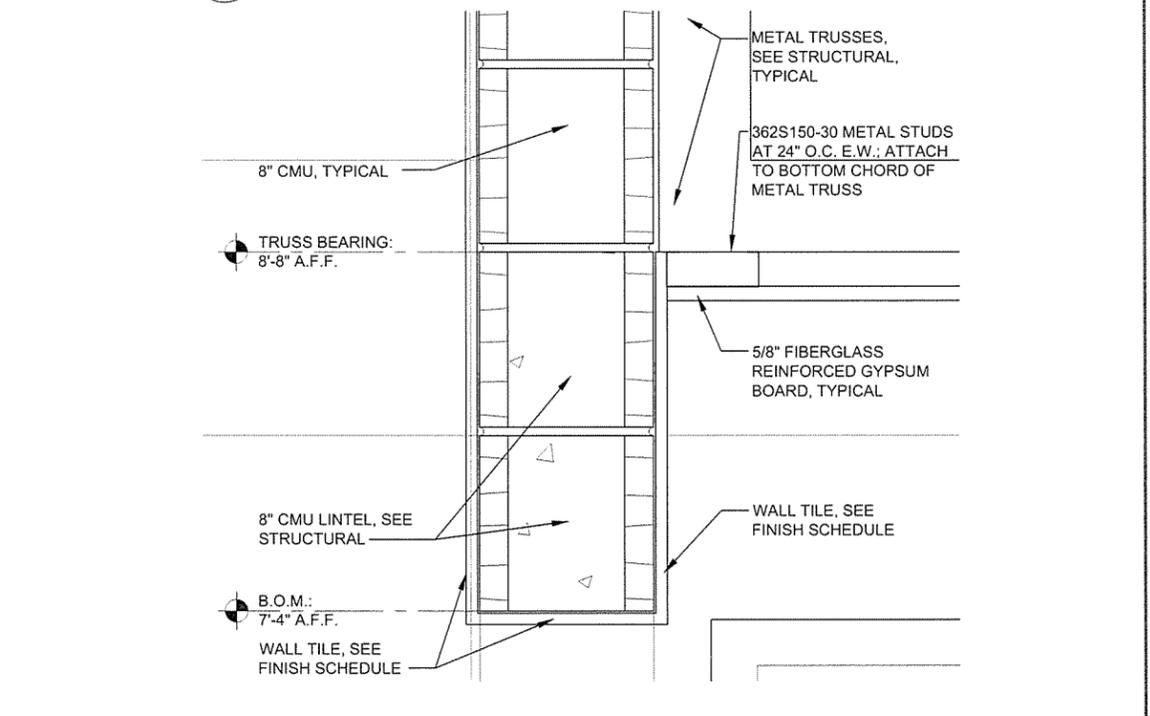

3 VENDING OPENING DETAIL
A-505 SCALE: 3" = 1'-0"

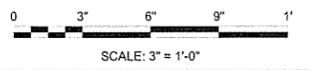


JRR	Appr.
10/17/15	Date
ISSUED FOR CONSTRUCTION	Description
IFC	Symbol

Job Number 000451	N/A	N/A	N/A
Submitted by John T. Watkins, III, P.E. SE Director, Federal Services	Plot Scale 1:1	Drwg Code	File Name AHSWR-A-505.DWG
Designed by J. RAMSEY	Drawn by J. RAMSEY	Checked by G. ARCHER	

ARKANSAS HIGHWAY AND TRANSPORTATION DEPARTMENT
ARKANSAS TOURIST INFORMATION CENTER
(WHITE RIVER) (S)
JOB 081451


TOURIST INFORMATION CENTER
DETAILS

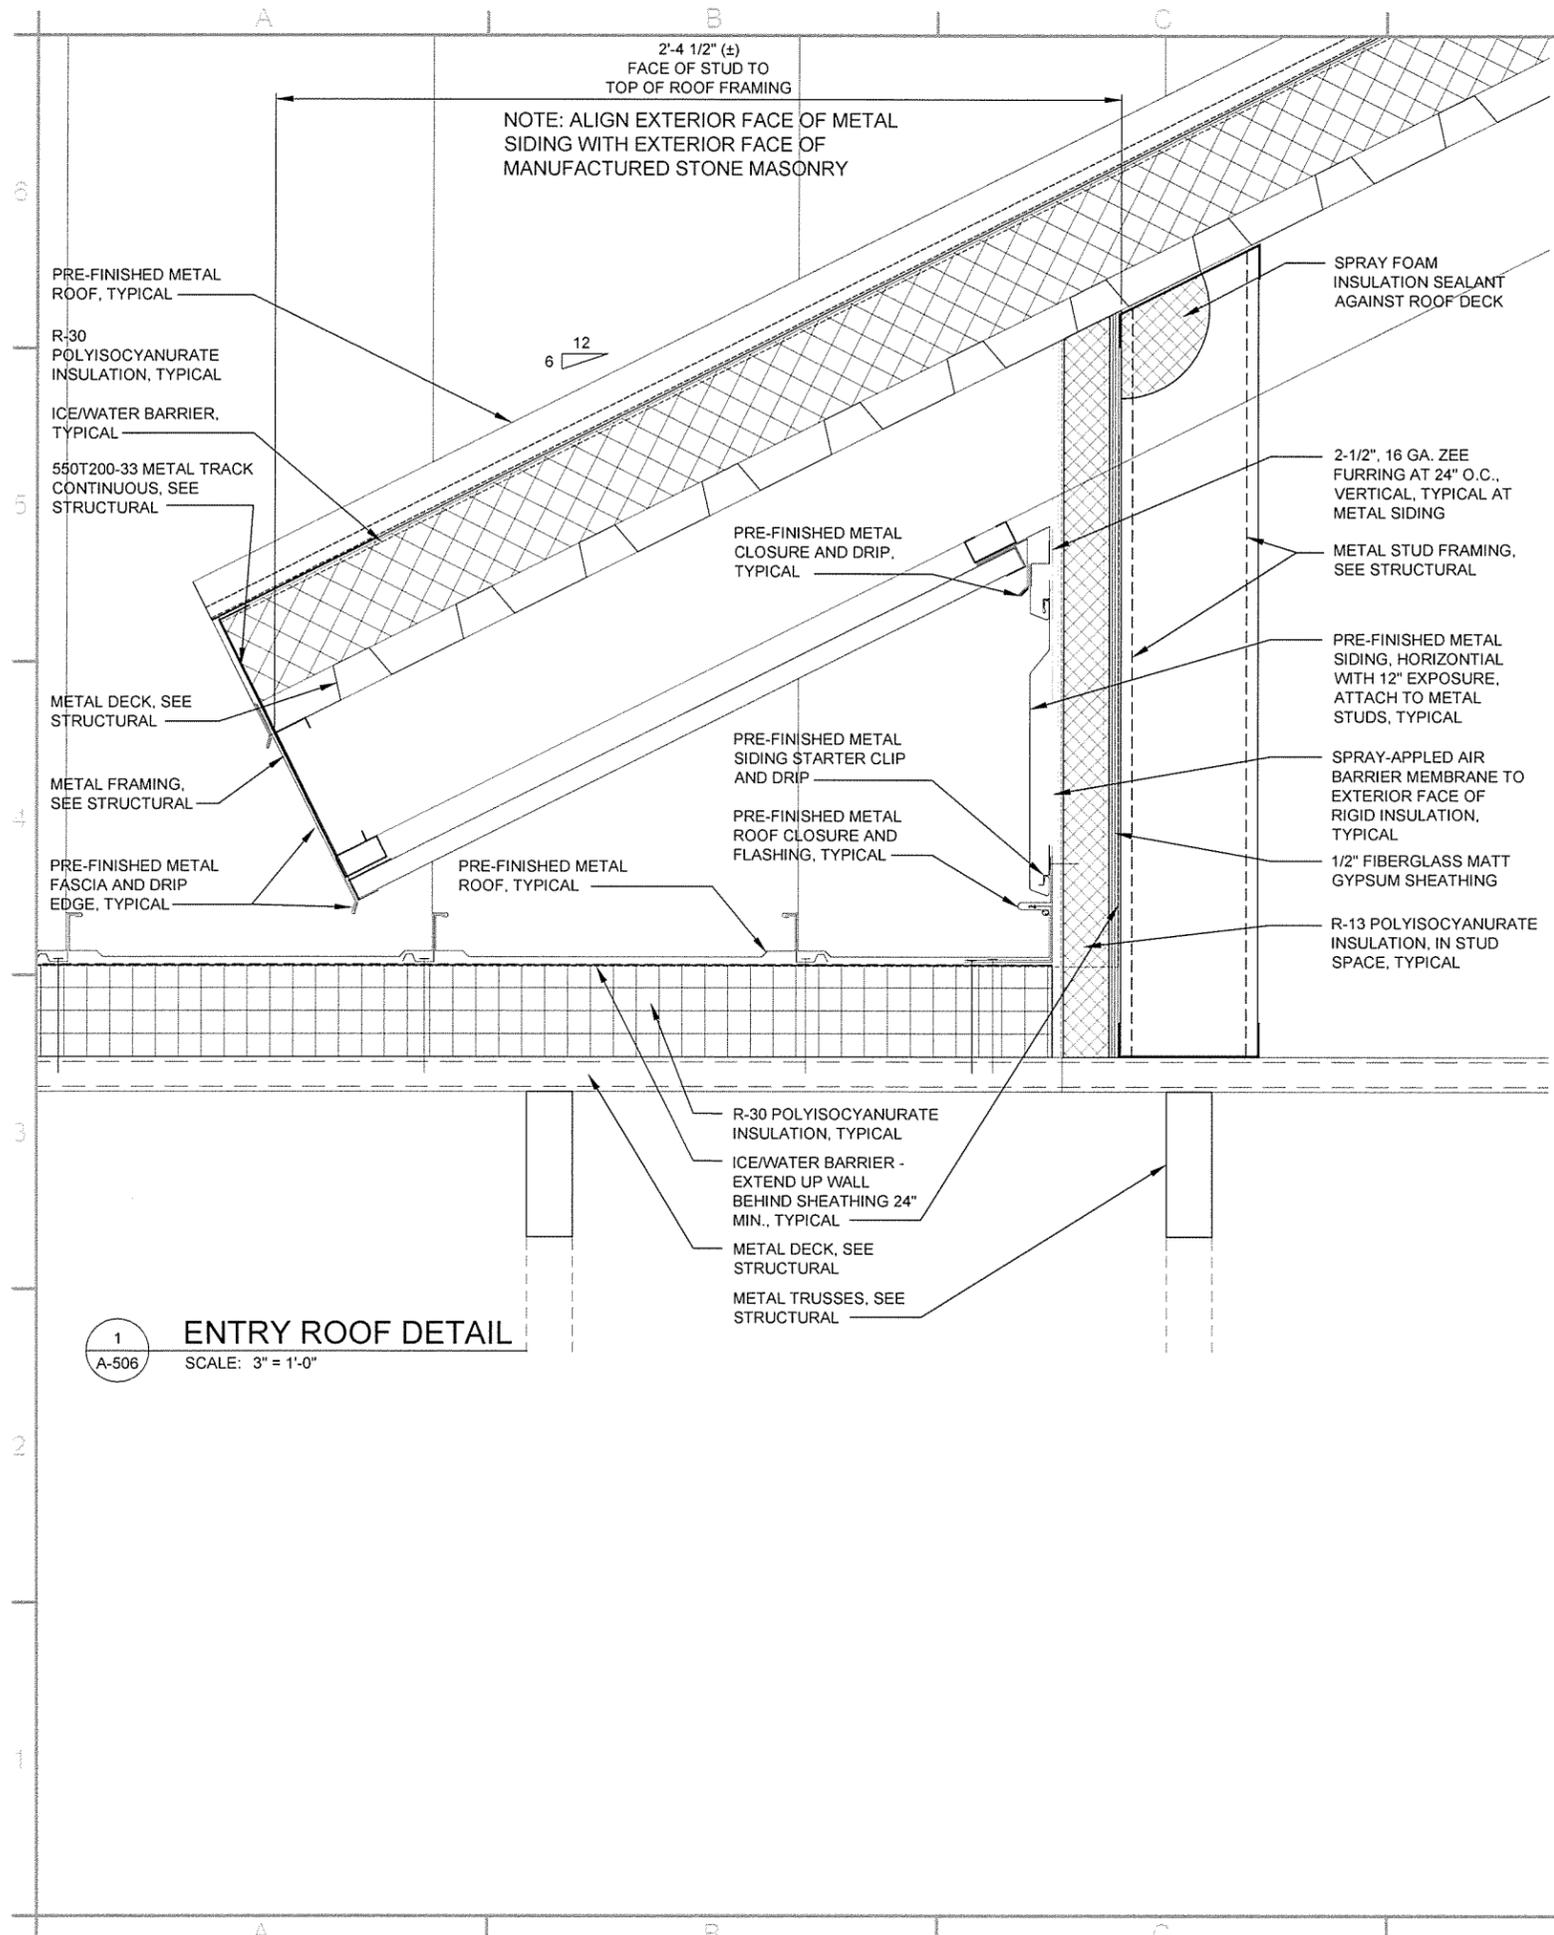

NOTE: ALIGN EXTERIOR FACE OF METAL SIDING WITH EXTERIOR FACE OF MANUFACTURED STONE MASONRY

12
6


1
A-506
ENTRY ROOF DETAIL
SCALE: 3" = 1'-0"

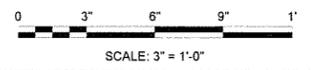

ISSUED FOR CONSTRUCTION	JRR	Appr.
Date	10/1/15	
IFC Symbol		

Job Number	080451
Submitted by	John T. Walkers, III, PE SE Director, Federal Services
Plot Scale	N/A
Plot Date	10/1/15
Plot Scale	1:1
Drawn by	J. RAMSEY
Checked by	G. ARCHER
File Name	AH15WR-A-506.DWG

ARKANSAS HIGHWAY AND TRANSPORTATION DEPARTMENT
 ARKANSAS TOURIST INFORMATION CENTER
 (WHITE RIVER) (S)
 JOB 061451
 TOURIST INFORMATION CENTER
 DETAILS

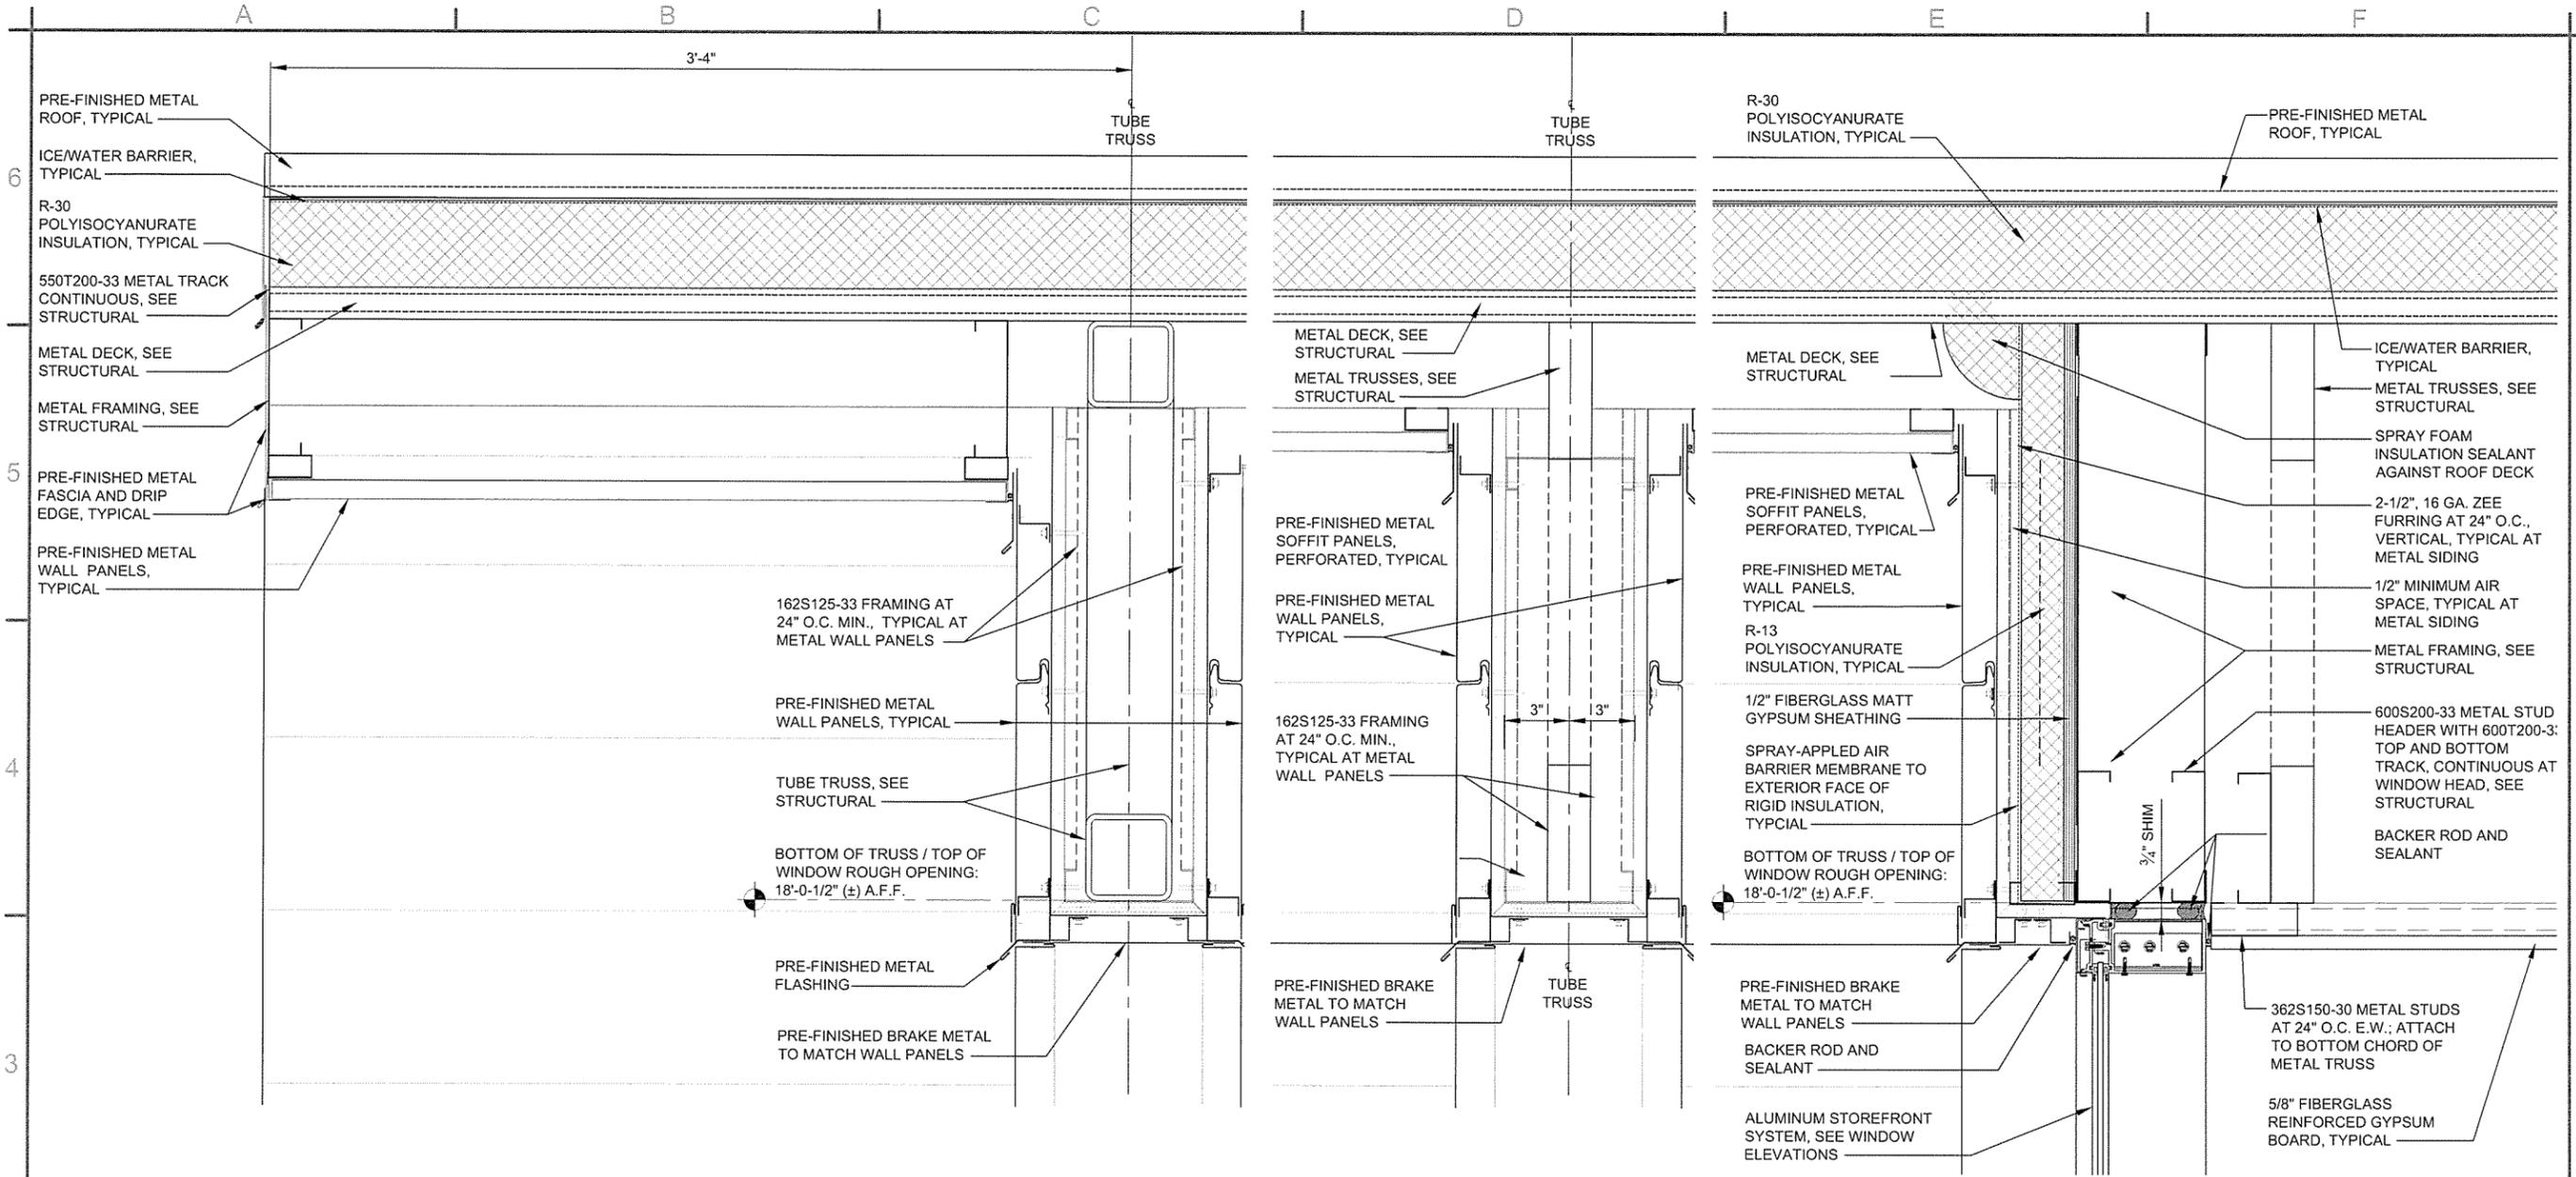



JRR	Appr.
10/1/15	Date
ISSUED FOR CONSTRUCTION	Description
PC	Symbol

Submitted by John T. Watkins, III, PE, SE Director, Technical Services	Job Number 069451	N/A	N/A	N/A
Designed by J. RAMSEY	Plot Date 10/2/15	Plot Scale 1:1	Draw Code	File Name A15WRA-A-507.DWG
Drawn by J. RAMSEY	Checked by G. ARCHER			


ARKANSAS HIGHWAY AND TRANSPORTATION DEPARTMENT
 ARKANSAS TOURIST INFORMATION CENTER
 (WHITE RIVER) (S)
 JOB 081451

TOURIST INFORMATION CENTER
 DETAILS

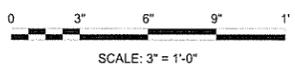


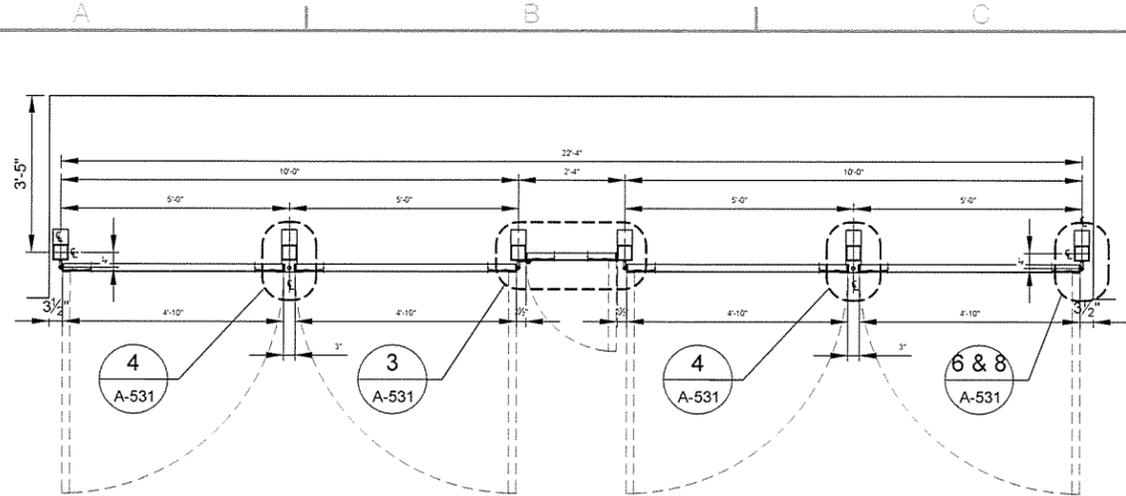


1 ENLARGED FLOOR PLAN - VENDING AREA
 A-531 SCALE: 1/2" = 1'-0"

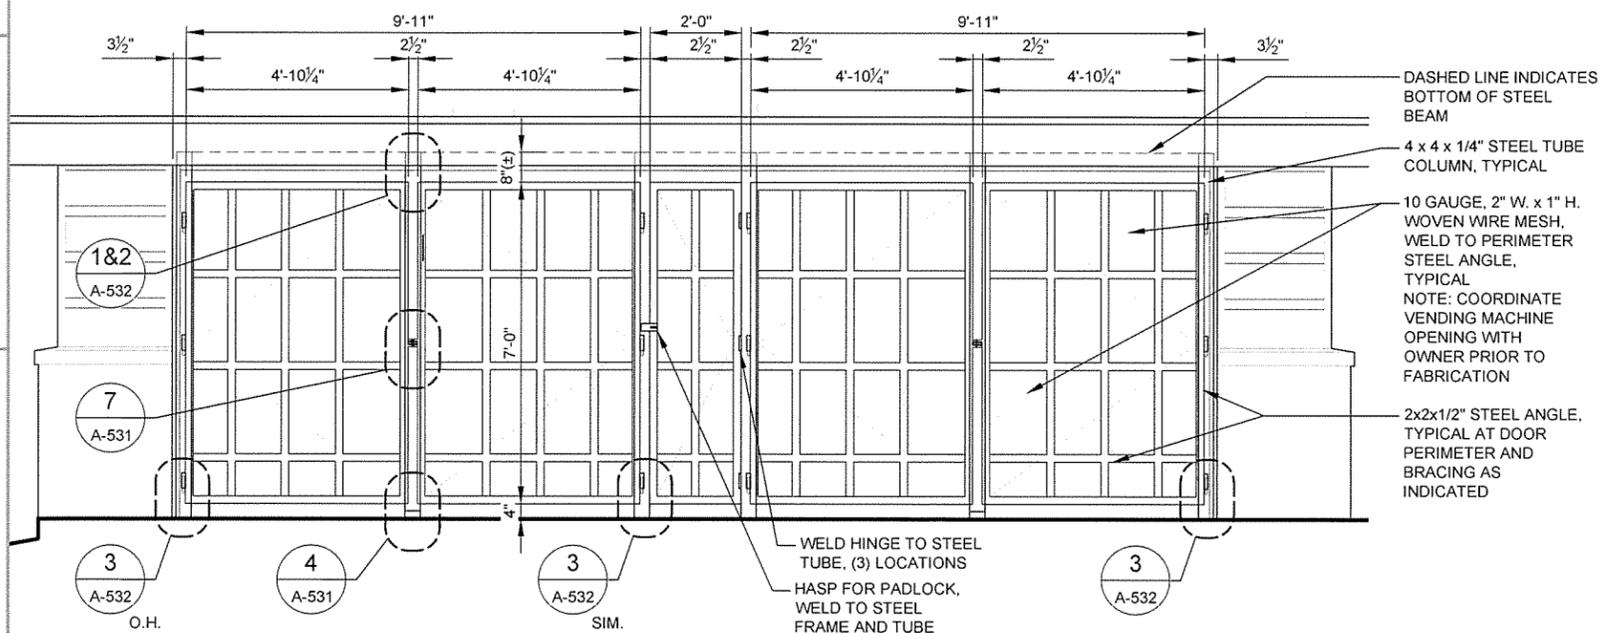


2 VENDING GATE ELEVATION
 A-531 SCALE: 1/2" = 1'-0"

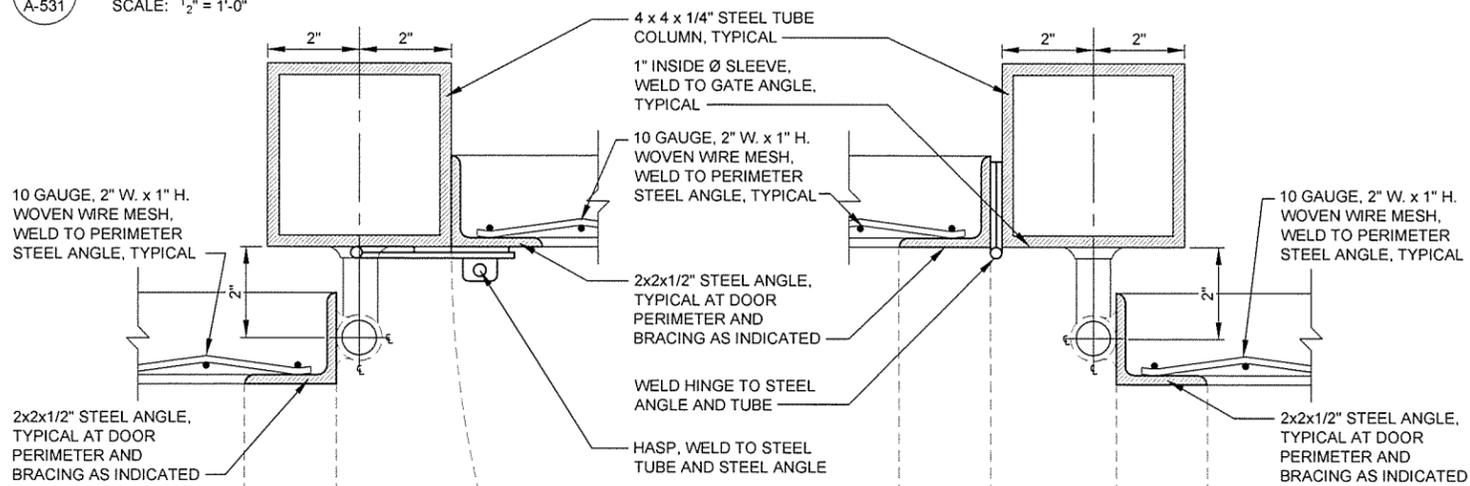


3 VENDING DOOR JAMBS
 A-531 SCALE: HALF SIZE

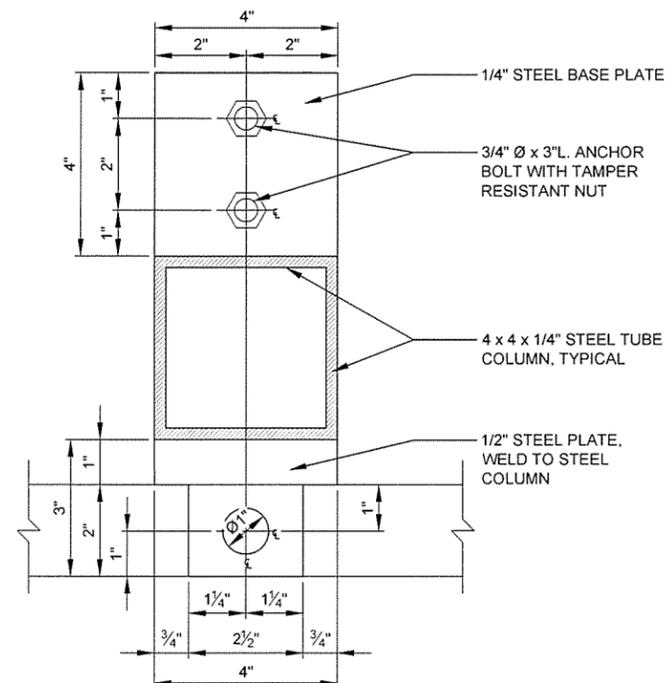

4 REMOVABLE JAMB
 A-531 SCALE: HALF SIZE

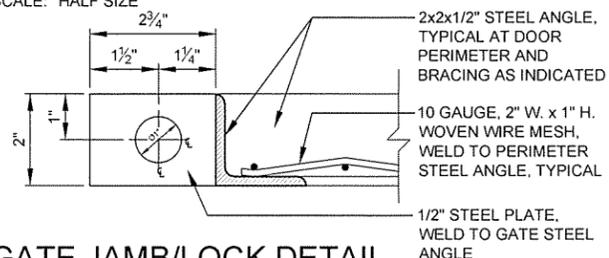


5 GATE JAMB/LOCK DETAIL
 A-531 SCALE: HALF SIZE

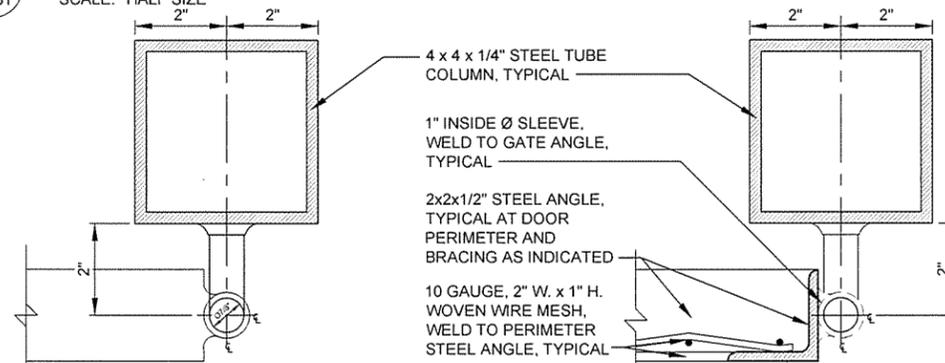


6 GATE PIVOT ARM DETAIL
 A-531 SCALE: HALF SIZE

8 GATE PIVOT DETAIL
 A-531 SCALE: HALF SIZE

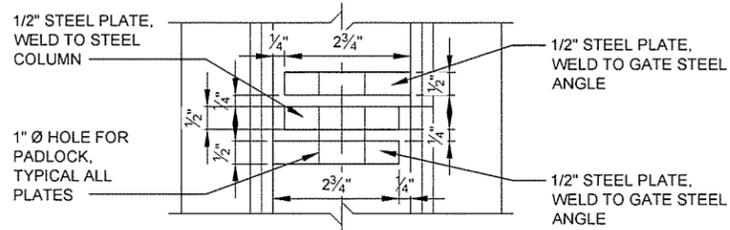


7 PADLOCK DETAIL
 A-531 SCALE: HALF SIZE

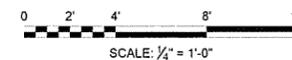



Job Number	069-51	JRR
Submitted by	John T. Watkins, III, PE, SE	Appr.
Director, Federal Services		Date
Plot Date	10/1/15	10/1/15
Plot Scale	1:1	
Drng Code		
Checked by	G. ARCHER	
File Name	AHSWR-A-531.DWG	
Job Number	069-51	
Submitted by	John T. Watkins, III, PE, SE	
Director, Federal Services		
Plot Date	10/1/15	
Plot Scale	1:1	
Drng Code		
Checked by	G. ARCHER	
File Name	AHSWR-A-531.DWG	

ARKANSAS HIGHWAY AND TRANSPORTATION DEPARTMENT
 ARKANSAS TOURIST INFORMATION CENTER
 (WHITE RIVER) (S)
 JOB 061451
 TRUCKER-VENDING BUILDING
 DETAILS

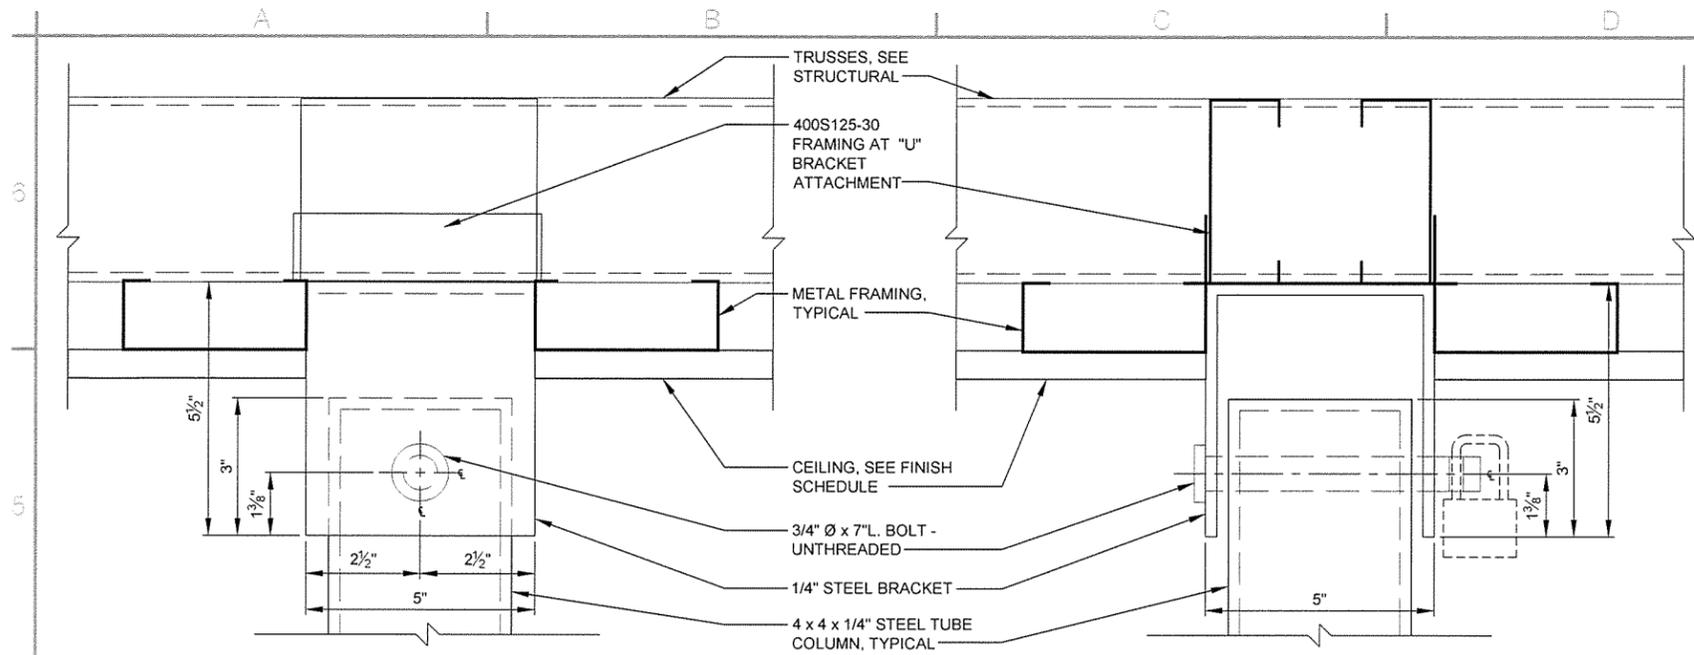


1 COLUMN HEAD DETAIL-FRONT
A-532 SCALE: HALF SIZE

2 COLUMN HEAD DETAIL-SIDE
A-532 SCALE: HALF SIZE

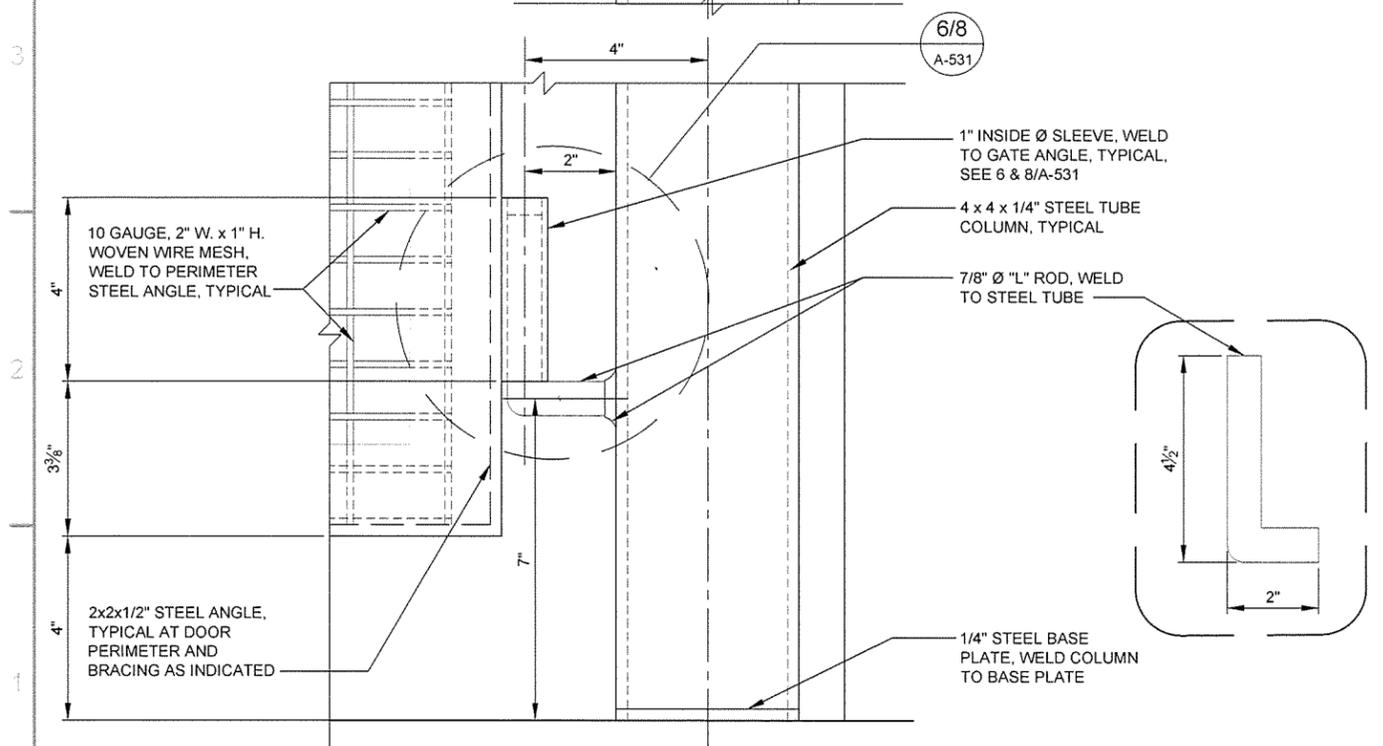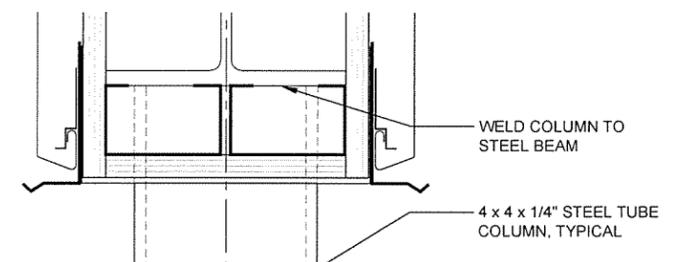

3 COLUMN BASE/HEAD DETAIL
A-532 SCALE: HALF SIZE

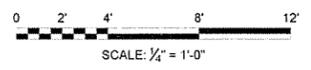


JRR	Appr.
10/1/15	Date
ISSUED FOR CONSTRUCTION	Description
JPC	Symbol


Job Number	000451
Submitted by	John T. Watkins, III, PE, SE Director, Federal Services
Plot Date	10/1/15
Plot Scale	1:1
Dwg. Code	
Designed by	J. RAMSEY
Drawn by	J. DEMARNE
Checked by	G. ARCHER
File Name	AH5MVA-A-532.DWG

ARKANSAS HIGHWAY AND TRANSPORTATION DEPARTMENT
ARKANSAS TOURIST INFORMATION CENTER
(WHITE RIVER) (S)
JOB 061451


TRUCKER-VENDING BUILDING
DETAILS

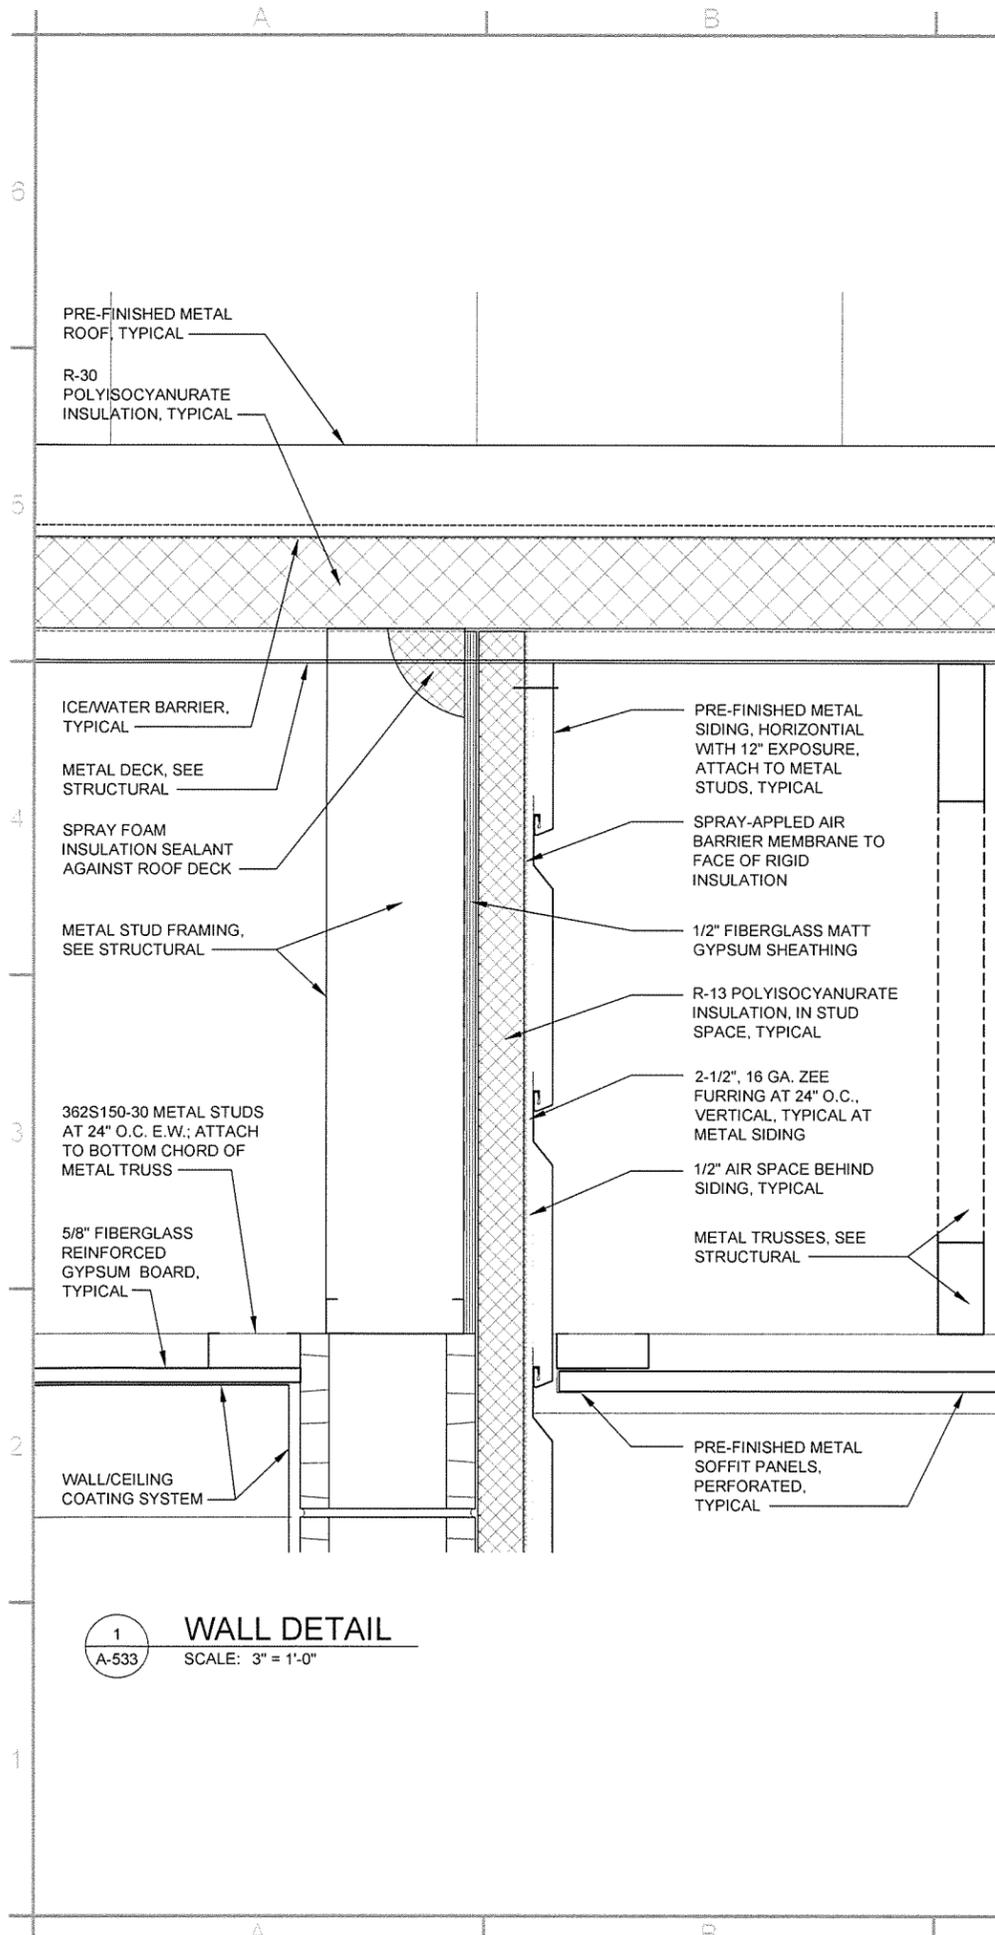


1 WALL DETAIL
A-533 SCALE: 3" = 1'-0"

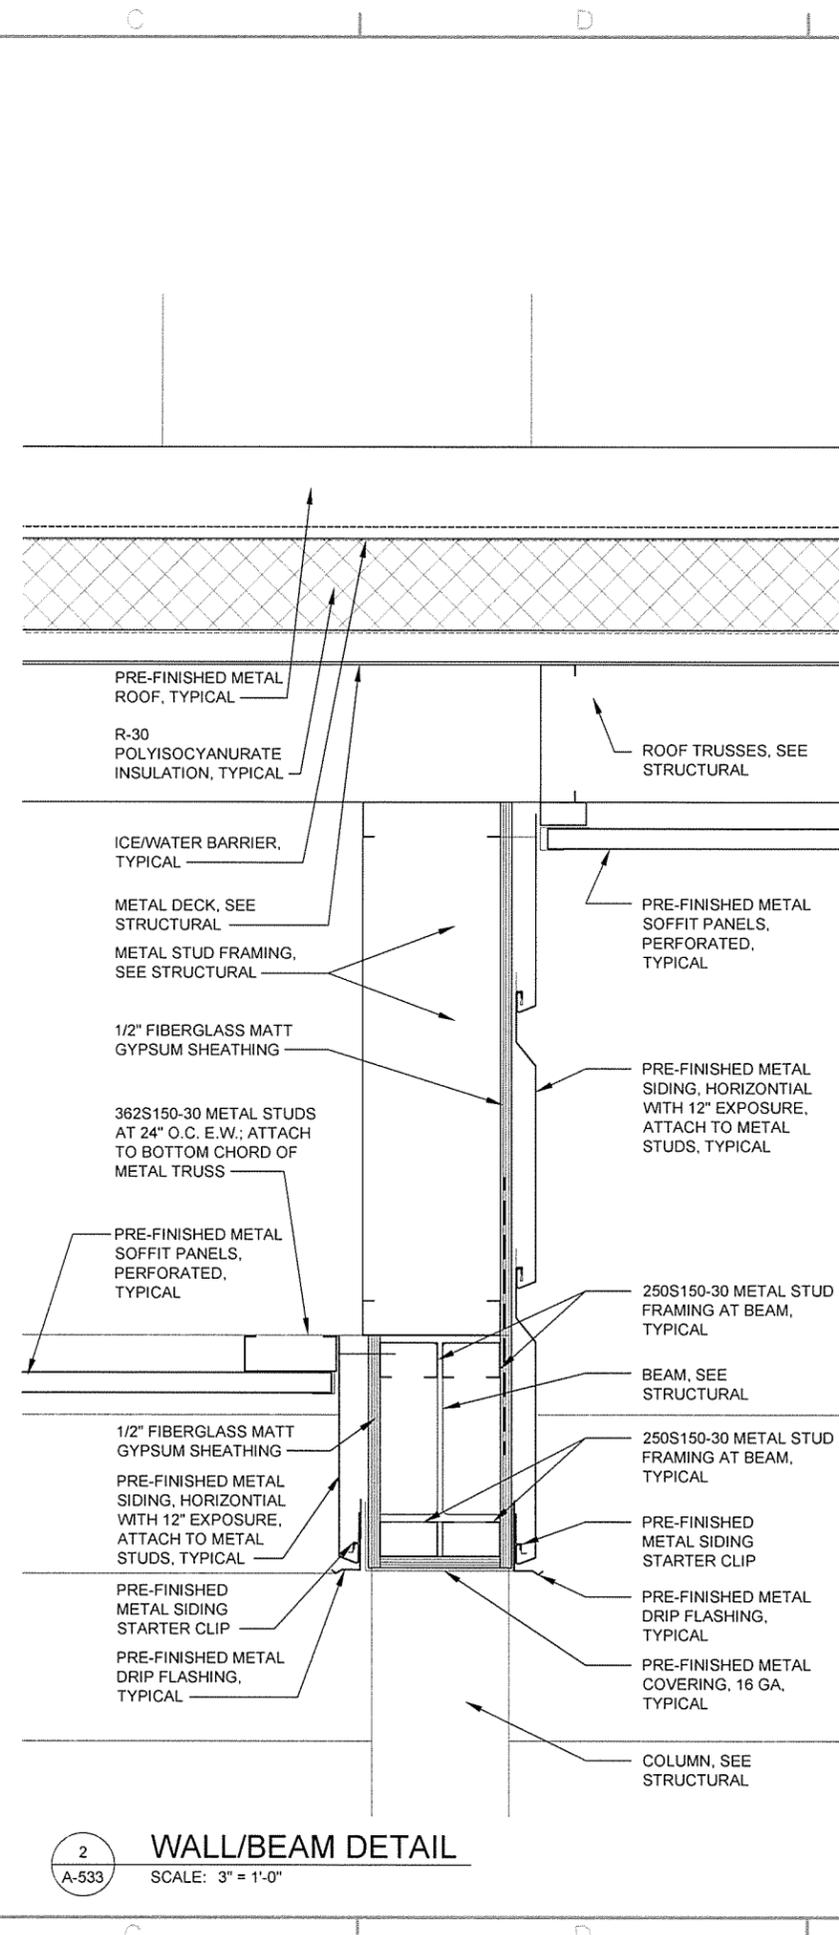

2 WALL/B EAM DETAIL
A-533 SCALE: 3" = 1'-0"

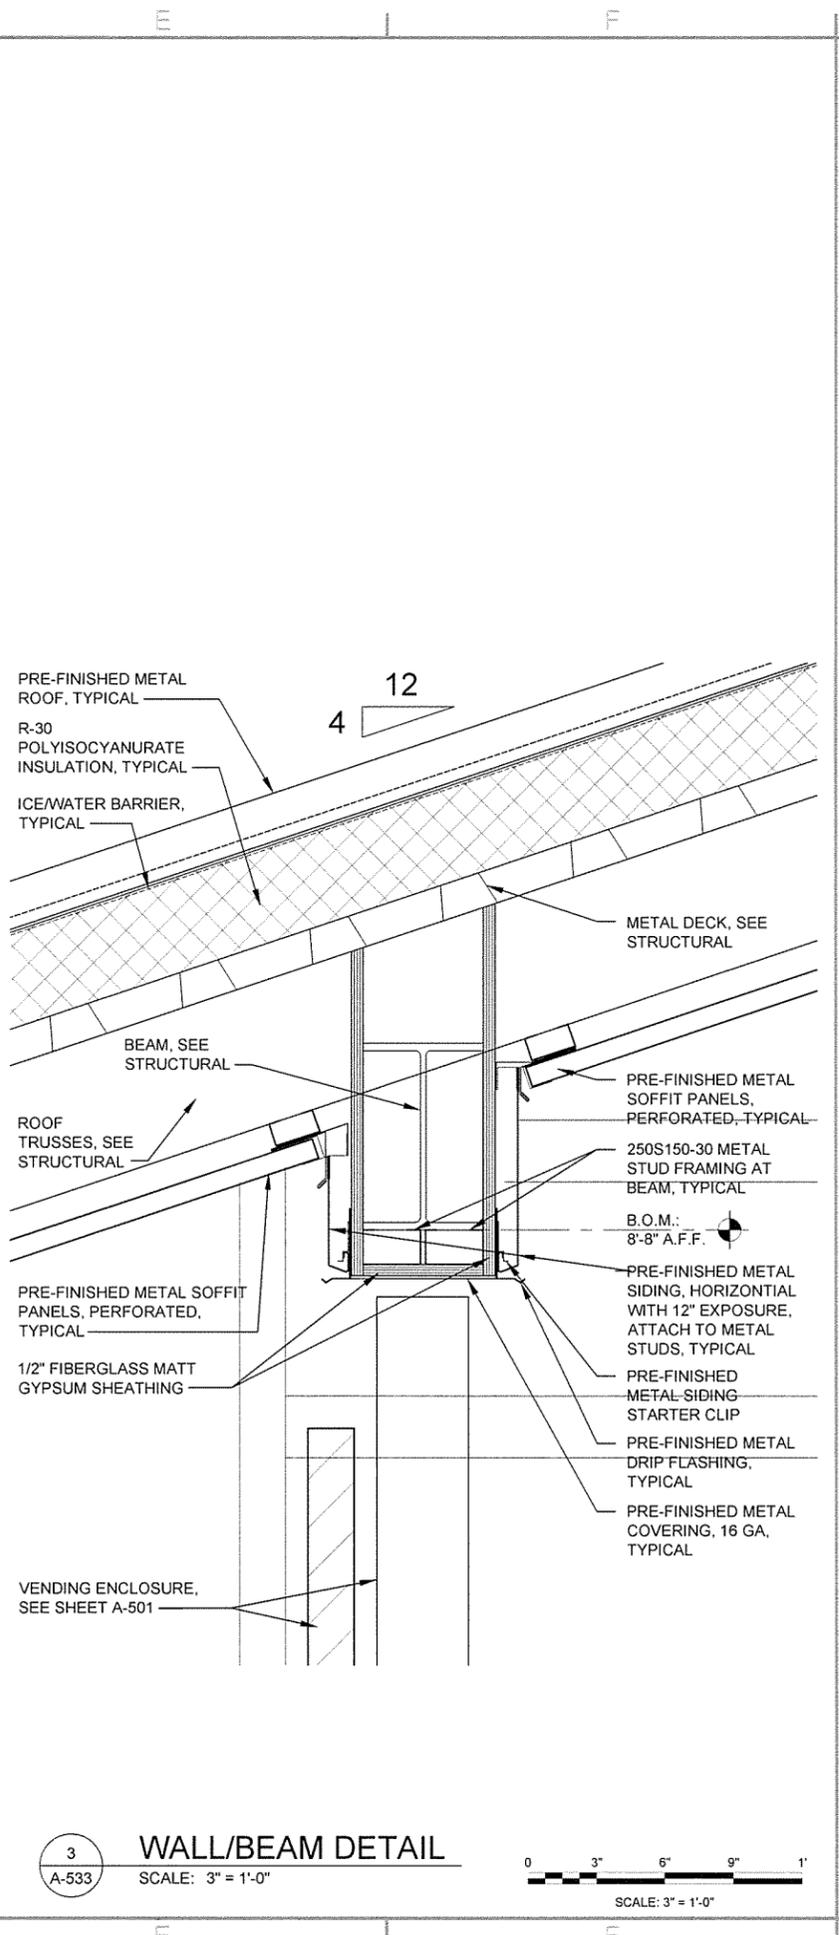

3 WALL/B EAM DETAIL
A-533 SCALE: 3" = 1'-0"

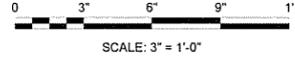

JRR	Appr.
10/1/15	Date
ISSUED FOR CONSTRUCTION	Description
PEC	Symbol

Job Number	000451	N/A	N/A	N/A
Submitted by	John T. Watkins, III, PE, SE Director, Federal Services	Plot Scale	1:1	Divg Code
Designed by	J. RAMSEY	Drawn by	J. DEMAINE	Checked by
				G. ARCHER
File Name:	AHSVR-A-533.DWG			

ARKANSAS HIGHWAY AND TRANSPORTATION DEPARTMENT
ARKANSAS TOURIST INFORMATION CENTER
(WHITE RIVER) (S)
JOB 081451
TRUCKER-VENDING BUILDING
DETAILS

A

B

C

D

E

F

0

0

4

3

2

1

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REGISTERED ARCHITECT
[Signature]
 License No. 2671
 STATE OF ARKANSAS

JRR
 Appr.
 10/1/15
 Date


ISSUED FOR CONSTRUCTION
 Description

PC
 Symbol


Submitted by John T. Watkins, III, PE, SE Director, Federal Services	Job Number 060451	Drawn by J. DEMARRE	Plot Date 10/1/15	Plot Scale 1" = 1"	Divg. Code N/A	File Name AHSWR-A-534.DWG
Designed by J. RAHSEY	Job Number 060451	Drawn by J. DEMARRE	Plot Date 10/1/15	Plot Scale 1" = 1"	Divg. Code N/A	File Name AHSWR-A-534.DWG


ARKANSAS HIGHWAY AND TRANSPORTATION DEPARTMENT
 ARKANSAS TOURIST INFORMATION CENTER
 (WHITE RIVER) (S)
 JOB 081451
 TRUCKER-VENDING BUILDING
 DETAILS

Sheet Reference Number:
A-534
 Sheet 76 of 130

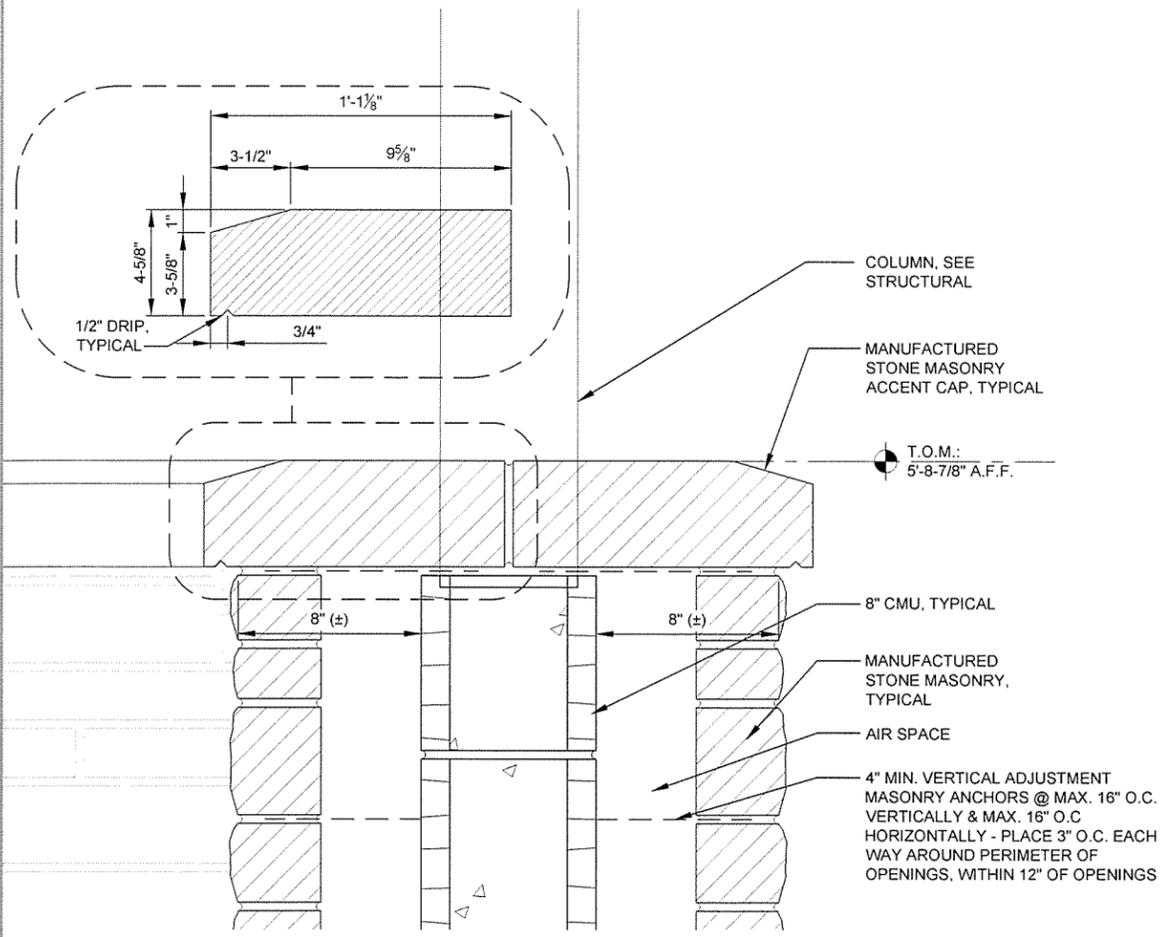


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 A-534
SCREEN WALL DETAIL
 SCALE: 3" = 1'-0"

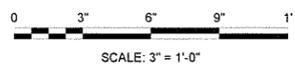

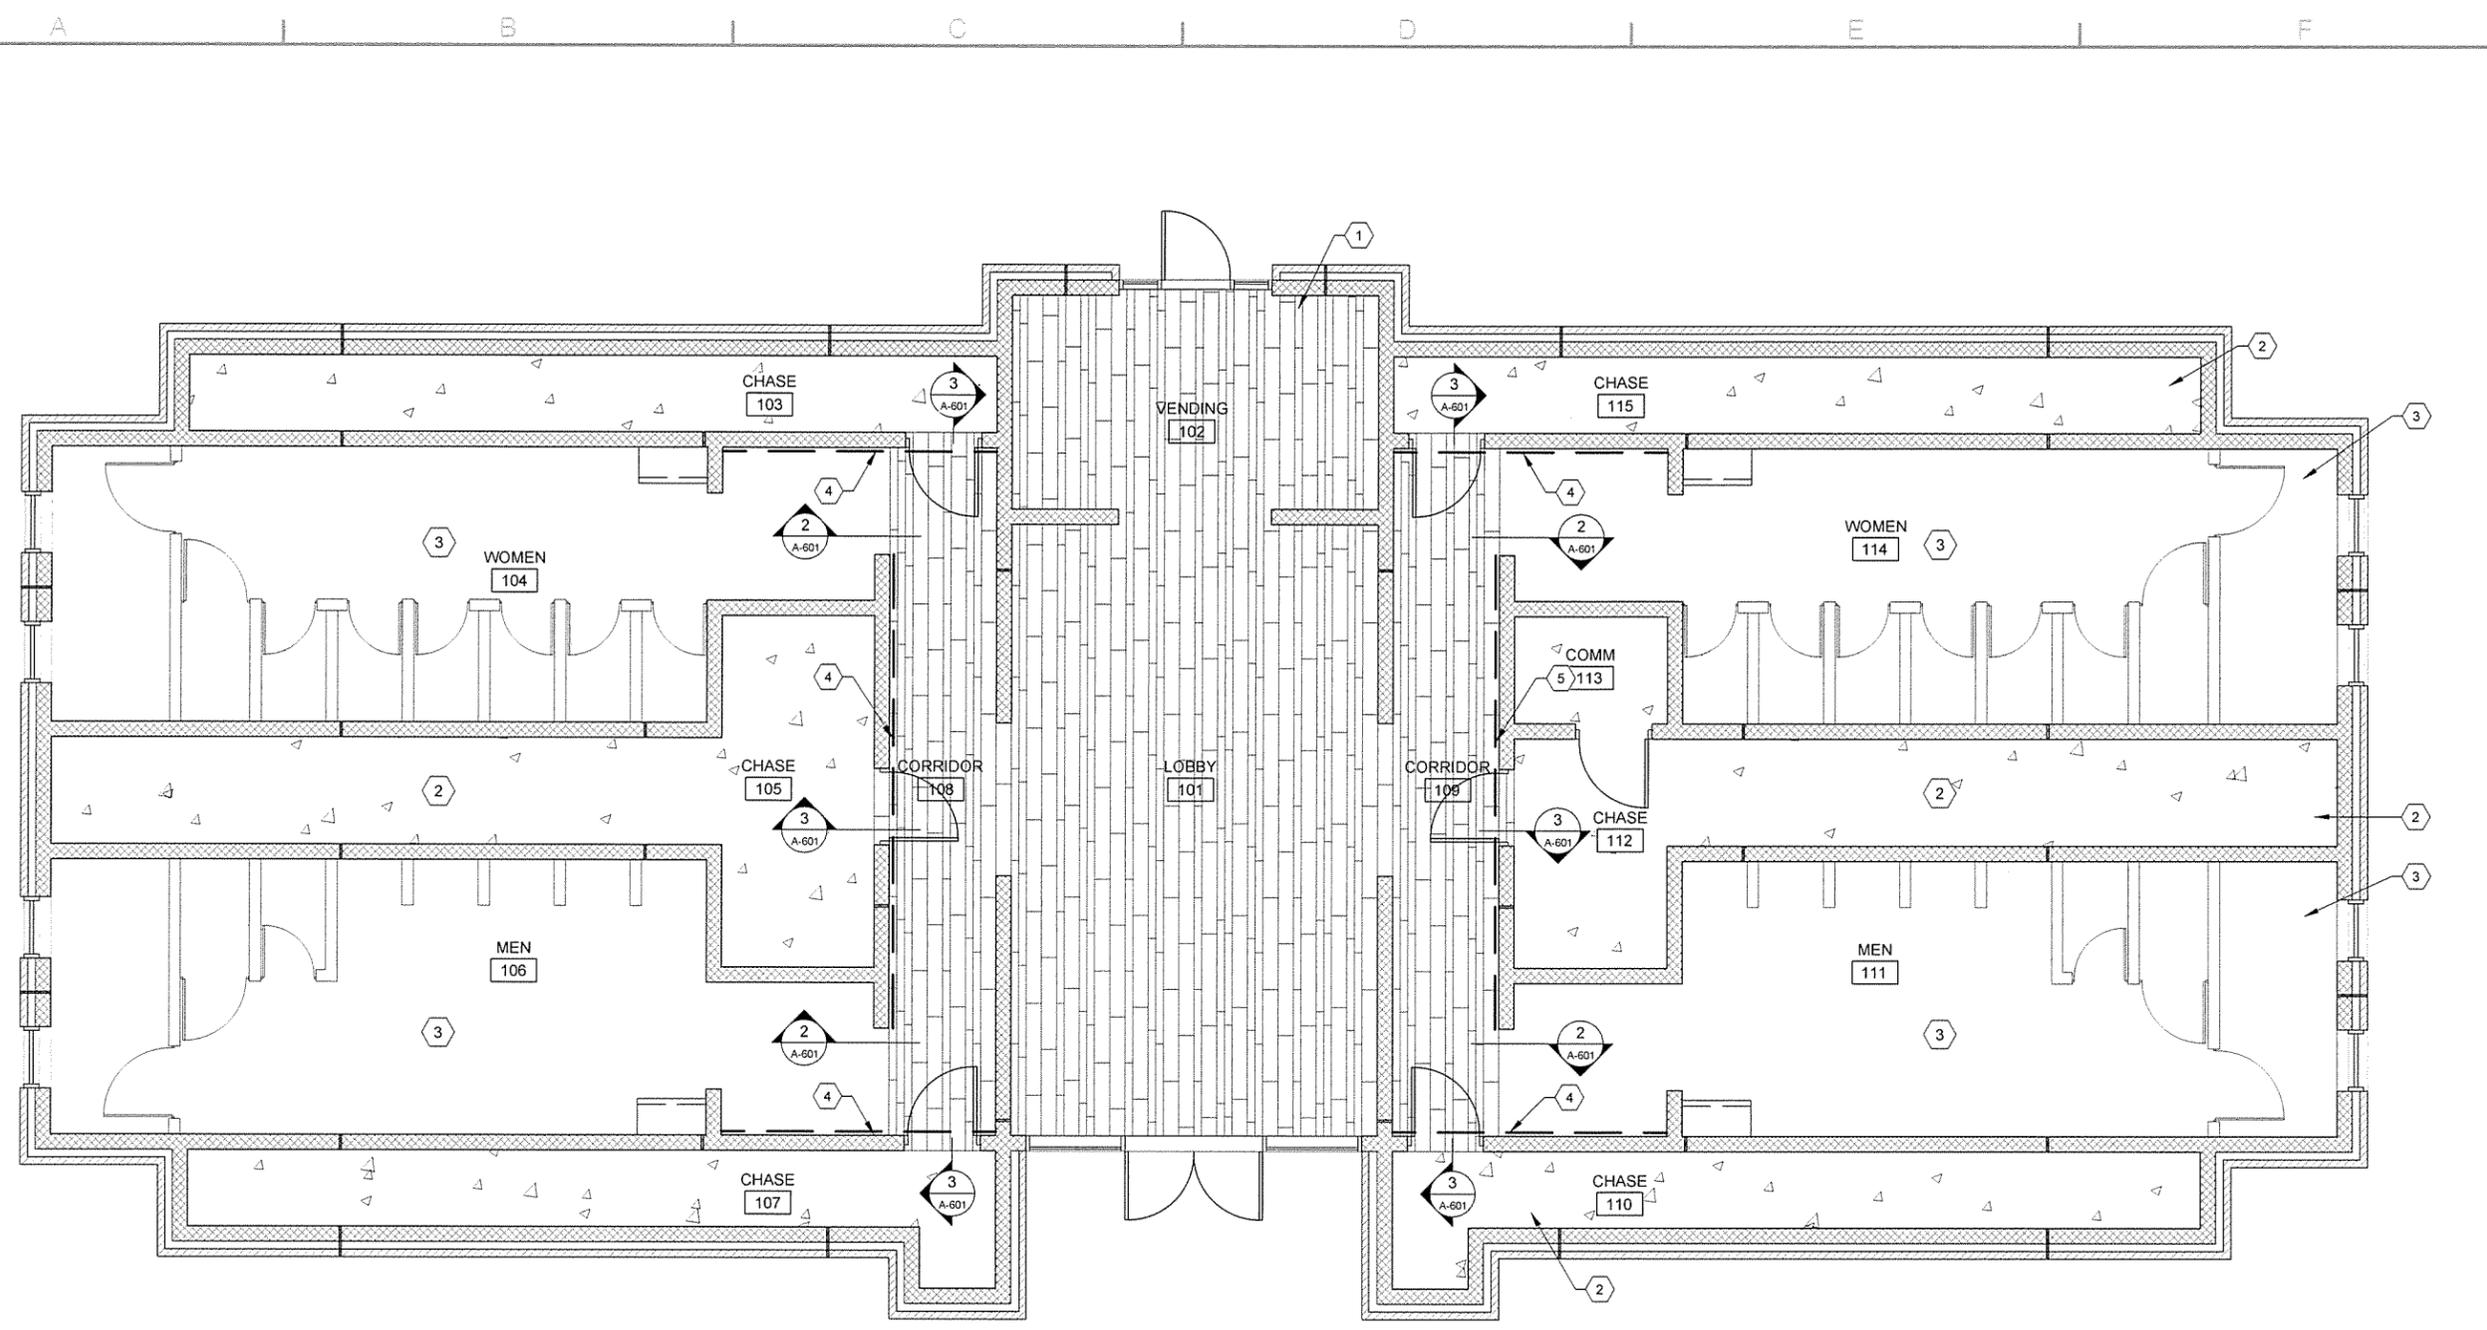


1
A-601
FLOOR PATTERN PLAN
SCALE: 1/4" = 1'-0"
PLAN NORTH


- KEYED NOTES**
- 1 48" LONG FLOOR TILES, T1
 - 2 SEALED CONCRETE FLOOR
 - 3 COATING SYSTEM FLOOR, ECS3
 - 4 DASHED LINE INDICATES FLOOR TO CEILING VINYL WALL MURAL

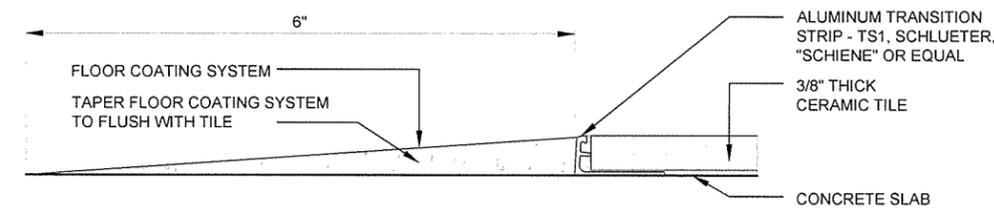

2
A-601
FLOOR TRANSITION DETAIL
SCALE: FULL SIZE

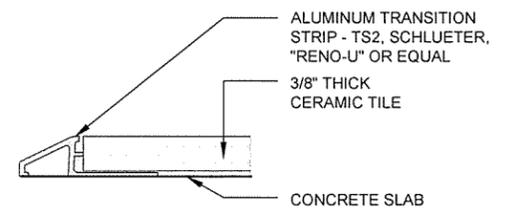

3
A-601
FLOOR TRANSITION DETAIL
SCALE: FULL SIZE

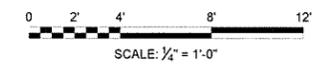

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JRR	Appr.
10/1/15	Date
ISSUED FOR CONSTRUCTION	Description
IPC	Symbol

Submitted by John T. Walters, III, Director, Federal Services	Job Number 060451	PE/SE N/A	Plot Scale 1:1	Dirvg Code N/A	File Name AHS15R-A-601.DWG
Designed by P. MASON	Drawn by P. MASON	Checked by G. ARCHER	Plot Date 10/1/15	Dirvg Code N/A	File Name AHS15R-A-601.DWG

ARKANSAS HIGHWAY AND TRANSPORTATION DEPARTMENT
ARKANSAS TOURIST INFORMATION CENTER
(WHITE RIVER) (S)
JOB 061451

TOURIST INFORMATION CENTER
FLOOR PATTERN PLAN

Sheet Reference Number:
A-601
Sheet 77 of 130

GENERAL NOTES

IN CASE OF A CONFLICT BETWEEN THE GENERAL NOTES AND THE SPECIFICATIONS, CONSULT THE ENGINEER FOR CLARIFICATION PRIOR TO WORK.

DESIGN DATA

1. DESIGN CODES - (ALL LATEST EDITIONS UNLESS NOTED OTHERWISE.)

- 2012 ARKANSAS FIRE PREVENTION CODE
- ASCE 7-10 - MINIMUM DESIGN LOADS FOR BUILDINGS AND OTHER STRUCTURES
- AISC 360-10
- ACI 318-11

2. MATERIAL SPECIFICATIONS AND DESIGN STRESSES

- ANCHOR RODS FY = 36,000 PSI (ASTM F1554 WELDABLE)
- STRUCTURAL STEEL FY = 50,000 PSI (ASTM A992, IF UNAVAILABLE (W & WT SHAPES) LOCALLY ASTM A572, GRADE 50)
- STRUCTURAL STEEL FY = 36,000 PSI (ASTM A36) (L & C SHAPES & PLATES)
- RECTANGULAR HSS FY = 46,000 PSI (ASTM A500, GRADE B)
- ROUND HSS FY = 42,000 PSI (ASTM A500, GRADE B)
- PIPE FY = 35,000 PSI (ASTM A53, GRADE B)

- CAST-IN-PLACE CONCRETE

- FOOTINGS F_c = 4,000 PSI AT 28 DAYS
- SLAB-ON-GRADE F_c = 4,000 PSI AT 28 DAYS
- ELEVATED SLABS F_c = 4,000 PSI AT 28 DAYS
- REINFORCING STEEL
- #3 AND LARGER BARS FY = 60,000 PSI (ASTM A615, GRADE 60)

3. RISK CATEGORY II

4. LIVE LOADS

- ROOF (NOT REDUCIBLE) 20 PSF
- FLOOR 100 PSF
- ELEVATED SLAB 40 PSF

5. WIND LOAD PARAMETERS (ASCE 7-10)

- BASIC WIND SPEED 115 MPH
- WIND EXPOSURE CATEGORY C
- INTERNAL PRESSURE COEFFICIENT, GCPI ±0.18
- COMPONENTS & CLADDING PRESSURE SEE WIND LOADS TABLE

6. SNOW LOAD PARAMETERS (ASCE 7-10)

- GROUND SNOW LOAD, P_g 10 PSF
- UNIFORM ROOF DESIGN SNOW LOAD P_f 7 PSF
- SNOW EXPOSURE FACTOR C_e 1.0
- SNOW LOAD IMPORTANCE FACTOR, I 1.0
- THERMAL FACTOR C_t 1.0

7. SEISMIC LOADS (ASCE 07-10)

- RISK CATEGORY II
- SITE CLASS D
- SPECTRAL RESPONSE ACCELERATION COEFFICIENTS S_s = 0.577 / S₁ = 0.219 (5% DAMPING, SITE CLASS B) S_{0.5} = 0.575 / S_{0.1} = 0.287
- SEISMIC DESIGN CATEGORY D
- IMPORTANCE FACTOR I_e 1.0
- ANALYSIS PROCEDURE EQUIVALENT LATERAL FORCE PROCEDURE
- SEISMIC RESISTING SYSTEM SPECIAL REINFORCED MASONRY SHEAR WALLS: R=5, Ω=2½, C_g=3½

GENERAL INFORMATION

- PRIOR TO FABRICATION AND/OR ERECTION OF ANY MATERIALS, FIELD VERIFY ALL PERTINENT EXISTING DIMENSIONS, ELEVATIONS, AND CONDITIONS AND REPORT ANY DISCREPANCIES TO THE ENGINEER.
- UNLESS OTHERWISE NOTED OR DETAILED, CONCRETE PADS FOR MECHANICAL EQUIPMENT SHALL BE 4" THICK (MINIMUM) AND REINFORCED WITH #3 @ 12" OC EACH WAY CENTERED.
- SUBSTITUTION OF EXPANSION ANCHORS FOR EMBEDDED ANCHORS SHALL NOT BE PERMITTED.
- PERMANENT STABILITY OF THE BUILDING AND COMPONENTS IS NOT PROVIDED UNTIL THE ERECTION IS COMPLETED AS SHOWN ON THE CONTRACT DRAWINGS. PER SECT 7.10.4 OF AISC CODE OF STANDARD PRACTICE FOR BUILDINGS AND BRIDGES AUGUST 25, 2010 "TEMPORARY SUPPORTS, SUCH AS TEMPORARY GUYS, BRACES, FALSEWORK, CRIBBING OR OTHER ELEMENTS REQUIRED FOR THE ERECTION OPERATION WILL BE DETERMINED, FURNISHED AND INSTALLED BY THE ERECTOR."
- WEIGHTS OF MECHANICAL EQUIPMENT SHOWN ARE FOR UNITS SPECIFIED BY THE MECHANICAL ENGINEER. VERIFY WEIGHTS AND ANY SUBSTITUTIONS THAT RESULT IN INCREASED WEIGHT MUST BE APPROVED BY THE ENGINEER.
- ENSURE THAT NO CONSTRUCTION LOAD EXCEEDS THE DESIGN LIVE LOADS INDICATED ON THE STRUCTURAL DRAWINGS AND THAT THESE LOADS ARE NOT PUT ON THE STRUCTURAL MEMBERS PRIOR TO THE TIME THAT ALL FRAMING MEMBERS AND THEIR CONNECTIONS ARE IN PLACE.
- VERIFY THE SIZE AND LOCATION OF EQUIPMENT PADS AND PENETRATIONS THROUGH THE STRUCTURE FOR MECHANICAL, ELECTRICAL, AND PLUMBING WORK. OPENINGS AND PENETRATIONS NOT SPECIFICALLY SHOWN ON THE STRUCTURAL DRAWINGS SHALL BE SUBJECT TO APPROVAL BY THE ENGINEER.
- REFER TO ARCHITECTURAL DRAWINGS FOR ADDITIONAL INFORMATION TO BE COORDINATED WITH THE STRUCTURAL DRAWINGS.
- EXPANSION JOINT FILLER SHALL BE NON-EXTRUDING PREMOLDED MATERIAL COMPOSED OF FIBERBOARD IMPREGNATED WITH ASPHALT CONFORMING TO THE REQUIREMENTS OF ASTM D1751 UNLESS NOTED OTHERWISE.

FOUNDATIONS/GEOTECHNICAL

- FOUNDATION DESIGN IS BASED ON THE SOIL INVESTIGATION BY THE ARKANSAS HIGHWAY AND TRANSPORTATION DEPARTMENT PERFORMED ON MARCH 24TH, 2015 AND THE FOUNDATION RECOMMENDATIONS CONTAINED IN THE REPORT BY GRUBBS, BARTON, HOSKYN AND WYATT (GRUBBS JOB # 15-096A) DATED JUNE 26TH, 2015.
- FOOTINGS SHALL BE FOUNDED A MINIMUM OF 1.5 FEET BELOW LOWEST ADJACENT GRADE. CONTINUOUS FOOTINGS ARE DESIGNED BASED ON 2000PSF ALLOWABLE BEARING CAPACITY. INDIVIDUAL FOOTINGS ARE DESIGNED UPON 2500PSF ALLOWABLE BEARING CAPACITY.
- BUILDING PAD PREPARATION
 - MASS UNDERCUT SITE TO A DEPTH OF 2 FEET BELOW THE FOOTING BEARING ELEVATION (APPROXIMATELY 4 FOOT BELOW EXISTING GRADES). THE MASS UNDERCUT SHALL EXTEND AT LEAST 8 FEET OUTSIDE THE BUILDING LIMITS TO THE EXTENT POSSIBLE.
 - AFTER STRIPPING AND GRADING, BUT PRIOR TO PLACING ANY FILL, THE SUBGRADE SHOULD BE PROOF ROLLED WITH A PNEUMATIC-TIRED ROLLER, LOADED TANDEM DUMP TRUCK, OR OTHER SIMILAR EQUIPMENT.
 - SOFT AND/OR LOOSE ZONES SHOULD BE UNDERCUT AND BE REPROCESSED AND RE-COMPACTED OR REPLACED WITH SELECT FILL.
 - ON-SITE SOILS ARE NOT SUITABLE FOR USE AS FILL OR BACKFILL IN THE BUILDING AREAS. IMPORTED BORROW OR FILL OR BACKFILL SHOULD CONSIST OF LOW-PLASTICITY CLAYEY SAND (SC), SANDY CLAY (CL), OR CLAYEY GRAVEL (GC) WITH A LIQUID LIMIT LESS THAN 45 AND A PLASTICITY INDEX (PI) OF 5 TO 18. FILL AND BACKFILL IN THE BUILDING AREAS SHOULD BE COMPACTED TO A MINIMUM OF 98% OF THE STANDARD PROCTOR (AASHTO T 99) MAXIMUM DRY DENSITY WITHIN A WATER CONTENT RANGE OF MINUS 1 TO PLUS 3 PERCENT OF THE OPTIMUM VALUE. FILL AND BACKFILL SHOULD BE PLACED IN NOMINAL 6 TO 8 INCH THICK LOOSE LIFTS. EACH LIFT OF FILL AND BACKFILL SHOULD BE PROPERLY COMPACTED, TESTED AND APPROVED PRIOR TO PLACING SUBSEQUENT LIFTS.

CAST-IN-PLACE CONCRETE

- UNLESS OTHERWISE NOTED, UNDER ALL INTERIOR FLOOR SLABS-ON-GRADE, PLACE A MINIMUM 10 MIL VAPOR RETARDER ON TOP OF 6" OF COMPACTED CLEAN, CRUSHED STONE DENSIFIED WITH VIBRATING EQUIPMENT PRIOR TO FLOOR SLAB CONSTRUCTION. THE SUBGRADE SOIL DIRECTLY BELOW THE STONE BASE COURSE SHALL BE PREPARED AS SPECIFIED IN THE FOUNDATIONS/GEOTECHNICAL NOTES. THIS SHEET.
- PROVIDE SUITABLE WIRE SPACERS, CHAIRS, TIES, ETC. FOR SUPPORTING REINFORCING STEEL IN THE PROPER POSITION WHILE PLACING CONCRETE.
- REINFORCING SHALL CONFORM TO THE REQUIREMENTS OF ASTM A615, GRADE 60.
- FABRICATION OF REINFORCING STEEL SHALL BE IN ACCORDANCE WITH THE DETAILS OF ACI 315-04, "DETAILING OF CONCRETE REINFORCEMENT".
- UNLESS OTHERWISE NOTED, LAP SPLICES OR EMBEDMENT LENGTHS SHALL CONFORM TO THE FOLLOWING TABLE:

LAP LENGTHS FOR SPLICES *		
BAR SIZE	TOP BARS**	OTHER
#3	2'-5"	1'-11"
#4	3'-3"	2'-6"
#5	4'-1"	3'-1"
#6	4'-10"	3'-9"
#7	8'-10"	6'-9"
#8	10'-1"	7'-9"
#9	11'-4"	8'-9"


*BASED ON MINIMUM CONCRETE COVER OF 1½". AGGREGATE SIZE 1" MAX
 **TOP BARS ARE HORIZONTAL BARS WITH MORE THAN TWELVE (12) INCHES OF CONCRETE CAST BELOW BARS.

- FLOOR SLAB-ON-GRADE TOP MAT REINFORCING SHALL BE LOCATED 1½" CLEAR FROM TOP OF SLABS & 3" CLEAR FROM BOTTOM OF THE SLAB FOR A BOTTOM MAT IF APPLICABLE UNLESS NOTED OTHERWISE. IF ONLY ONE MAT OF STEEL IS REQUIRED THEN IT SHALL BE CONSIDERED A TOP MAT.
- UNLESS NOTED OTHERWISE, PROVIDE CONCRETE COVER AS NOTED IN THE FOLLOWING TABLE:

CONCRETE COVER FOR CAST-IN-PLACE NON-PRESTRESSED CONCRETE FOR BUILDINGS					
DESCRIPTION	SINGLE LAYER	TWO LAYERS		REMARKS	
		TOP	BOT		
SLABS ON GRADE	CENTER	1½"	3" *	* IF CAST ON EARTH	
BEAMS	SLAB TURNDOWN	2" **	1½" **	** 2" FOR #6 & LARGER WHEN EXPOSED TO WEATHER	
OTHER	SPOT FOOTINGS	3" *	2"		
	COLUMNS & PLINTHS	1½" **	-		


NOTE:
 UNLESS OTHERWISE NOTED ON DRAWINGS, CONCRETE COVER OVER PRIMARY REINFORCEMENT, TIES, STIRRUPS AND SPIRALS SHALL COMPLY WITH LISTED VALUES. COVER SHALL COMPLY WITH REQUIREMENTS OF ACI 318 FOR ELEMENTS NOT DESCRIBED.

MAINTENANCE BUILDING WIND LOADS TABLE				
MARK	AREA	SURFACE PRESSURE (PSF)		
		10 SF	50 SF	100 SF
①	NEGATIVE ZONE 1	-26.4	-24.7	-23.9
②	NEGATIVE ZONE 2	-45.9	-37.4	-33.7
③	NEGATIVE ZONE 3	-67.9	-57.7	-53.3
②A	ZONE 2 OVERHANG	-53.7	-53.7	-53.7
③A	ZONE 3 OVERHANG	-90.4	-69.9	-61.1
	POSITIVE ALL ZONES	16.6	16.6	16.6

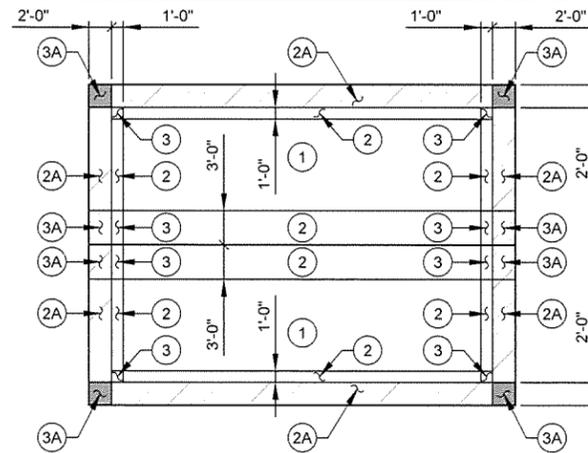

MAINTENANCE BUILDING WIND UPLIFT DIAGRAM (ROOF)

TRUCKER-VENDING BUILDING WIND LOADS TABLE				
MARK	AREA	SURFACE PRESSURE (PSF)		
		10 SF	50 SF	100 SF
①	NEGATIVE ZONE 1	-26.4	-24.7	-23.9
②	NEGATIVE ZONE 2	-45.9	-37.4	-33.7
③	NEGATIVE ZONE 3	-67.9	-57.7	-53.3
②A	ZONE 2 OVERHANG	-53.7	-53.7	-53.7
③A	ZONE 3 OVERHANG	-90.4	-69.9	-61.1
	POSITIVE ALL ZONES	16.6	16.6	16.6

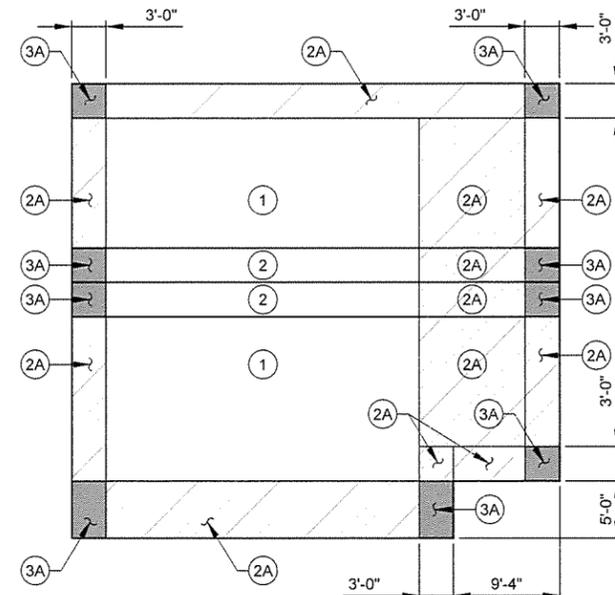

TRUCKER-VENDING BUILDING WIND UPLIFT DIAGRAM (ROOF)



Professional Engineer Seal for John T. Valians, License No. 15642, State of Arkansas. Date: 2/30/15.

JRR	Appr.
10/1/15	Date
ISSUED FOR CONSTRUCTION	Description
IPC	Symbol

Job Number	060451
Submitted by	John T. Valians, PE, SE
Director, Central Services	N/A
Plot State	11
Plot Date	9/30/15
Dwg Code	
Designed by	D. CLEMENT
Drawn by	S. BOVEN
Checked by	G. ARCHER
File Name	AH15WV-S-001.DWG

ARKANSAS HIGHWAY AND TRANSPORTATION DEPARTMENT
 ARKANSAS TOURIST INFORMATION CENTER
 (WHITE RIVER) (S)
 JOB 061451

MASONRY

- CONCRETE MASONRY UNITS SHALL CONFORM TO ASTM C90 FOR LOAD-BEARING CONCRETE MASONRY UNITS.
- THE NET AREA COMPRESSIVE STRENGTH OF MASONRY, f_m , SHALL BE A MINIMUM OF 1,500 PSI AND THE MINIMUM NET AREA COMPRESSIVE STRENGTH OF CONCRETE MASONRY UNITS SHALL BE 2,800 PSI.
- MORTAR SHALL BE TYPE "S" WITH A MINIMUM COMPRESSIVE STRENGTH OF 1,800 PSI AT 28-DAYS. MORTAR SHALL CONFORM TO ASTM C270 AND SHALL CONFORM TO ARTICLES 2.1A AND 2.6A OF TMS 602/ ACI 530.1 / ASCE6 (ALL LATEST EDITIONS).
- ALL GROUT FOR MASONRY CONSTRUCTION SHALL CONFORM TO ASTM C476 OR ARTICLE 2.2 OF TMS 602 / ACI 530.1 / ASCE6 (ALL LATEST EDITIONS). PROVIDE FINE GROUT WITH A MINIMUM COMPRESSIVE STRENGTH OF 2,000 PSI AT 28-DAYS. GROUT SHALL BE PLACED IN MAXIMUM LIFTS OF 4'-0".
- VERTICAL CELLS TO RECEIVE GROUT SHALL HAVE VERTICAL ALIGNMENT SUFFICIENT TO MAINTAIN A CONTINUOUS UNOBSTRUCTED VERTICAL CELL NOT LESS THAN 2"x3" IN PLAN DIMENSION.
- VERTICAL REINFORCEMENT SHALL BE AS NOTED ON DRAWINGS. PLACE VERTICAL REINFORCING BARS AT CORNERS, JAMBS OF OPENINGS BELOW BEAM BEARING, AND IN WALLS AS INDICATED ON THE DRAWINGS. VERTICAL WALL REINFORCING BARS SHALL EXTEND CONTINUOUS FROM FOUNDATION TO EMBED AT LEAST 6" INTO TOP BOND BEAM. PROVIDE VERTICAL REINFORCEMENT IN LAST TWO CELLS AT EACH END OF WALL.
- DOWEL VERTICAL REINFORCING BARS OUT OF THE FOUNDATION OR STRUCTURE BELOW WITH BARS OF THE SAME SIZE AND SPACING ABOVE. DOWELS SHALL EXTEND A MINIMUM OF 40 DIAMETERS INTO THE MASONRY WALL. THERE SHALL BE A FOUNDATION DOWEL FOR EACH VERTICAL REINFORCING BAR. PROVIDE A STANDARD 90° HOOK ON THE ENDS OF THE FOUNDATION DOWELS EMBEDDED IN THE FOUNDATION UNLESS NOTED OTHERWISE.
- HORIZONTAL JOINT REINFORCING SHALL BE W1.7 LADDER-TYPE HORIZONTAL JOINT REINFORCEMENT AT 16" OC.
- VERTICAL REINFORCING BARS SHALL BE CENTERED IN CELLS THROUGHOUT THE HEIGHT OF THE WALL UNLESS NOTED OTHERWISE. PROVIDE REBAR POSITIONERS AS REQUIRED TO MAINTAIN VERTICAL ALIGNMENT.
- LAPS OR SPLICES OF REINFORCING STEEL IN MASONRY SHALL BE THE GREATER OF 24" OR 40 BAR DIAMETERS.
- PLACE HORIZONTAL BARS IN 8" DEEP BOND BEAM UNITS AT TOPS OF ALL WALLS AND WHERE INDICATED. PROVIDE (2) #4 MINIMUM HORIZONTAL BARS.
- CONTINUE BOND BEAM UNITS AND REINFORCING BARS UNINTERRUPTED AROUND CORNERS AND ACROSS WALL INTERSECTIONS. SEE TYPICAL MASONRY DETAILS FOR ADDITIONAL INFORMATION.
- SUBSTITUTION OF BRICKS OR SOLID MASONRY UNITS INTO CMU WALLS AS SPACERS AND/OR SLOPING BOND BEAMS SHALL NOT BE PERMITTED.
- PRIOR TO START OF LAYING MASONRY, THE CONTACT SURFACE OF ALL FOUNDATIONS AND FLOORS WHICH ARE TO RECEIVE MASONRY WORK SHALL BE ROUGHENED AND CLEANED.
- NO TEMPORARY OPENINGS OR PASSAGES OF ANY KIND SHALL BE ALLOWED IN ANY CMU WALL. CLEANOUTS ARE REQUIRED FOR POUR HEIGHTS GREATER THAN 5'-0".
- SUBMIT SHOP DRAWINGS FOR REVIEW BY THE ENGINEER SHOWING: ALL VERTICAL AND HORIZONTAL REINFORCING LOCATIONS AND SPLICE METHODS; LOCATIONS OF BOND BEAMS AND LINTELS; LOCATIONS OF ALL CORES TO BE FILLED WITH GROUT; LOCATIONS OF CONTROL JOINTS; AND LOCATIONS OF ALL EMBEDDED PLATES AND ANCHORS.
- PROVIDE TEMPORARY BRACING FOR ALL MASONRY WALLS CONFORMING TO OSHA REQUIREMENTS UNTIL PERMANENT LATERAL SUPPORT IS COMPLETE.
- THE CONTRACTOR SHALL NOT PLACE LOADS ON BOND BEAMS OR MASONRY CELLS FILLED WITH GROUT UNTIL THE GROUT HAS CURED FOR A MINIMUM OF 3 DAYS.
- GROUT CMU COURSE AT FLOOR LEVEL SOLID.
- GROUT CMU BELOW GRADE SOLID OR AS INDICATED.

STRUCTURAL STEEL

- FABRICATION AND ERECTION OF STRUCTURAL STEEL SHALL BE IN ACCORDANCE WITH AISC SPECIFICATIONS, LATEST EDITION.
- BEAM CONNECTIONS SHALL BE DETAILED AS SHOWN ON THE CONTRACT DRAWINGS.
- UNLESS DETAILED OTHERWISE, ALL SHOP CONNECTIONS SHALL BE WELDED.
- UNLESS DETAILED OTHERWISE, ALL FIELD CONNECTIONS SHALL BE MADE USING 3/4"Ø AND 1"Ø WHERE INDICATED ASTM A325-N HIGH STRENGTH BOLTS ('N' INDICATES BEARING TYPE WITH THREADS INCLUDED IN SHEAR PLANE). WASHERS SHALL BE INSTALLED UNDER NUTS OF FASTENERS WHEN REQUIRED BY THE SPECIFICATIONS OF STRUCTURAL JOINTS.
- WHERE FIELD AND SHOP WELDS ARE INDICATED ON THE DRAWINGS, THEY SHALL BE THE SIZE AND TYPE NOTED. ALL WELDING OF STRUCTURAL STEEL SHALL BE DONE IN ACCORDANCE WITH THE LATEST EDITION OF AWS D1.1 AND ALL WELDS INCLUDING FIELD WELDS SHALL BE MADE BY CERTIFIED WELDERS USING E70XX ELECTRODES.
- HIGH STRENGTH BOLTS (3/4"Ø AND 1"Ø - A325) SHALL BE TIGHTENED BY ONE OF THE FOLLOWING METHODS: POWER WRENCHES ADJUSTED TO STALL OR CUT-OUT AT THE CORRECT TENSION, MANUAL TORQUE WRENCHES WITH TORQUE INDICATION SET TO GIVE THE CORRECT TENSION, OR MANUAL WRENCHES USING THE "TURN-OF-THE-NUT" METHOD OF ASSURING THE CORRECT BOLT TENSION. EACH BOLT SHALL BE TIGHTENED TO PROVIDE, WHEN ALL BOLTS IN THE JOINT ARE TIGHT, A MINIMUM BOLT TENSION OF 28,000 LBS FOR 3/4"Ø BOLTS AND 35,000 LBS FOR 1"Ø BOLTS.
- STEEL ERECTOR SHALL PROVIDE THE NECESSARY BRACING DURING ERECTION AND UNTIL ALL STEEL IS PLUMB AND SECURE.

ABBREVIATIONS

AB	ANCHOR BOLT(S)	EXP	EXPANSION, EXPOSED	MFG	MANUFACTURING	SK	SHEAR KEY
ADDL	ADDITIONAL	EXT	EXTERIOR	MFR	MANUFACTURER	SP	SPACE(S), SOUTHERN PINE
AFF	ABOVE FINISHED FLOOR	F/	FACE OF	MIN	MINIMUM	SPEC	SPECIFICATIONS
ALT	ALTERNATE	FD	FLOOR DRAIN	MISC	MISCELLANEOUS	SQ	SQUARE
ARCH	ARCHITECT(URAL)	FDTN	FOUNDATION	MTL	METAL	SS	STANDING SEAM (ROOF)
BLDG	BUILDING	FIN	FINISH(ED), FINAL	N/A	NOT APPLICABLE	SSL	SHORT SLOTTED HOLE
BLK	BLOCK	FIN FLR	FINISH FLOOR	NIC	NOT-IN-CONTRACT	SST	STAINLESS STEEL
BLKG	BLOCKING	FLR	FLOOR	NOM	NOMINAL	STD	STANDARD
BM	BEAM, BENCHMARK	FS	FAR SIDE, FOOTING STEP, FULL SIZE	NS	NEAR SIDE	STF	STIFFENER
BOT	BOTTOM	FT	FEET, FOOT	NSG	NON-SHRINK GROUT	STL	STEEL
BS	BOTH SIDES	FTG	FOOTING(S)	NTS	NOT-TO-SCALE	STRUCT	STRUCTURAL
BTWN	BETWEEN	GA	GAUGE, GAGE	OC	ON-CENTER	SYMM	SYMMETRICAL
BW	BOTH WAYS	GALV	GALVANIZED	OD	OUTSIDE DIAMETER, OUTSIDE DIMENSION	T&B	TOP AND BOTTOM
CCJ	CRACK CONTROL JOINT	GR	GRADE			T&G	TONGUE AND GROOVE
CIP	CAST-IN-PLACE	GRTG	GRATING	OH	OVERHEAD	TCX	TOP CHORD EXTENSION
CJ	CONTROL, CONTRACTION, OR CONSTRUCTION JOINT	GYP	GYP SUM	OPH	OPPOSITE-HAND	TEMP	TEMPORARY
CJP	COMPLETE JOINT PENETRATION	GYP BD	GYP SUM BOARD	OPNG	OPENING(S)	THK	THICK(NESS)
CL	CENTERLINE	HD	HEAVY-DUTY	OPP	OPPOSITE	THRD	THREAD(ED)
CLR	CLEAR(ANCE)	HDR	HEADER	PCC	PRECAST, PRECAST CONCRETE	THRU	THROUGH
CMU	CONCRETE MASONRY UNIT(S)	HORIZ	HORIZONTAL(LY)	PCF	POUNDS PER CUBIC FOOT	TM	TOP-OF-MASONRY ELEVATION
COL	COLUMN(S)	HS	HEADED STUD(S)	PCF	POUNDS PER CUBIC FOOT	TOB	TOP-OF-BEAM ELEVATION
COL	COLUMN(S)	HSS	HOLLOW STEEL SECTION	PEDESTAL		TOC	TOP-OF-CONCRETE ELEVATION
CONC	CONCRETE	HT	HEIGHT	PL	PLATE(S)	TOF	TOP-OF-FOOTING ELEVATION
CONN	CONNECT, CONNECTION(S)	INT	INTERIOR	PLBG	PLUMBING	TOS	TOP-OF-STEEL ELEVATION
CONT	CONTINUE, CONTINUOUS	JBE	JOIST BEARING ELEVATION	PLF	POUNDS PER LINEAR FOOT	TP	TOP-OF-PARAPET ELEVATION
CTR	CENTER	JST	JOIST(S)	PLYWD	PLYWOOD	TRANS	TRANSVERSE, TRANSOM
CTR	CENTERED	JT	JOINT	PNL	PANEL	TW	TOP-OF-WALL ELEVATION
DIA	DIAMETER	KOBB	KNOCK-OUT BOND BEAM	PROJ	PROJECT(ION)	TYP	TYPICAL
DIAG	DIAGONAL	LB	POUND(S), LAG BOLT(S)	PSF	POUNDS PER SQUARE FOOT	UFC	UNIFORM FACILITIES CRITERIA
DIM	DIMENSION(S)	LDH	LONG DIMENSION HORIZONTAL	PSI	POUNDS PER SQUARE INCH	UL	UNDERWRITERS LABORATORY
DWG	DRAWING(S)	LDO	LONG DIMENSION OUTSTANDING	QTY	QUANTITY	UNO	UNLESS NOTED OTHERWISE
DWLS	DOWEL(S)	LDV	LONG DIMENSION VERTICAL	R	RADIUS, RANGE	VAR	VAPOR RETARDER
EA	EACH	LF	LINEAR FOOT(EET)	RD	ROOF DRAIN	VERT	VERTICAL, VERTICALLY
EBC	EXTENDED BOTTOM CHORD	LIN	LINEAR	REBAR	REINFORCING BAR	VPCT	VAULTED PARALLEL CHORD TRUSS
EF	EACH FACE	LL	LIVE LOAD	REINF	REINFORCE(D), (ING), (MENT)	W/	WITH
EIFS	EXTERIOR INSULATED FINISH SYSTEM	LONG	LONGITUDINAL	REQD	REQUIRED	W/O	WITHOUT
EJ	EXPANSION JOINT	LT	LIGHT	SCHED	SCHEDULE	WD	WOOD, WOOD DOOR
EQ	EQUAL	LT WT	LIGHTWEIGHT	SECT	SECTION	WP	WATERPROOF(ING), WEATHERPROOF, WORK POINT
EQUIP	EQUIPMENT	MAS	MASONRY	SF	SQUARE FOOT(EET)	WS	WATERSTOP
ES	EQUISPACED	MATL	MATERIAL	SHT	SHEET	WT	WEIGHT
EXIST	EXISTING	MAX	MAXIMUM	SIM	SIMILAR	WWR	WELDED-WIRE-REINFORCING
		MECH	MECHANICAL	SJI	STEEL JOIST INSTITUTE		

COLD-FORMED METAL TRUSSES

- ALL COLD-FORMED METAL ROOF TRUSSES ARE TO BE DESIGNED BY THE MANUFACTURER FOR ACTUAL ROOF DEAD LOAD (20 PSF MINIMUM) PLUS THE WEIGHTS OF INDIVIDUAL TRUSSES PLUS 20 PSF ROOF LIVE LOAD. WIND LOAD PER THE COMPONENTS AND CLADDING TABLE SHALL BE INCLUDED IN THE DESIGN. INCLUDE ACTUAL DEAD LOAD OF SUPPORTED MATERIALS AT BOTTOM CHORD PLUS A 5 PSF COLLATERAL DEAD LOAD AT BOTTOM CHORD. TOTAL DEFLECTION SHALL BE LIMITED TO L/240 FOR BOTH INDIVIDUAL MEMBERS AND TRUSSES. LIVE LOAD DEFLECTIONS SHALL BE LIMITED TO L/360. ALL COLD-FORMED METAL, SHALL BE 18 GAUGE MINIMUM. ALL COLD-FORMED METAL SHALL BE GALVANIZED.
- EXACT TRUSS WEB AND CHORD SIZES (SEE ABOVE FOR MINIMUMS) AND LAYOUT ARE TO BE DETERMINED BY THE MANUFACTURER. TRUSS MANUFACTURER TO DESIGN AND FURNISH ANY PERMANENT TRUSS BRACING REQUIRED FOR STABILITY.
- MANUFACTURER TO SUBMIT FOR APPROVAL DESIGN CALCULATIONS WITH SHOP DRAWINGS STAMPED BY PROFESSIONAL ENGINEER REGISTERED IN THE STATE OF ARKANSAS. SHOP DRAWINGS SHALL CLEARLY INDICATE MEMBER SIZES, GAUGE OF MATERIAL, MEMBER DESIGN FORCES, AND MEMBER END WELD SIZES AND LENGTHS.
- TRUSSES AND THEIR CONNECTIONS SHALL BE DESIGNED TO BRACE THE MASONRY WALLS ON WHICH THEY BEAR. WALL OUT-OF-PLANE BRACE FORCE SHALL BE TAKEN AS 448# (STRENGTH LEVEL SEISMIC LOAD) AT THE TOP OF THE WALL FOR TRUSSES THAT BEAR ON WALLS 10 FEET OR LESS IN HEIGHT. THE WALL BRACE FORCE SHALL BE TAKEN AS 728# (STRENGTH LEVEL SEISMIC LOAD) AT THE TOP OF THE WALL FOR TRUSSES THAT BEAR ON WALLS GREATER THAN 10 FEET IN HEIGHT. LOADS INCLUDE 1.4 FACTOR FOR ALL STEEL WALL ANCHORAGE ELEMENTS IN SEISMIC DESIGN CATEGORIES C, D, & F.
- TRUSSES SHALL BE DESIGNED FOR THE PRESSURES AS INDICATED ON THE WIND UPLIFT DIAGRAM AND SHALL BE ANCHORED ACCORDINGLY.

STEEL FLOOR DECK


- METAL FLOOR DECK SHALL BE 2" CONFORM DECK, 20 GAUGE (2C20) AS NOTED. MINIMUM DECK PROPERTIES SHALL BE AS FOLLOWS:
 $I_p = 0.409 \text{ IN}^4/\text{FT}$
 $I_n = 0.406 \text{ IN}^4/\text{FT}$
 $S_p = 0.341 \text{ IN}^3/\text{FT}$
 $S_n = 0.346 \text{ IN}^3/\text{FT}$
- WHERE DECK BEARS ON CMU, ATTACH DECK TO BOND BEAM WITH 36/4 PATTERN USING 3/16"Ø MASONRY SCREWS. LONG PANEL SIDES AT SUPPORTS SHALL BE ATTACHED USING 3/16"Ø MASONRY SCREWS AT 8" OC.

STEEL ROOF DECK

- ROOF DECK SHALL BE WIDE RIB TYPE "B", 1 1/2", 22 GAUGE, GALVANIZED STEEL DECK UNLESS NOTED OTHERWISE ON THE PLANS.
- THE DECK SHALL BE FASTENED TO SUPPORTING STEEL IN ACCORDANCE WITH THE MANUFACTURER'S INSTRUCTIONS. MINIMUM DECK FASTENING SHALL BE AS FOLLOWS: SUPPORT FASTENERS SHALL BE #12 TEK SCREWS IN A 36/4 PATTERN WITH (2) #10 TEK SCREWS PER SIDELAP SPAN AS SIDELAP FASTENERS. LONG PANEL SIDES AT SUPPORT ANGLES AND PLATES SHALL BE FASTENED WITH #12 SCREWS AT 8" OC ALONG FULL LENGTH OF PANEL.
- ROOF DECK SHALL BE CONTINUOUS OVER AT LEAST THREE SUPPORTS.



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JRR
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10/11/15
Date
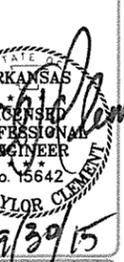
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Description

IPC
Symbol

Job Number
060451

Submitted by
John T. Watkins, III, PE, SE
Director, Federal Services

Drawn by
S. BOWEN

Checked by
G. ARCHER

File Name
AR15WRS-002.DWG


Job Scale
1:1

Plot Date
9/30/15

Dwg Code
N/A

Sheet Reference Number:
S-002

TOURIST INFORMATION CENTER WIND LOADS TABLE				
MARK	AREA	SURFACE PRESSURE (PSF)		
		10 SF	50 SF	100 SF
①	NEGATIVE ZONE 1	-27.4	-25.6	-24.9
②	NEGATIVE ZONE 2	-47.7	-38.9	-35.0
③	NEGATIVE ZONE 3	-70.6	-59.9	-55.3
②A	ZONE 2 OVERHANG	-55.8	-55.8	-55.8
③A	ZONE 3 OVERHANG	-93.9	-72.6	-63.5
	POSITIVE ALL ZONES	17.3	16.0	16.0

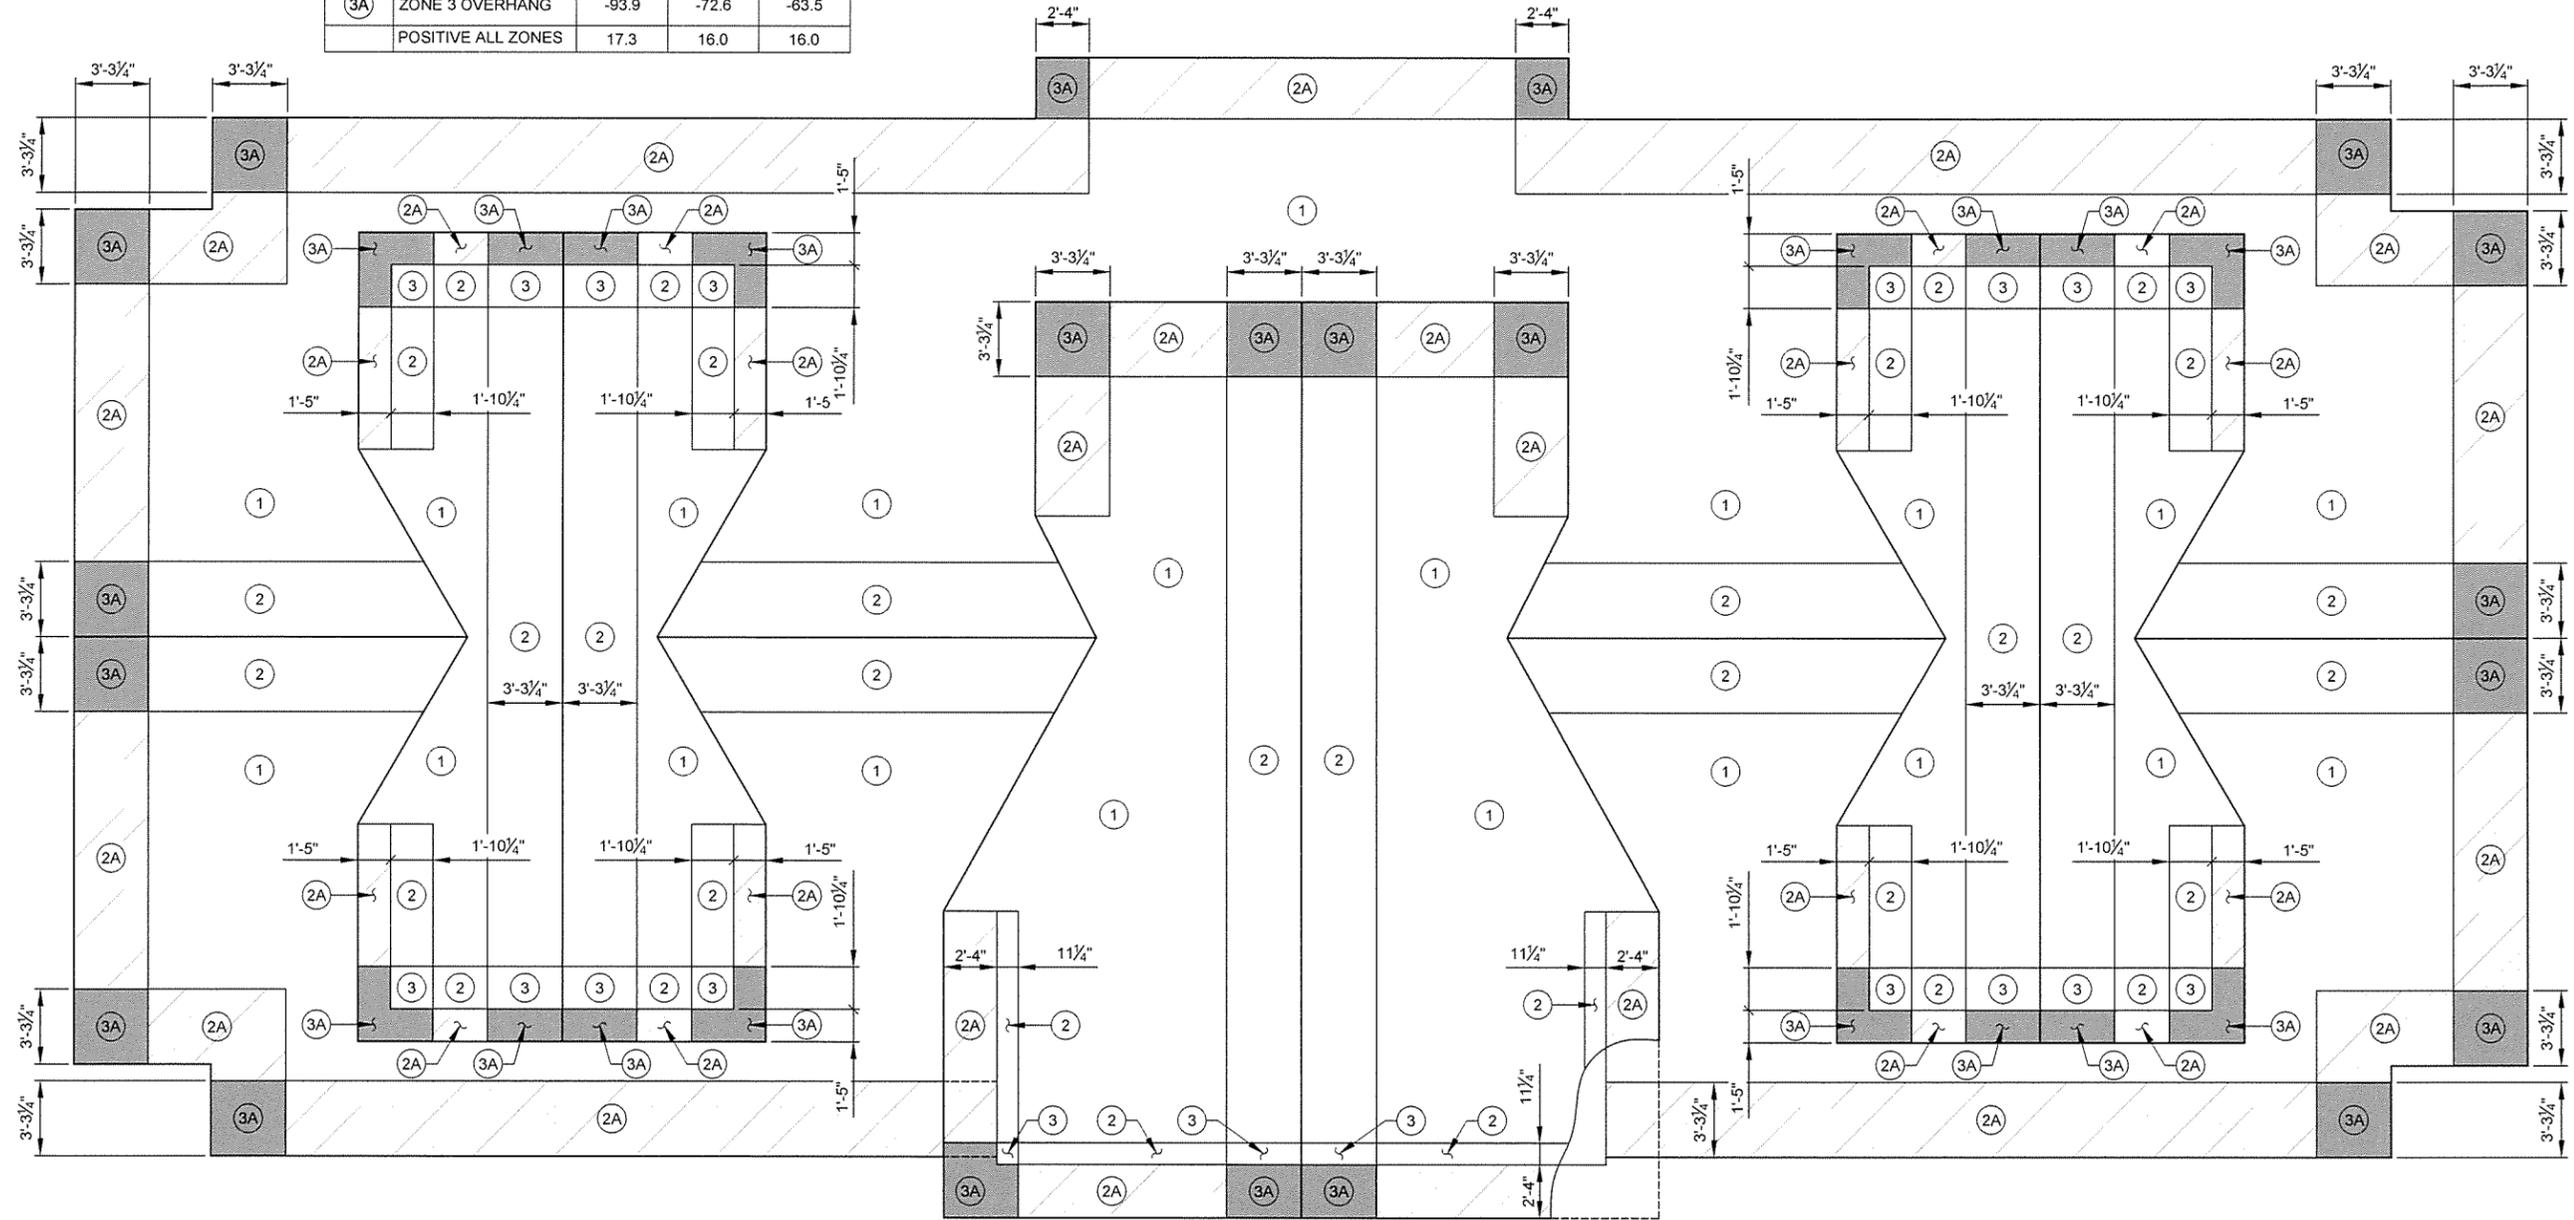

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STATE OF ARKANSAS
LICENSED PROFESSIONAL ENGINEER
No. 06642
TAYLOR CLEMENT
9/30/15


JRR
Appr.
10/1/15
Date

ISSUED FOR CONSTRUCTION
Description
IPC
Symbol

Submitted by
John T. Watkins, III, PE, SE
Director, Federal Services
Job Number
060451
N/A
Plot Date
9/30/15
Plot Scale
1:1
Drawn by
S. BOWEN
Checked by
G. ARCHER
Dwg Code
N/A
File Name
AH15WR-S-003.DWG

ARKANSAS HIGHWAY AND TRANSPORTATION DEPARTMENT
ARKANSAS TOURIST INFORMATION CENTER
(WHITE RIVER) (S)
JOB 061451
TOURIST INFORMATION CENTER
WIND UPLIFT DIAGRAM (ROOF)

Sheet
Reference
Number:
S-003
Sheet 80 of 130

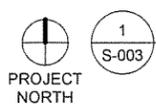

WIND UPLIFT DIAGRAM (ROOF)


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JRR	Appr.
10/1/15	Date
ISSUED FOR CONSTRUCTION	Description
IFC	Symbol

Submitted by	Job Number:			
John T. Watkins, III, PE, SE	060451			
Director, Federal Services	N/A			
Drawn by	Plot Date:	Plot Scale:		
S. BOWEN	9/30/15	1:1		
Checked by	Dwg Code:			
G. ARCHER				
File Name:				
AR15RWS-101.DWG				

ARKANSAS HIGHWAY AND TRANSPORTATION DEPARTMENT
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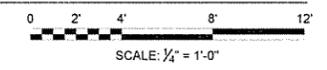
TOURIST INFORMATION CENTER
 FOUNDATION PLAN




- CMU WALL REINFORCING LEGEND**
- 8" CMU WALL REINFORCED WITH #4@48" OC VERT AND HORIZ BOND BEAMS AT 48" OC REINFORCED WITH (2) #4.
 - 8" CMU WALL REINFORCED WITH #4@24" OC VERT AND HORIZ BOND BEAMS AT 48" OC REINFORCED WITH (2) #4.
 - 6" CMU WALL REINFORCED WITH #4@24" OC VERT. (GROUT ALL CELLS SOLID FULL HEIGHT)

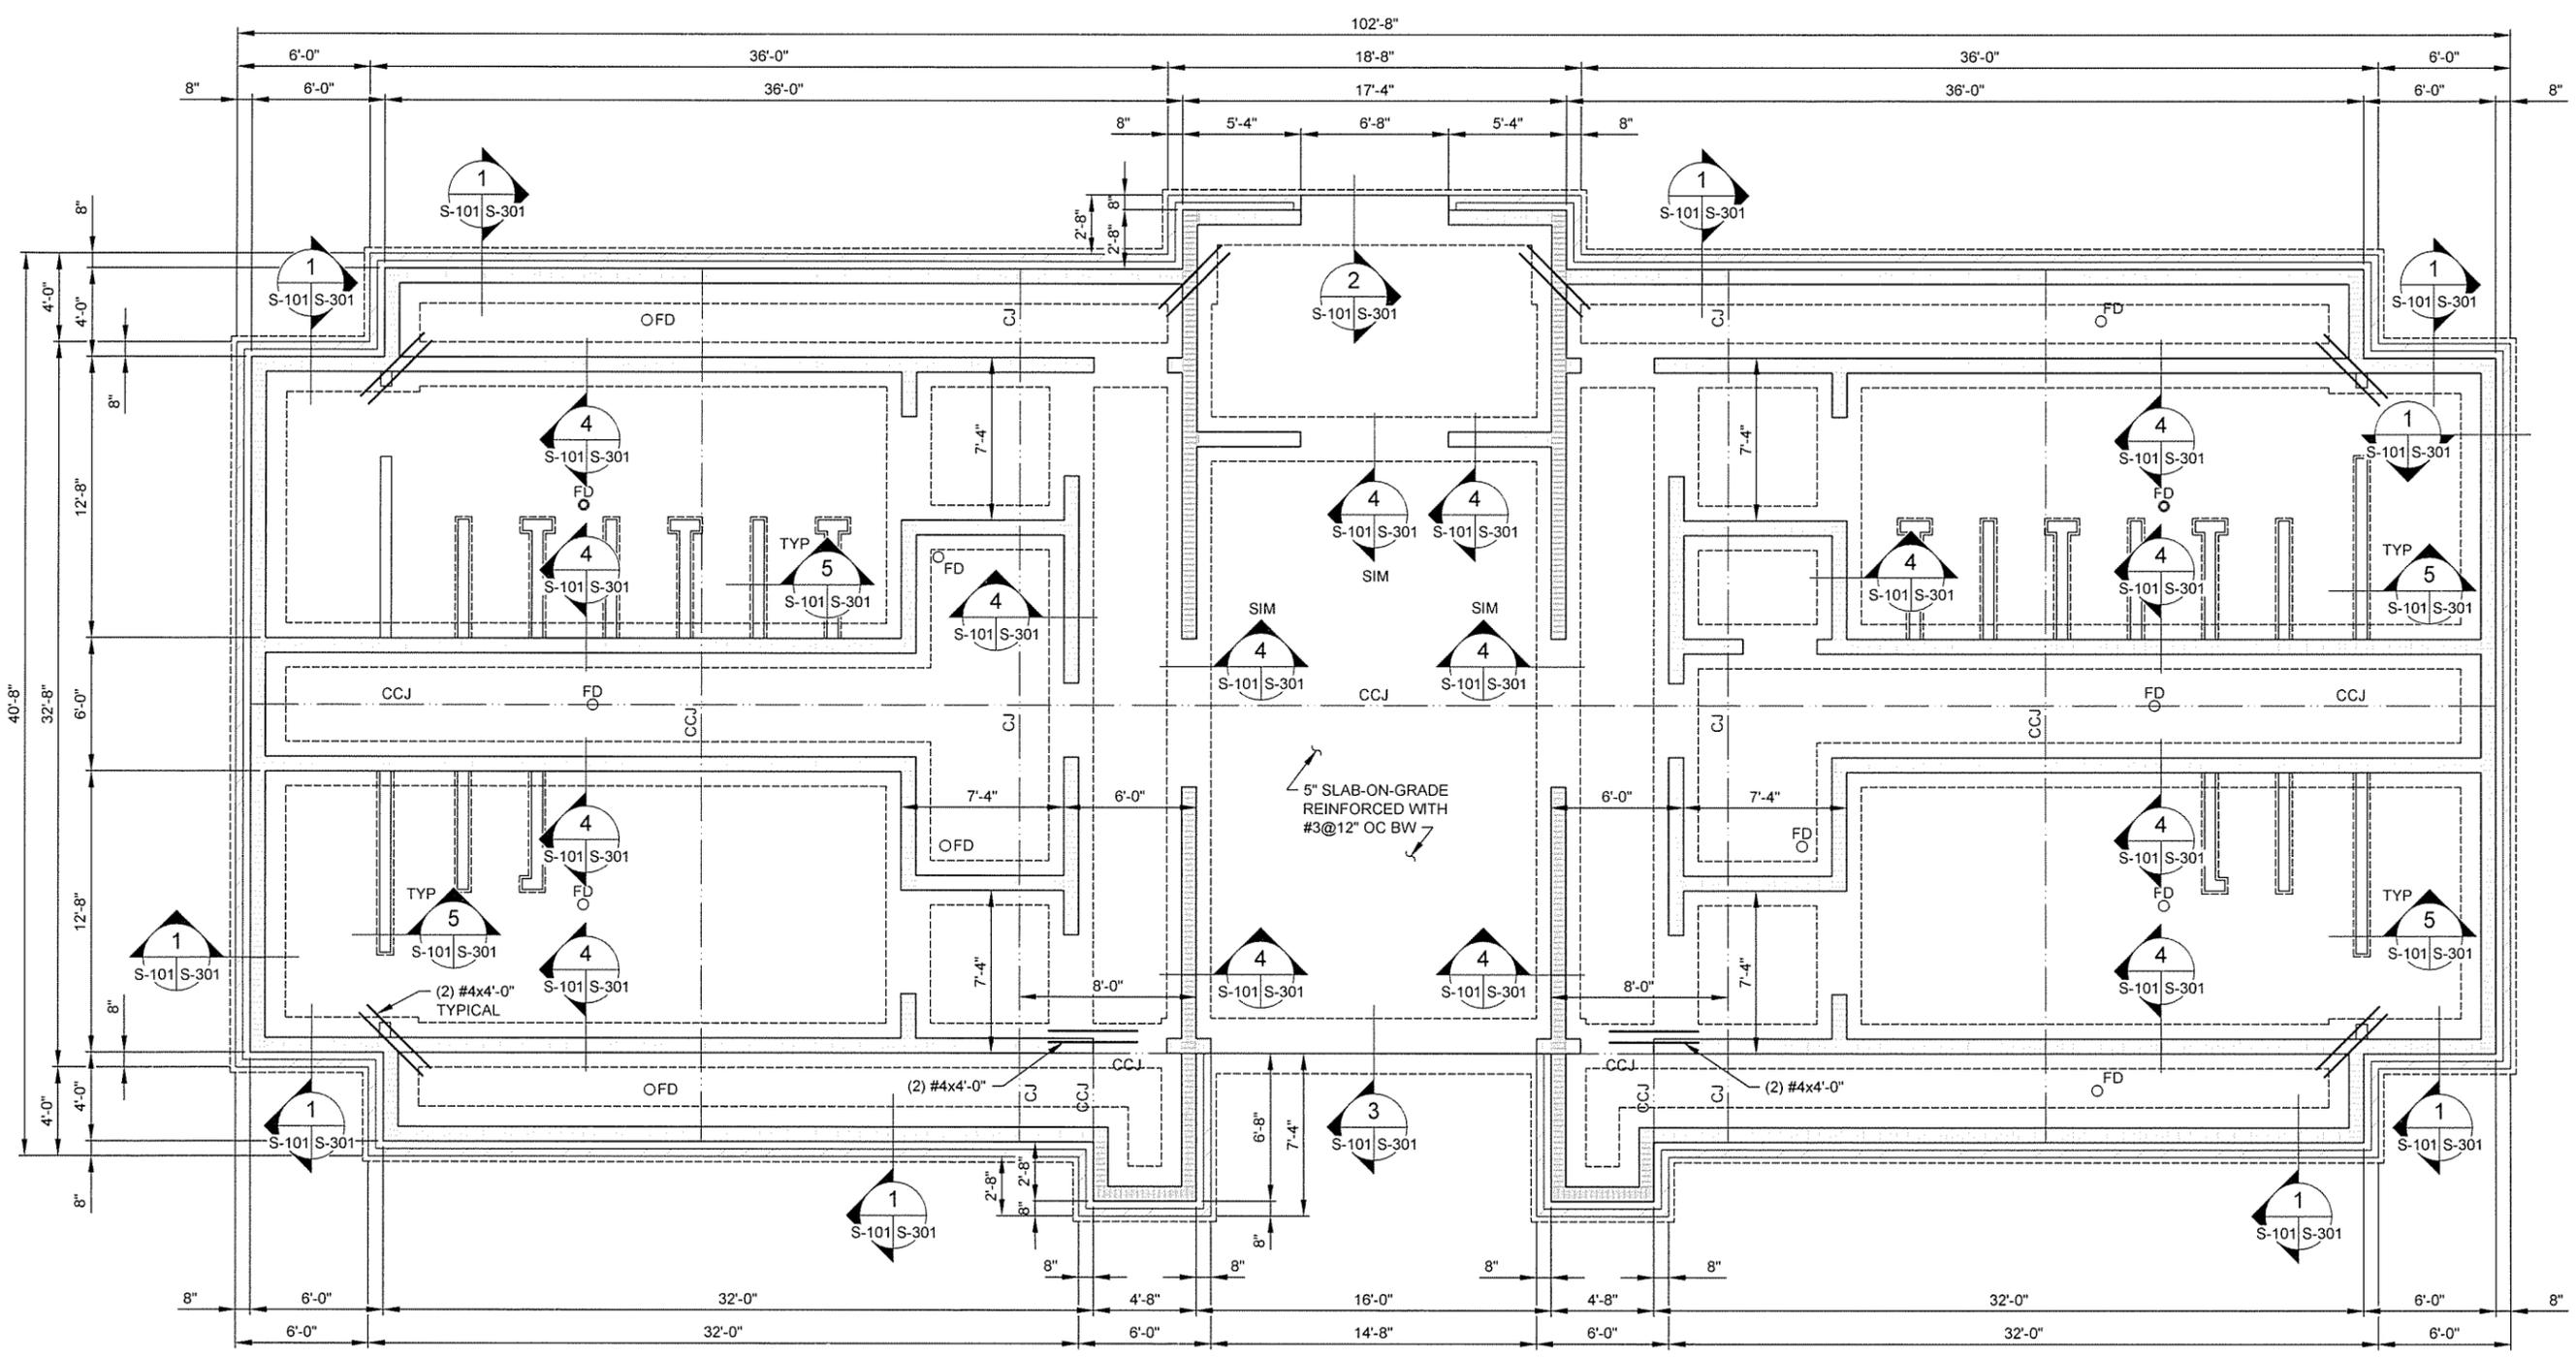NOTE:
 SEE ARCHITECTURAL FOR WALL CONSTRUCTION JOINT LOCATIONS.

FOUNDATION PLAN
 SCALE: 1/4" = 1'-0"
 PROJECT NORTH



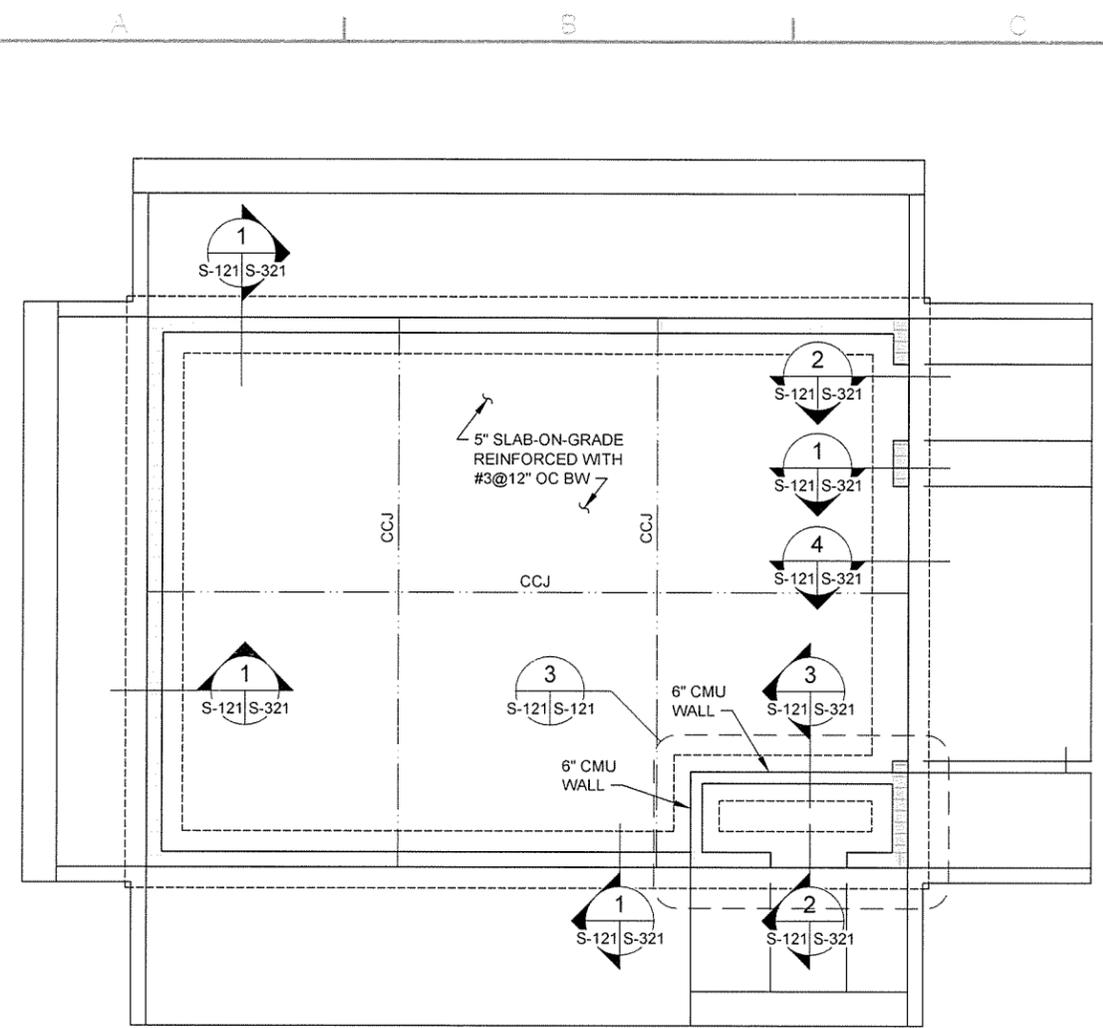


CMU WALL REINFORCING LEGEND


- CMU WALL REINFORCED WITH #4@48\"/> OC VERT AND HORIZ BOND BEAMS AT 48\"/> OC REINFORCED WITH (2) #4.
- CMU WALL REINFORCED WITH #4@8\"/> OC VERT AND HORIZ BOND BEAMS AT 16\"/> OC REINFORCED WITH (2) #4.
- 6\"/> CMU WALL REINFORCED WITH #4@24\"/> OC VERT.

NOTE:
SEE ARCHITECTURAL FOR WALL
CONSTRUCTION JOINT LOCATIONS.


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S-121
FOUNDATION PLAN
SCALE: 1/4" = 1'-0"

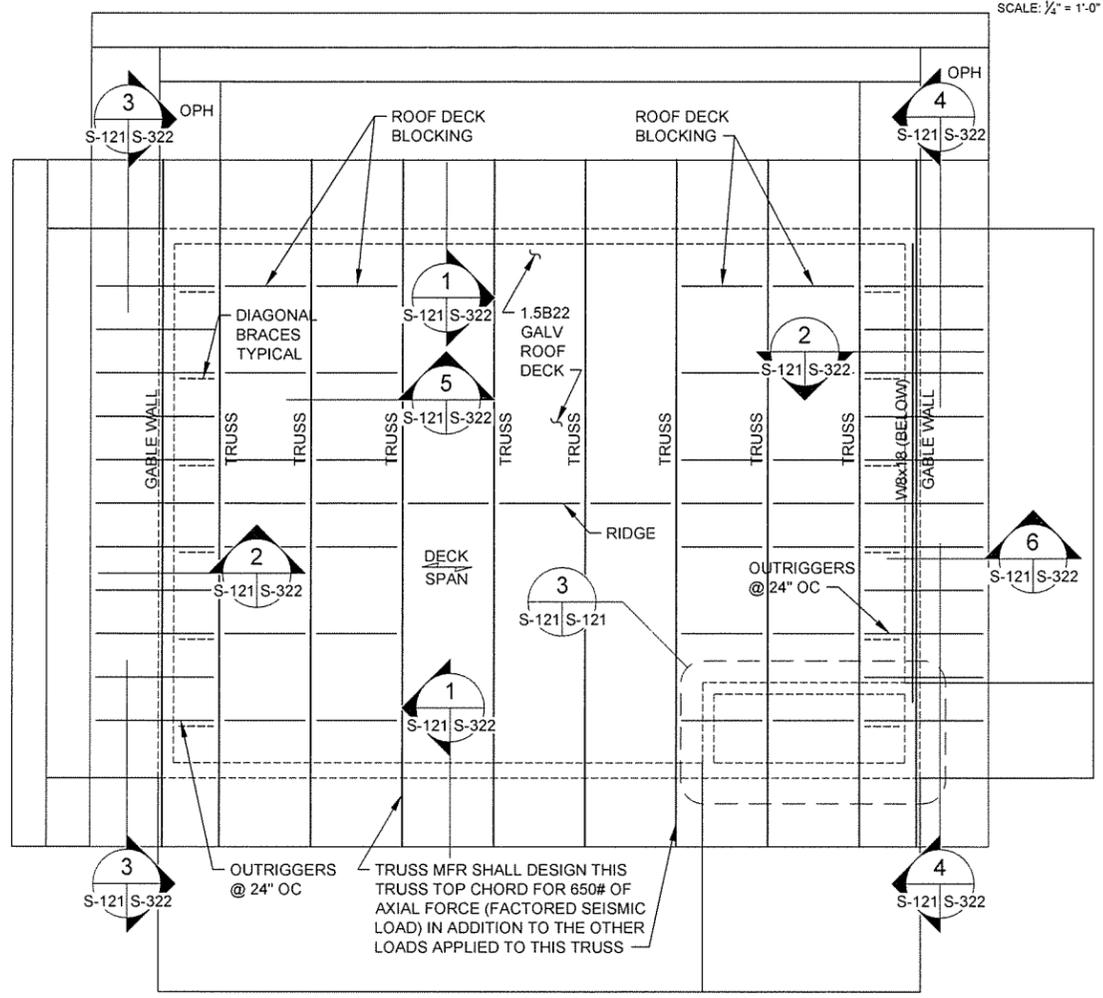


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S-121
ROOF FRAMING PLAN
SCALE: 1/4" = 1'-0"

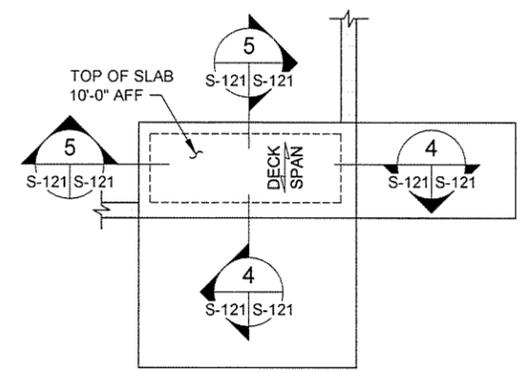



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S-121
PARTIAL PLAN
SCALE: 1/4" = 1'-0"

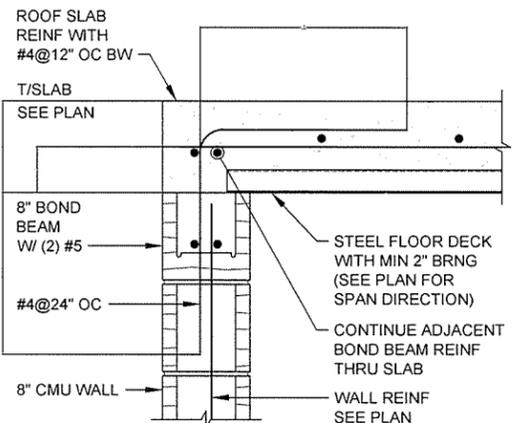

4
S-121
SECTION
SCALE: 1/2" = 1'-0"

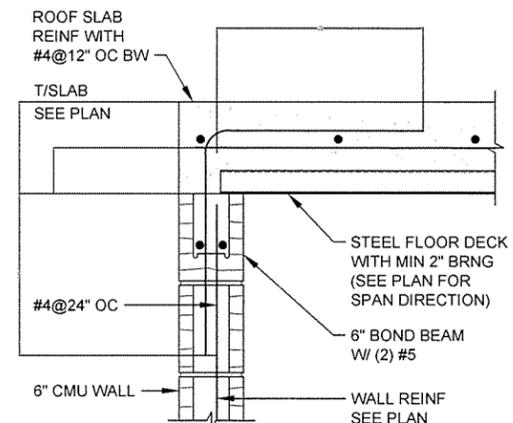

5
S-121
SECTION
SCALE: 1/2" = 1'-0"

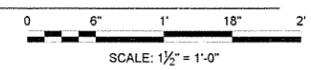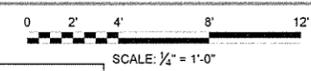

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STATE OF ARKANSAS
LICENSED PROFESSIONAL ENGINEER
No. 15642
TAYLOR CLEMENT
9/30/15

Job Number 060451	N/A	N/A	N/A
Submitted by John Walters, P.E., SE Director, Central Services	Plot Scale: 1:1	Plot Date: 9/30/15	Drwg Code: A15100R-S-121-DWG
Designed by D. CLEMENT	Drawn by S. BOWEN	Checked by G. ARCHER	File Name: A15100R-S-121-DWG
Issued For Construction	Date 10/1/15	Appr. JRR	Symbol IFC

Job Number 060451	N/A	N/A	N/A
Submitted by John Walters, P.E., SE Director, Central Services	Plot Scale: 1:1	Plot Date: 9/30/15	Drwg Code: A15100R-S-121-DWG
Designed by D. CLEMENT	Drawn by S. BOWEN	Checked by G. ARCHER	File Name: A15100R-S-121-DWG
Issued For Construction	Date 10/1/15	Appr. JRR	Symbol IFC

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JOB 061451

MAINTENANCE BUILDING
FOUNDATION AND ROOF FRAMING PLANS

Sheet Reference Number:
S-121
Sheet 83 of 130

Taylor Clement
 9/29/15

JRR
 Date 10/1/15




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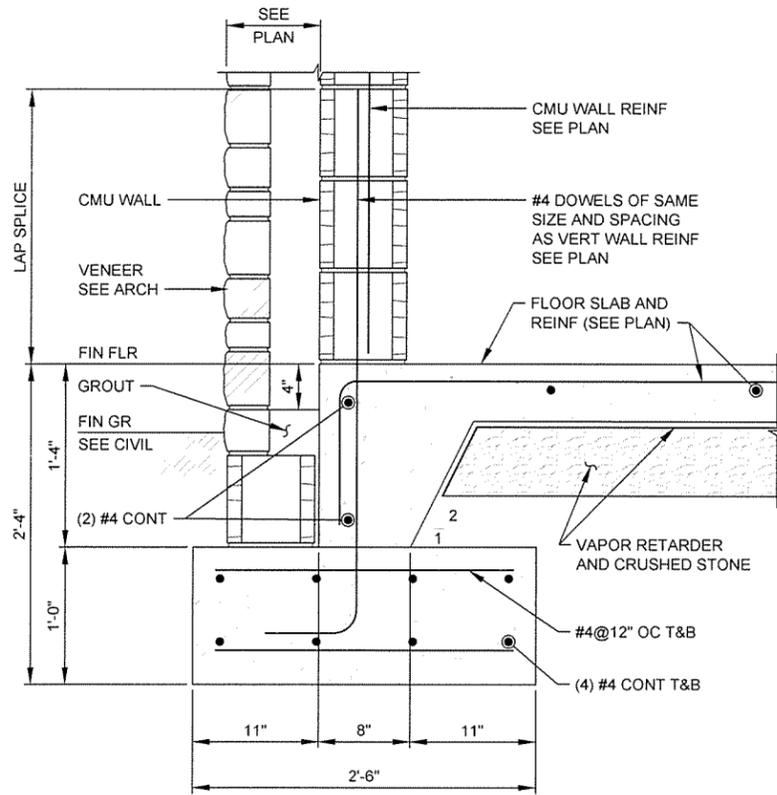
Submitted by John T. Volans, III, PE, SE Director, Federal Services	Job Number 06451
Designed by D. CLEMENT	Drawn by S. BOWEN
Checked by G. ARCHER	File Name AR15RW-S-131.DWG
Plot Date 9/30/15	Plot Scale 1:1
Drng Code	
N/A	N/A
N/A	N/A

ARKANSAS HIGHWAY AND TRANSPORTATION DEPARTMENT
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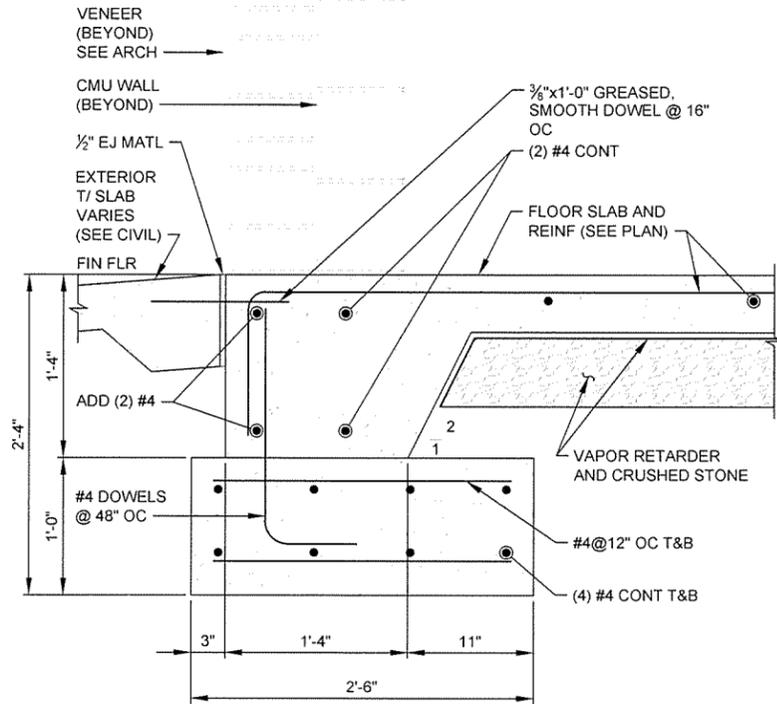
TRUCKER-VENDING BUILDING
 FOUNDATION AND ROOF FRAMING PLANS

Sheet Reference Number:
S-131
 Sheet 84 of 130




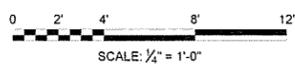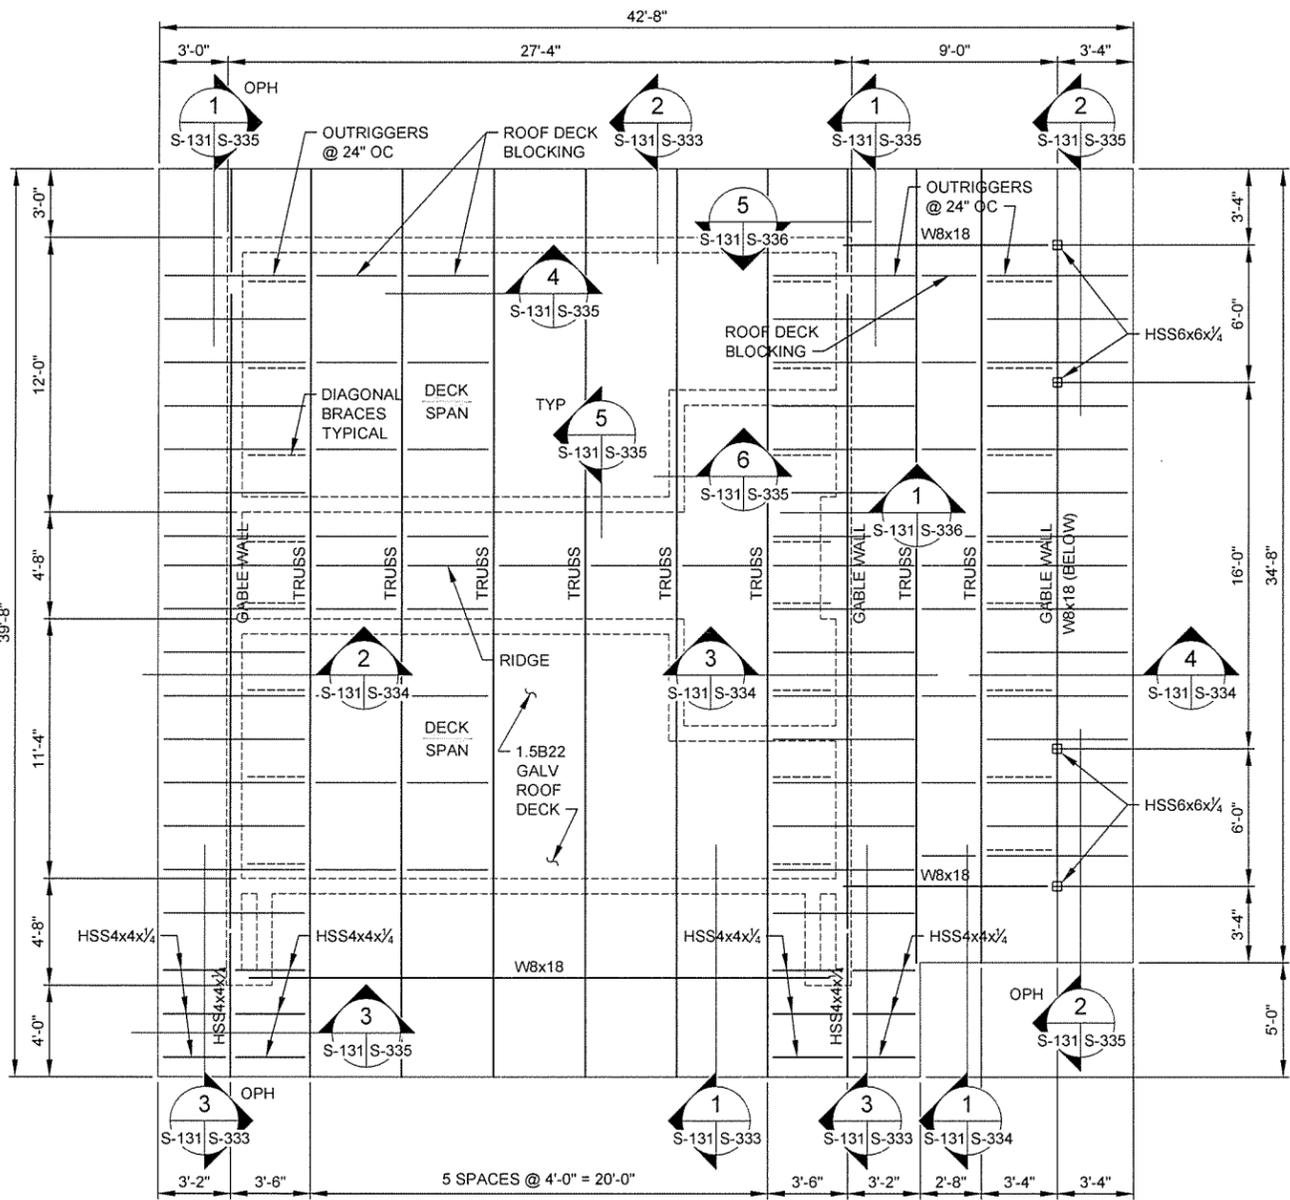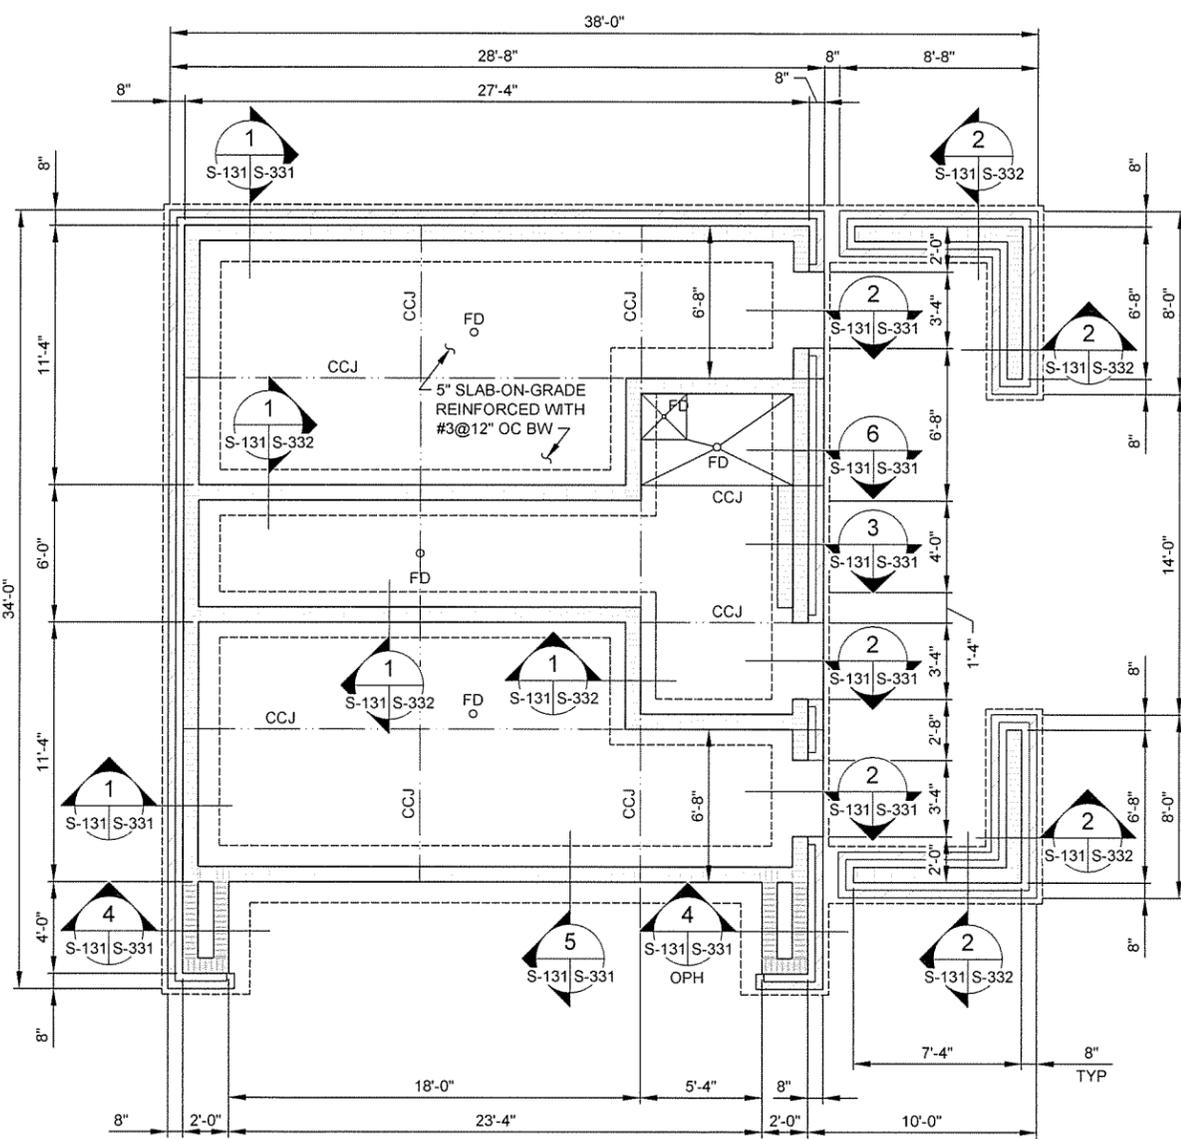


SECTION 1
S-101|S-301 SCALE: 1 1/2" = 1'-0"




SECTION 2
S-101|S-301 SCALE: 1 1/2" = 1'-0"

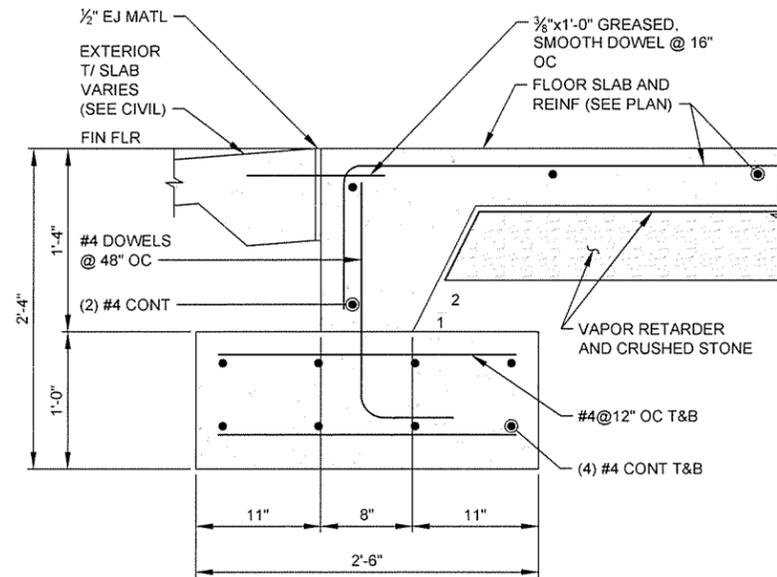


SECTION 3
S-101|S-301 SCALE: 1 1/2" = 1'-0"

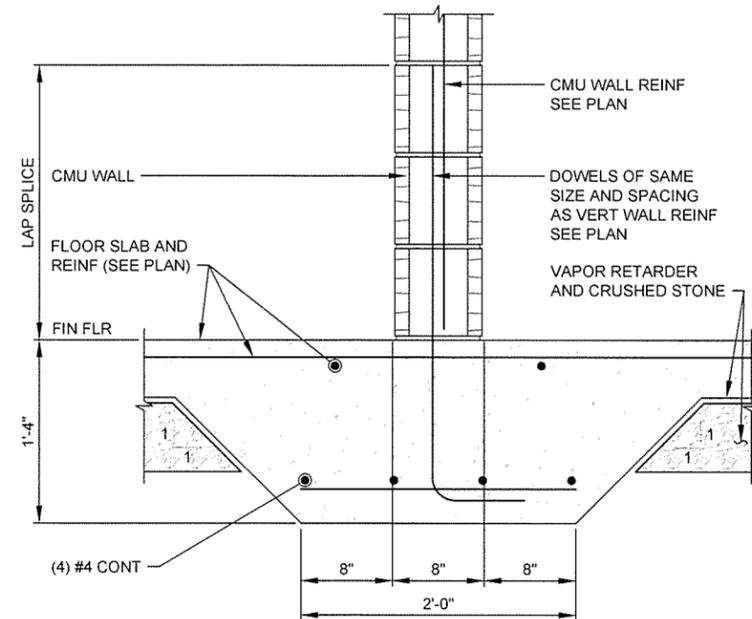

SECTION 4
S-101|S-301 SCALE: 1 1/2" = 1'-0"

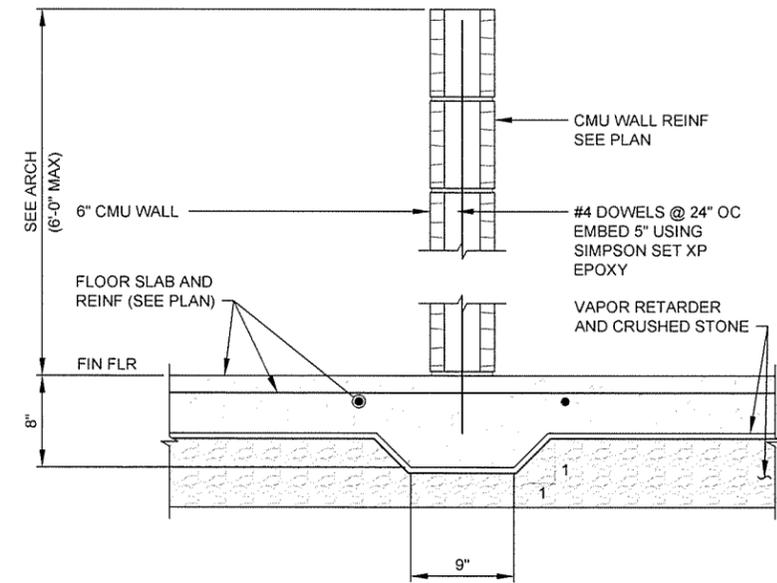

SECTION 5
S-101|S-301 SCALE: 1 1/2" = 1'-0"

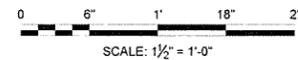

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STATE OF ARKANSAS
LICENSED PROFESSIONAL ENGINEER
No. 15842
D. TAYLOR CLEMENT
9/30/15



JRR	Appr.
10/1/15	Date
ISSUED FOR CONSTRUCTION	Description
IPC	Symbol

Submitted by John T. Watkins, III, PE, SE Director, Federal Services	Job Number 060451	Drawn by S. BOWEN	Plot Date 9/30/15	Play Scale 1:1	Dwg Code N/A	File Name A115WFS-S-301.DWG
Designed by D. CLEMENT	Checked by G. ARCHER	N/A	N/A	N/A	N/A	


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TOURIST INFORMATION CENTER
FOUNDATION SECTIONS


Sheet Reference Number:
S-301
Sheet 85 of 130

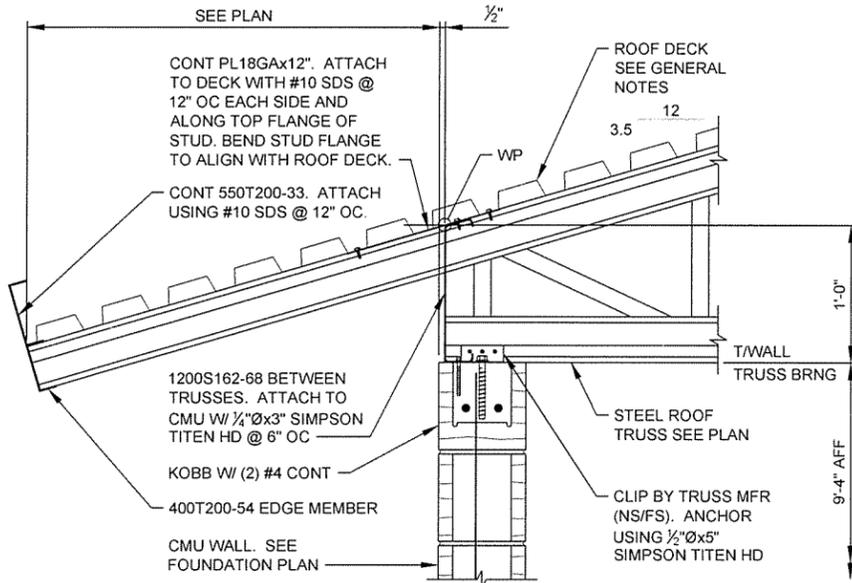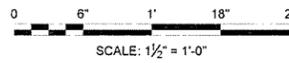


SECTION 1
S-102 | S-302 SCALE: 1 1/2" = 1'-0"

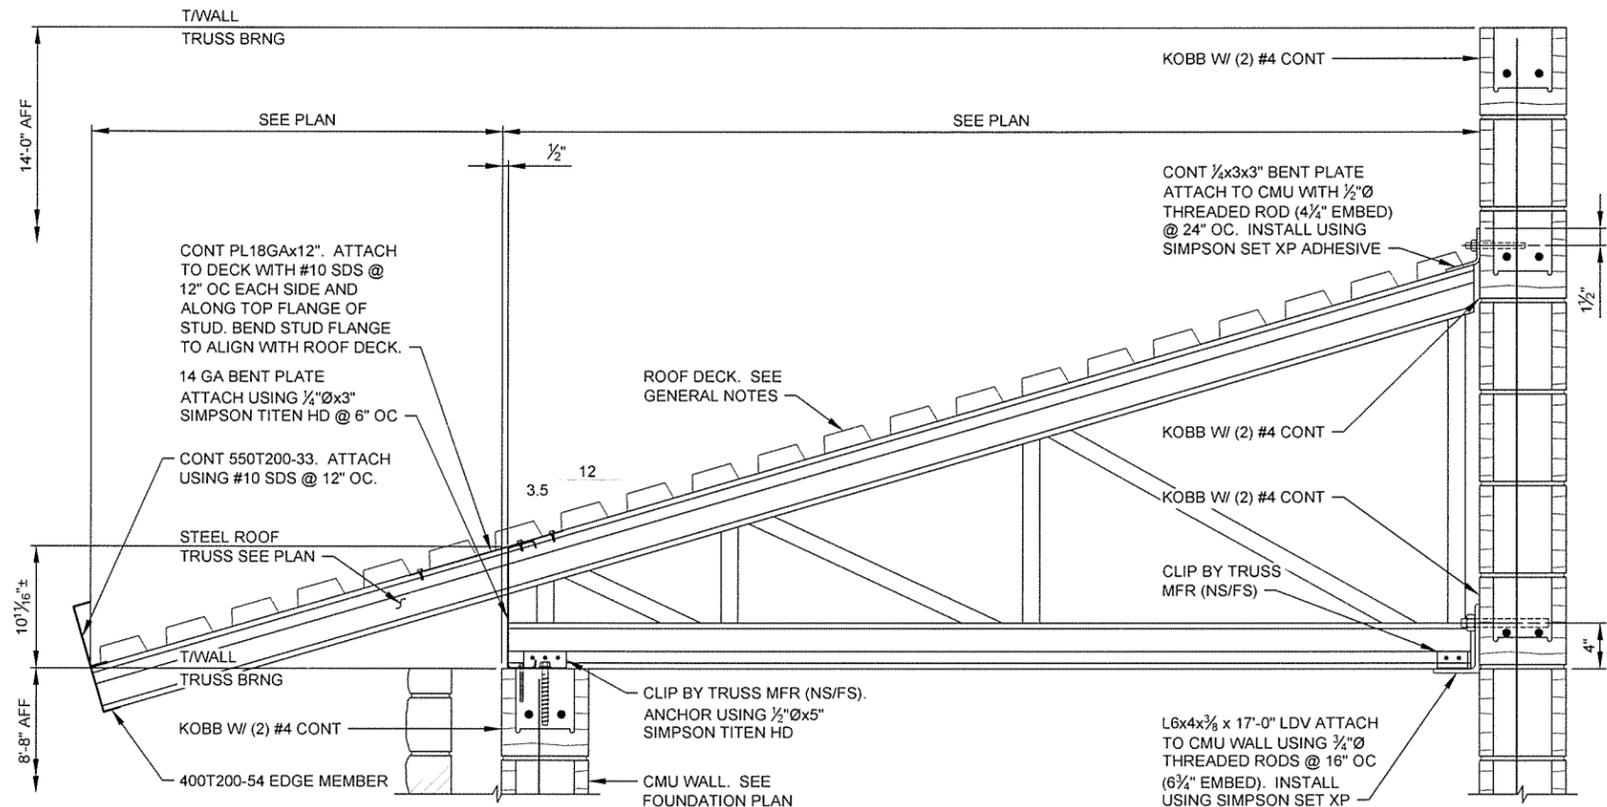

SECTION 2
S-102 | S-302 SCALE: 1 1/2" = 1'-0"

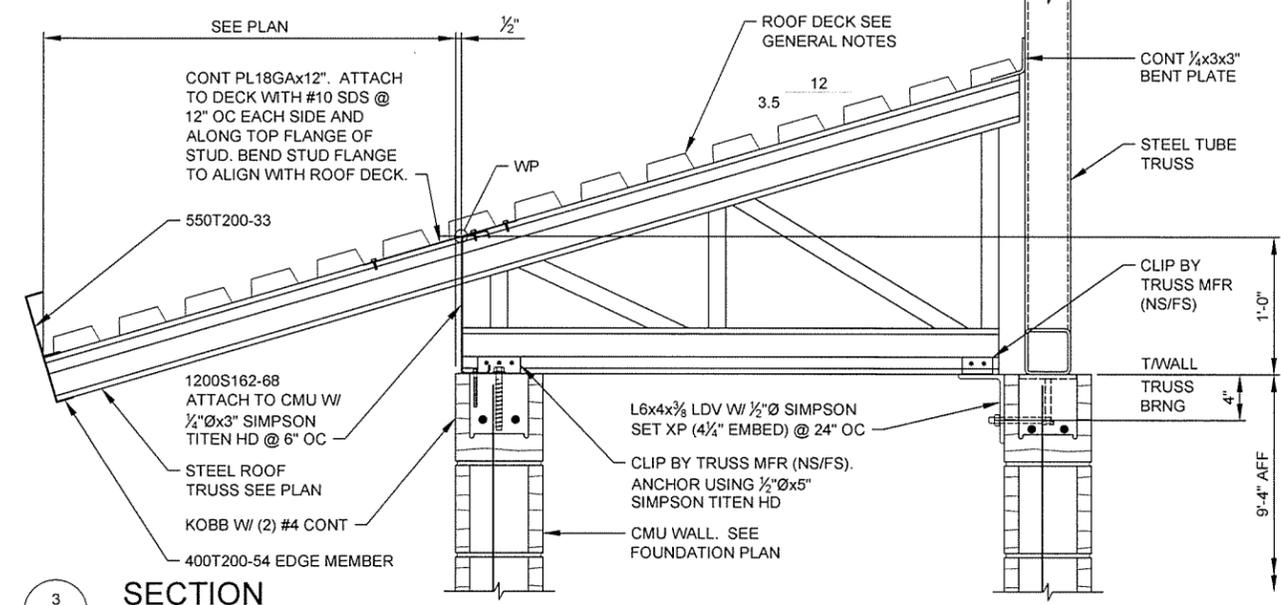

SECTION 3
S-102 | S-302 SCALE: 1 1/2" = 1'-0"

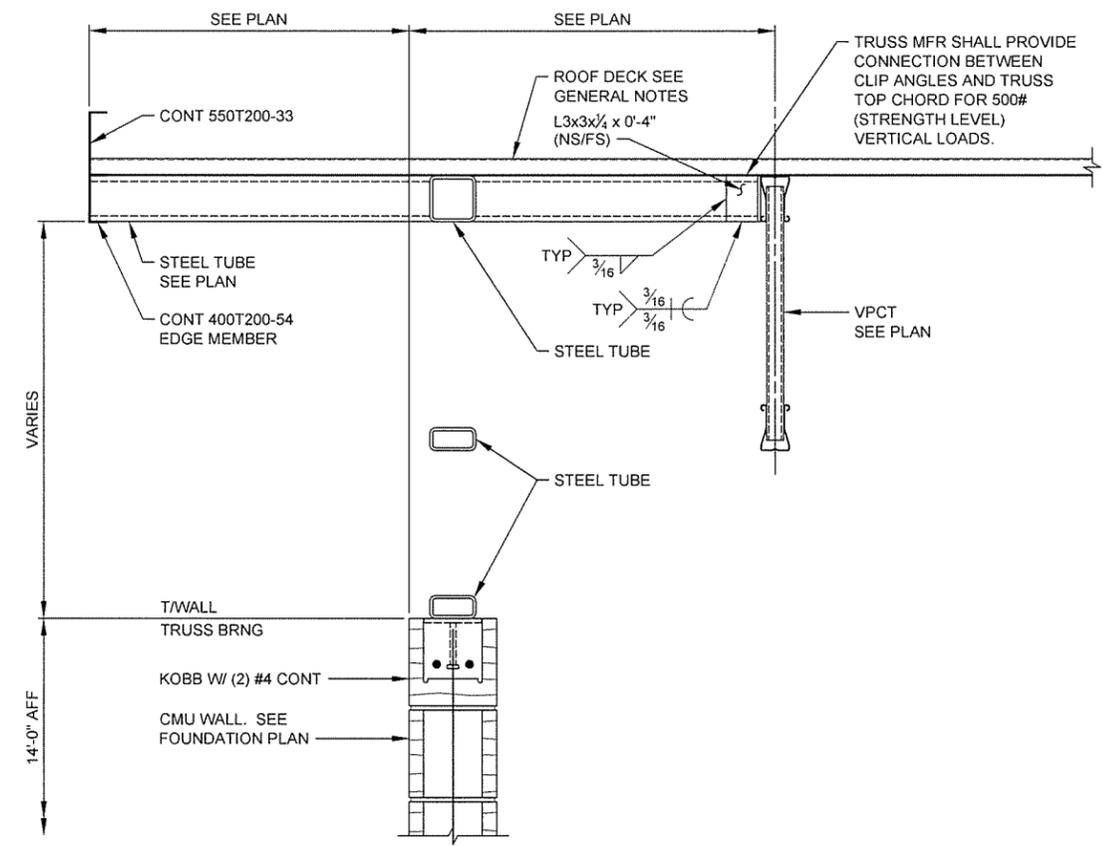

SECTION 4
S-102 | S-302 SCALE: 1 1/2" = 1'-0"




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LICENSED PROFESSIONAL ENGINEER
D. TAYLOR CLEMENT
No. 15642
9/30/15

JRR	Appr.
10/1/15	Date
ISSUED FOR CONSTRUCTION	Description
IPC	Symbol

Job Number	060451	N/A	N/A	N/A
Submitted by	John T. Watkins, III, PE, SE Director, Federal Services	Plot Date	9/30/15	Dwg Code
Designed by	D. CLEMENT	Plot Scale	1:1	
Drawn by	S. BOWEN	Checked by	G. ARCHER	File Name
				AH15WFLS-302.DWG

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JOB 061451


TOURIST INFORMATION CENTER
FRAMING SECTIONS

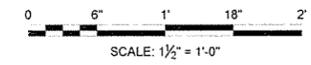


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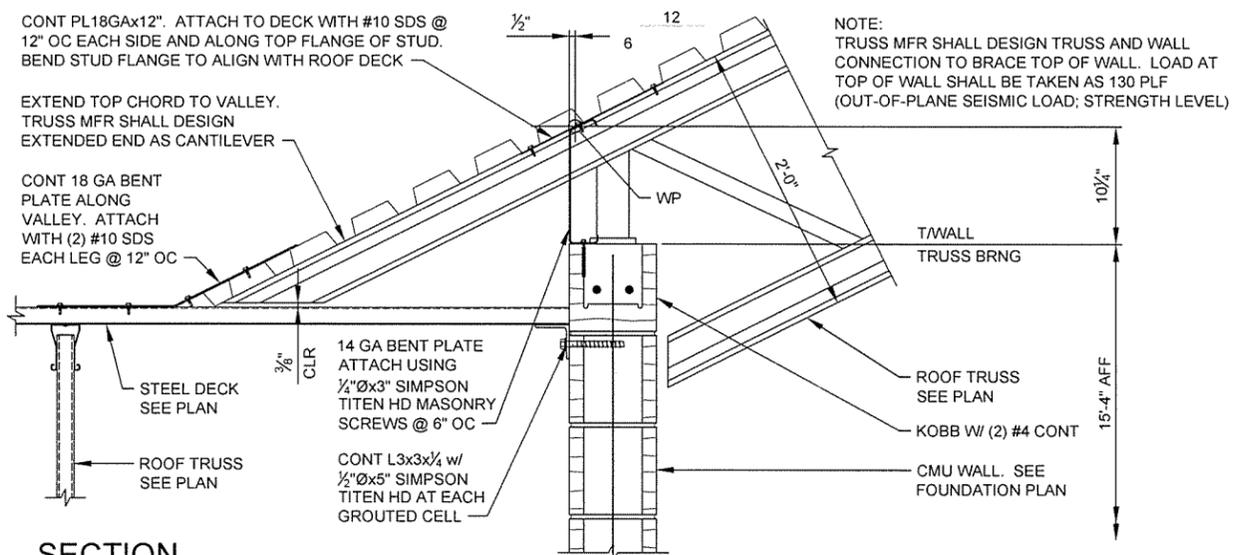
Handwritten signature: Taylor Clement
TAYLOR CLEMENT
 LICENSED PROFESSIONAL ENGINEER
 No. 15642
 9/30/15




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 S-102 | S-303 SCALE: 1 1/2" = 1'-0"

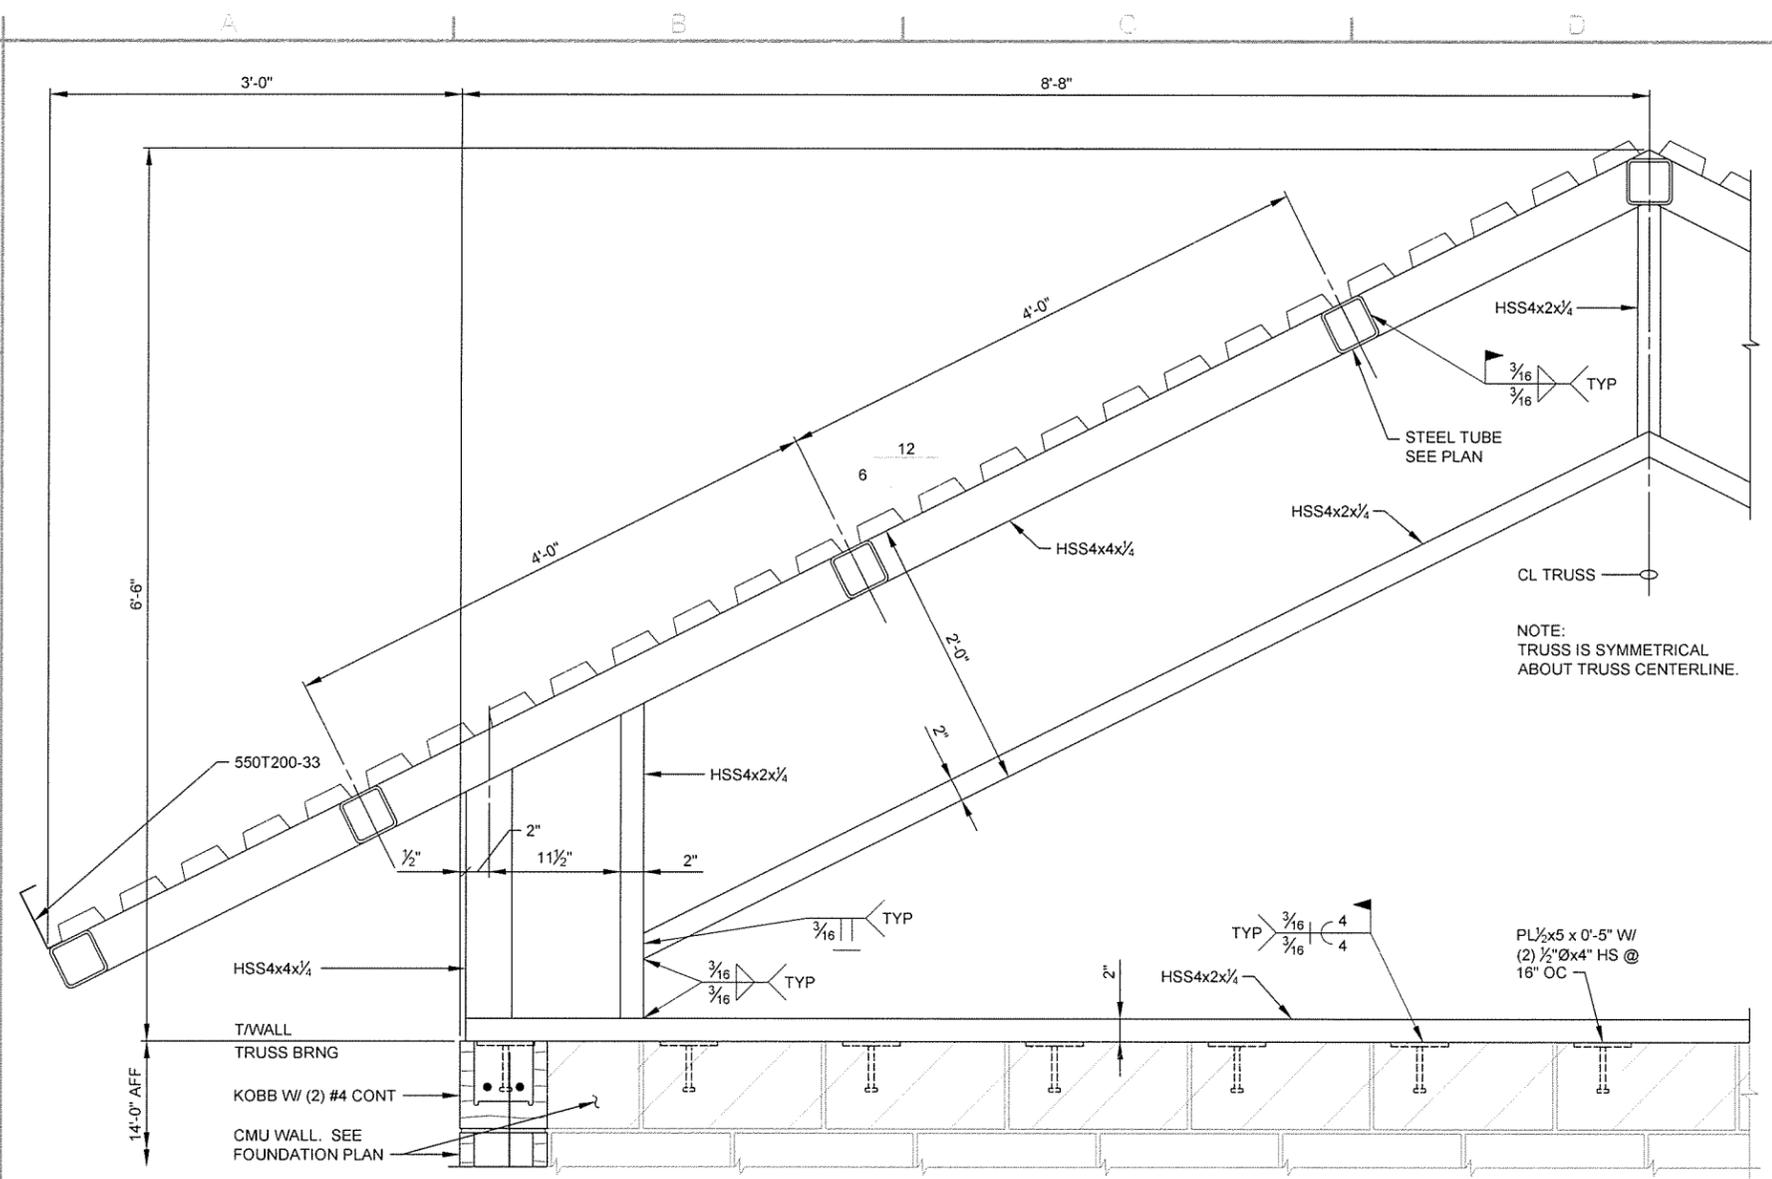

SECTION 2
 S-102 | S-303 SCALE: 1 1/2" = 1'-0"

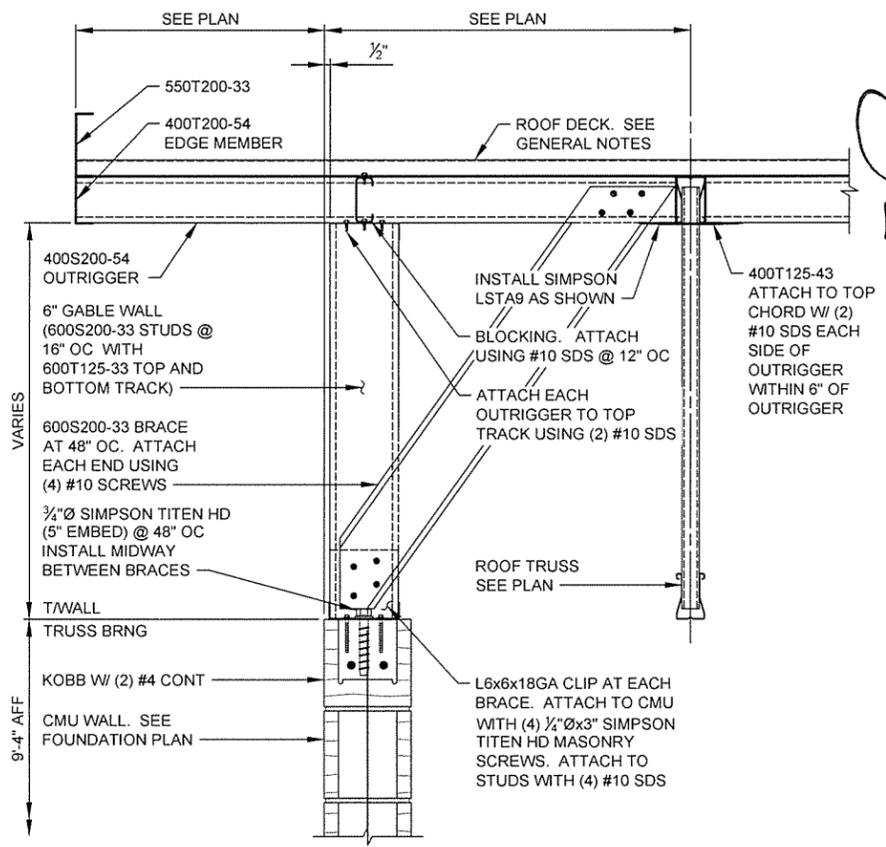






SECTION 3
 S-102 | S-303 SCALE: 1 1/2" = 1'-0"

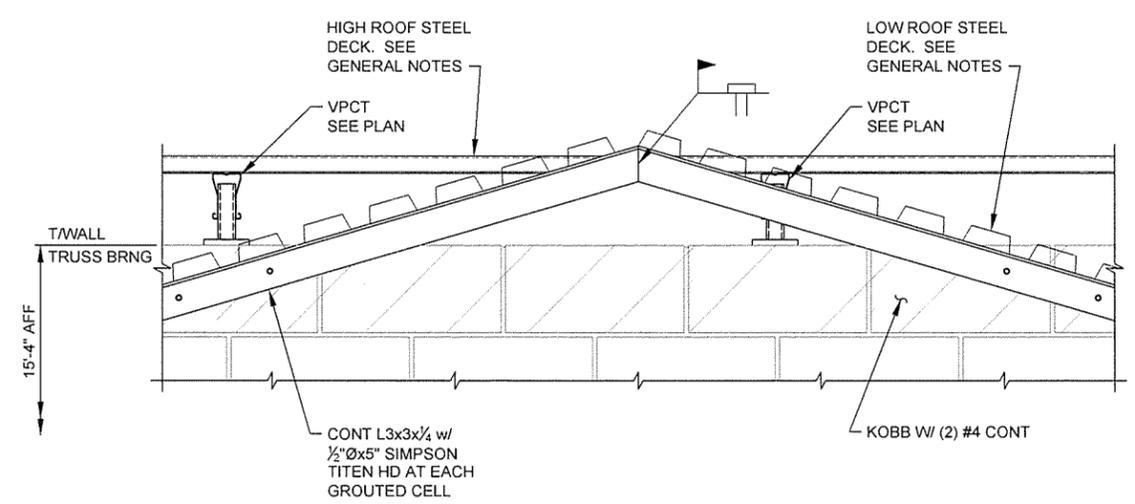

SECTION 4
 S-102 | S-303 SCALE: 1 1/2" = 1'-0"

Submitted by John T. Vebans, III, PE, SE Director, Federal Services	Job Number 060451	N/A	N/A	N/A
Designed by D. CLEMENT	Plot Date 9/30/15	Plot Scale 11	Draw Code 11	File Name ARHSWR-S-303.DWG
Drawn by S. BOWEN	Checked by G. ARCHER			

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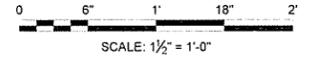
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10/1/15	Date
ISSUED FOR CONSTRUCTION	Description
IFC	Symbol

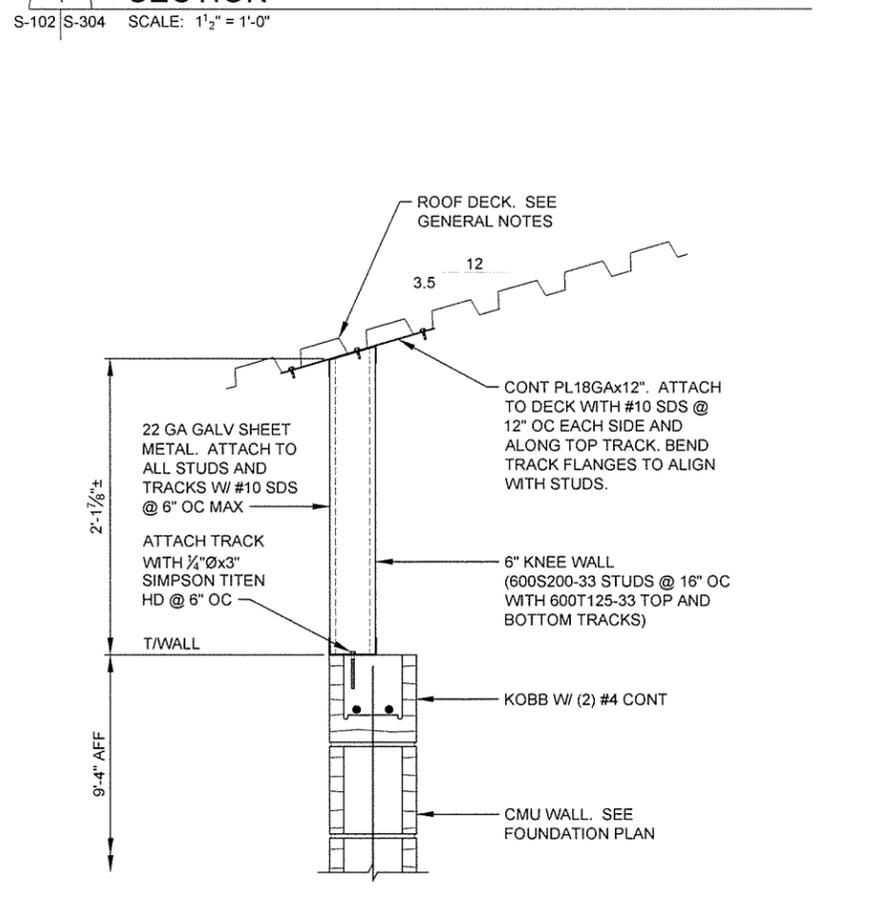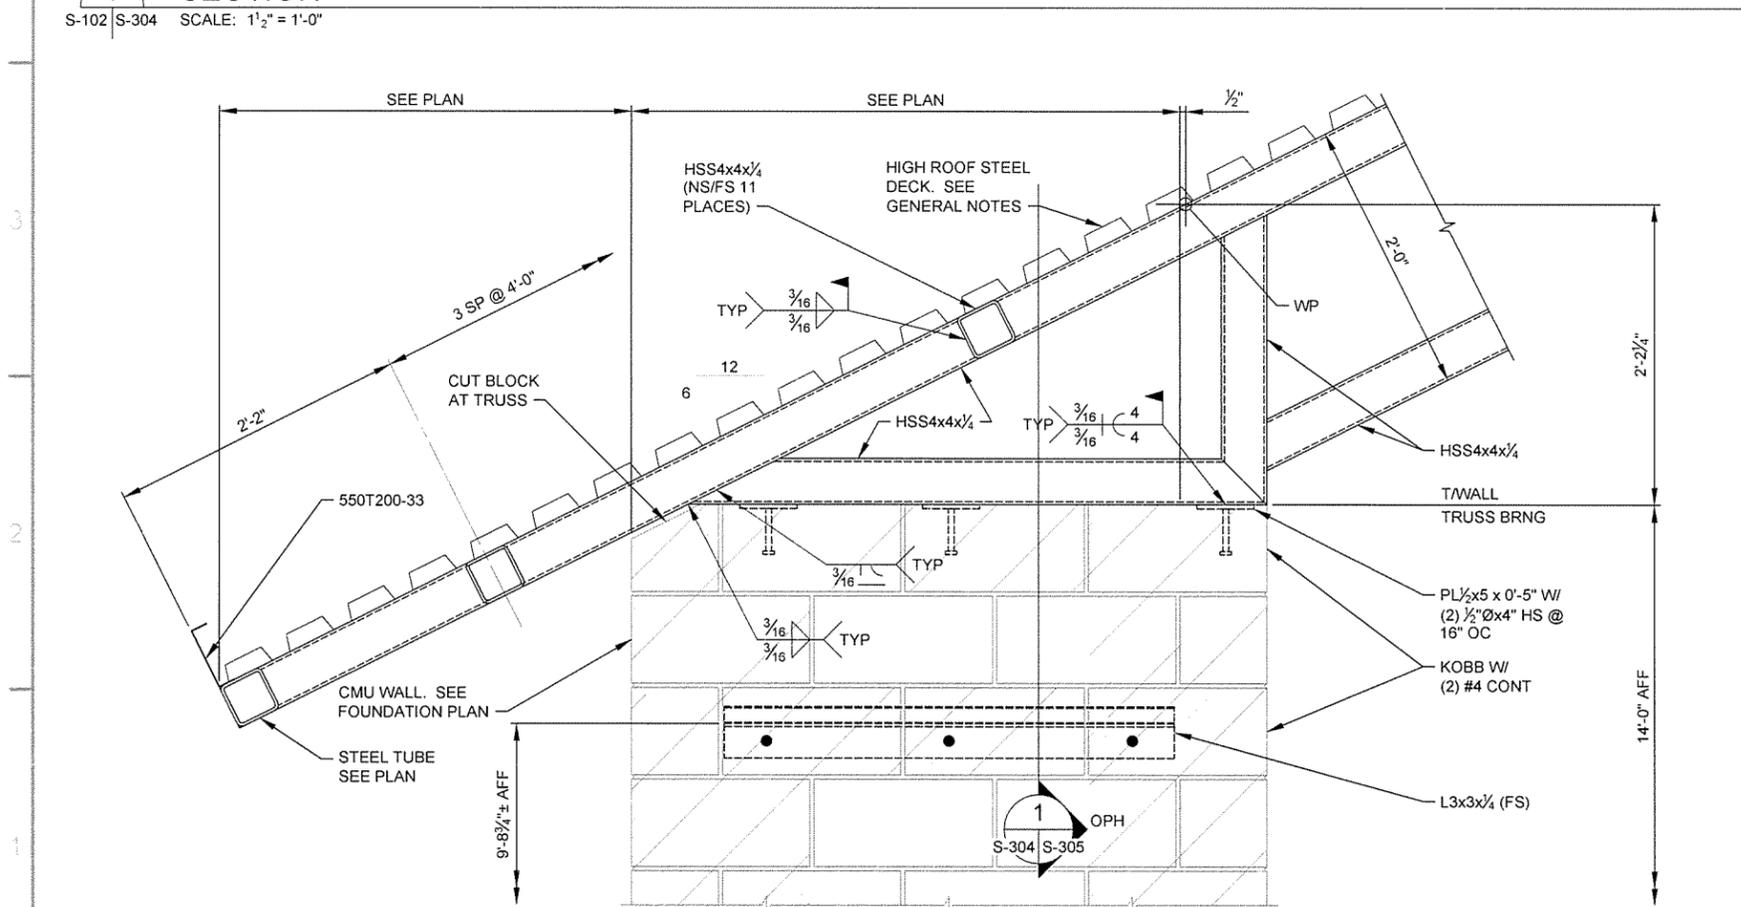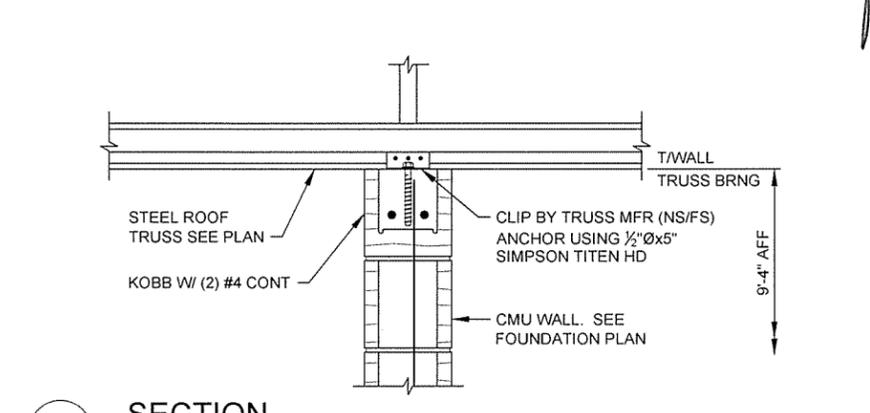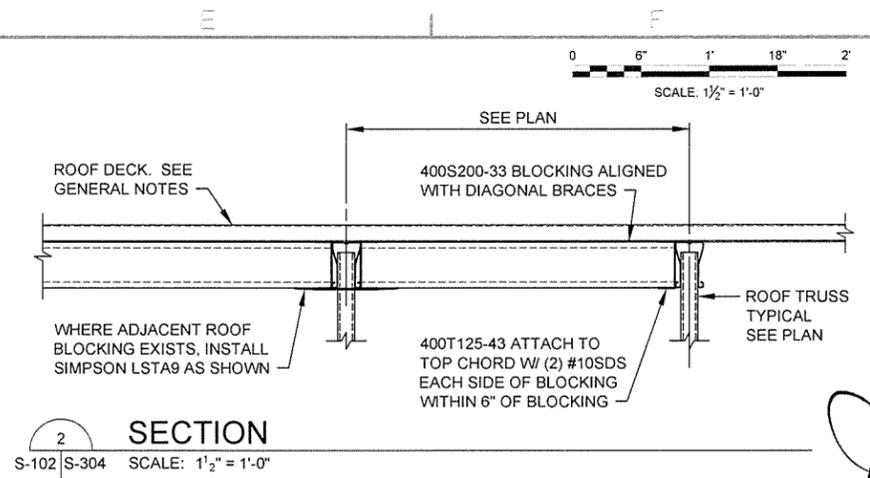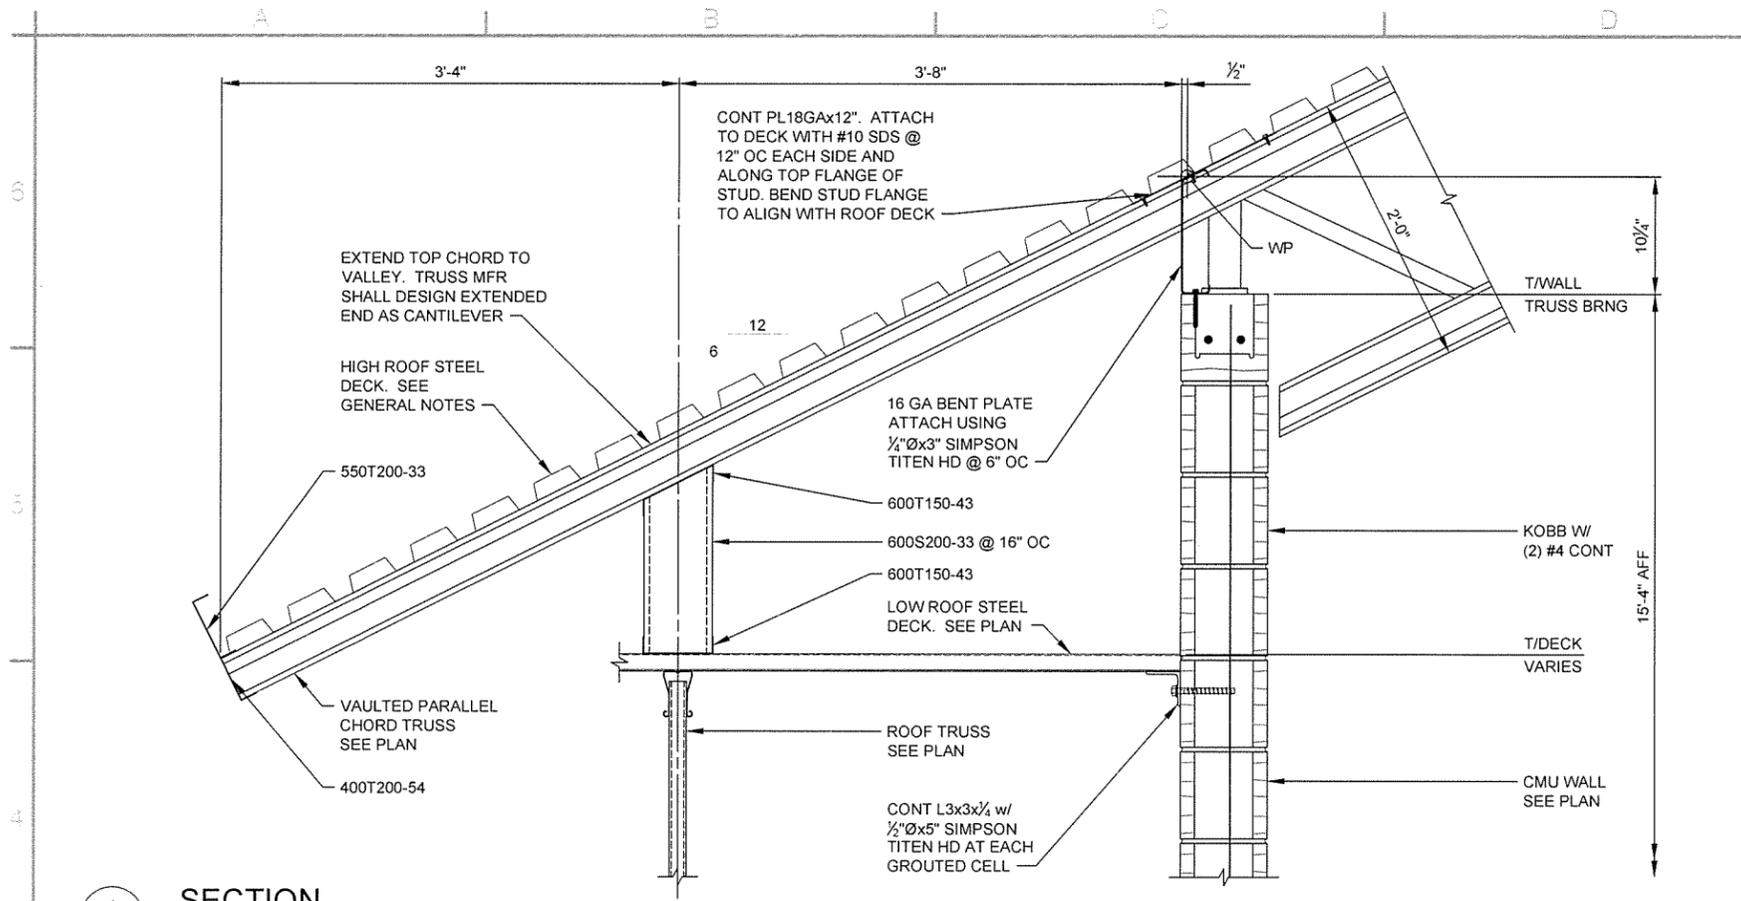Job Number 060451	N/A	N/A	N/A
Submitted by John T. Valens, III, PE, SE Director, Federal Services	Plot Date 9/30/15	Plot Scale 1:1	Dwg Code
Designed by J. RAMSEY	Drawn by J. DEMAREE	Checked by G. ARCHER	File Name AHS15WRS-304-DWG

ARKANSAS HIGHWAY AND TRANSPORTATION DEPARTMENT
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TOURIST INFORMATION CENTER
FRAMING SECTIONS

Sheet Reference Number:
S-304
Sheet 88 of 130



9/30/15

JRR
Date 10/1/15


ISSUED FOR CONSTRUCTION
Description
IFC Symbol

Designed by D. CLEMENT	Submitted by John T. Valerius, III, PE, SE Director, Federal Services	Job Number 000451	N/A	N/A	N/A
Drawn by S. BOWEN	Plot Date 9/30/15	Plot Scale 1:1	1:1	1:1	1:1
Checked by G. ARCHER	Draw Code				
File Name AHS13WR-S-305.DWG					


ARKANSAS HIGHWAY AND TRANSPORTATION DEPARTMENT
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TOURIST INFORMATION CENTER
FRAMING SECTIONS


Sheet Reference Number:
S-305
Sheet 89 of 130

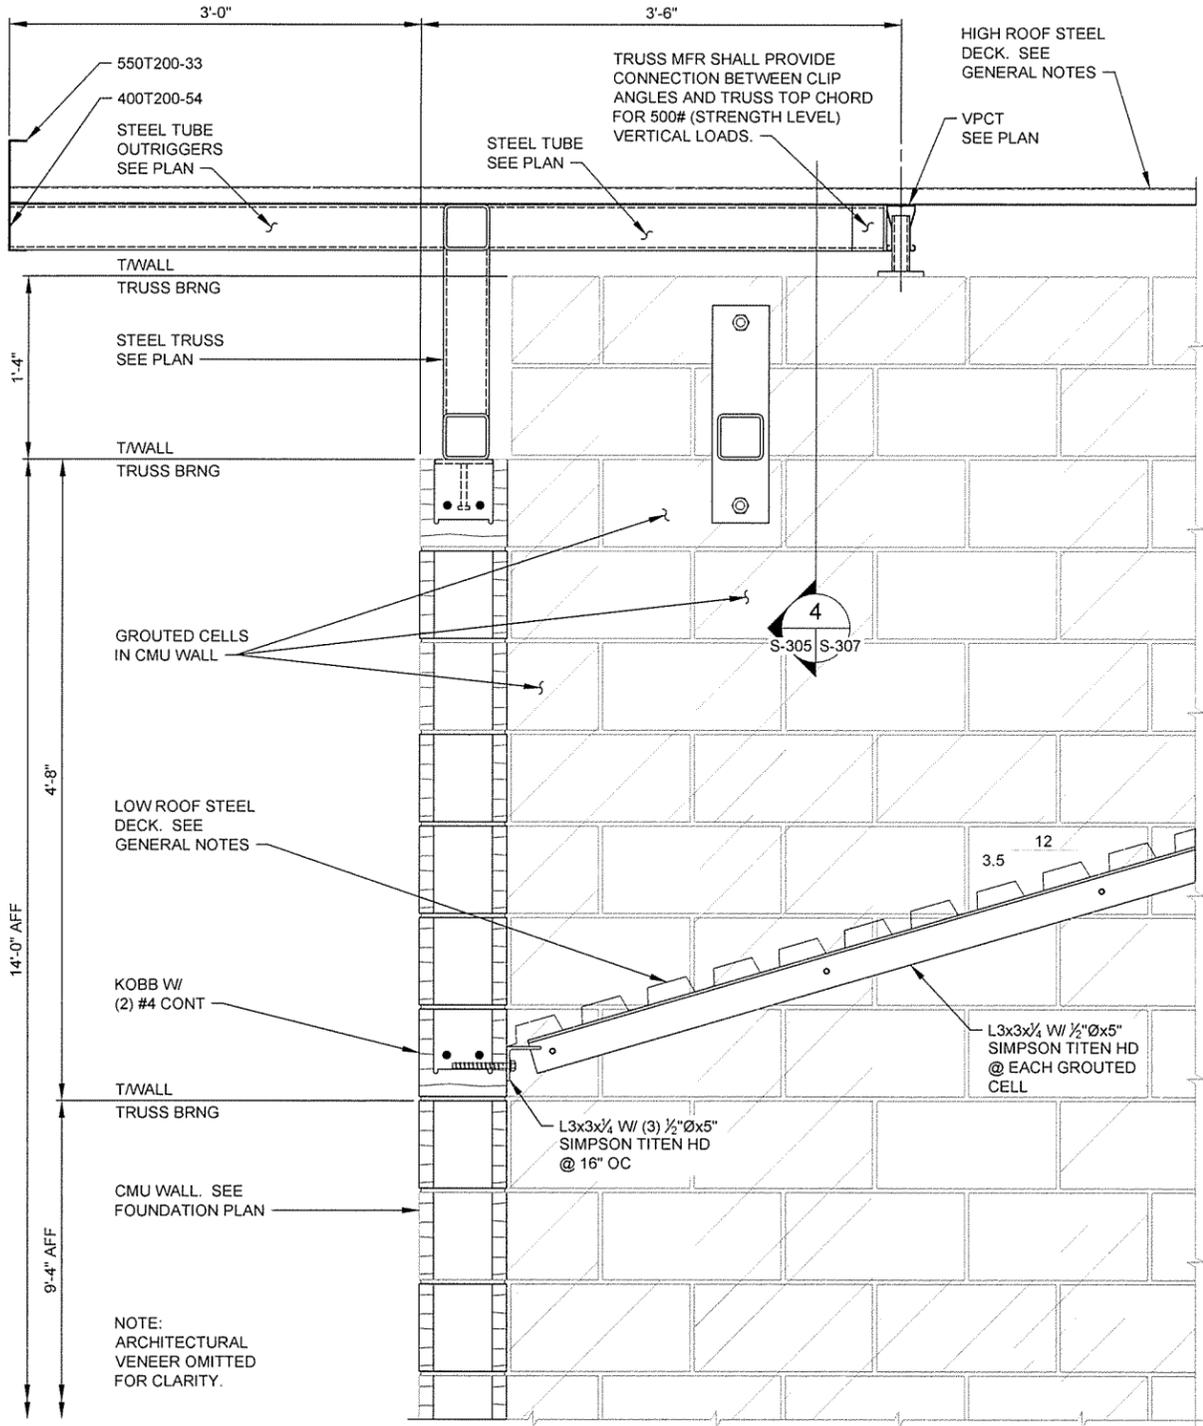

SECTION 1
S-102 | S-305 SCALE: 1 1/2" = 1'-0"

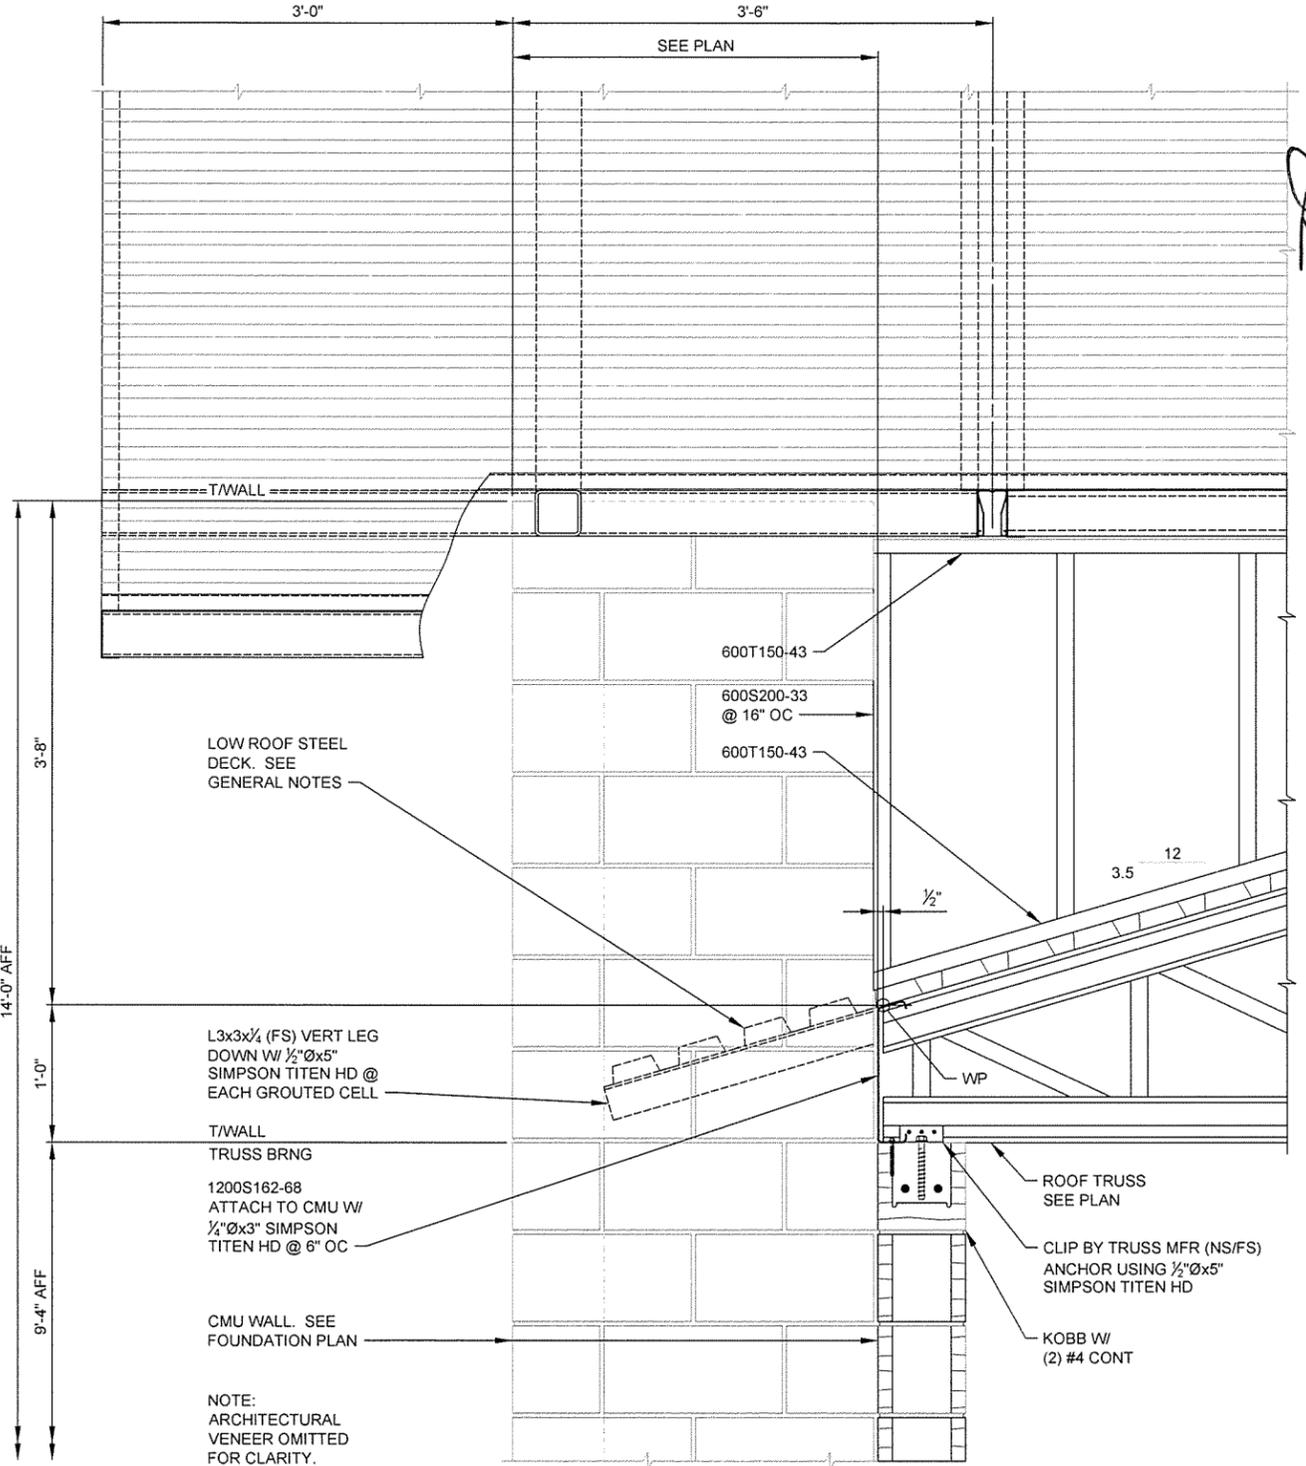

SECTION 2
S-102 | S-305 SCALE: 1 1/2" = 1'-0"

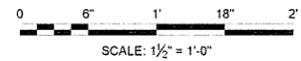

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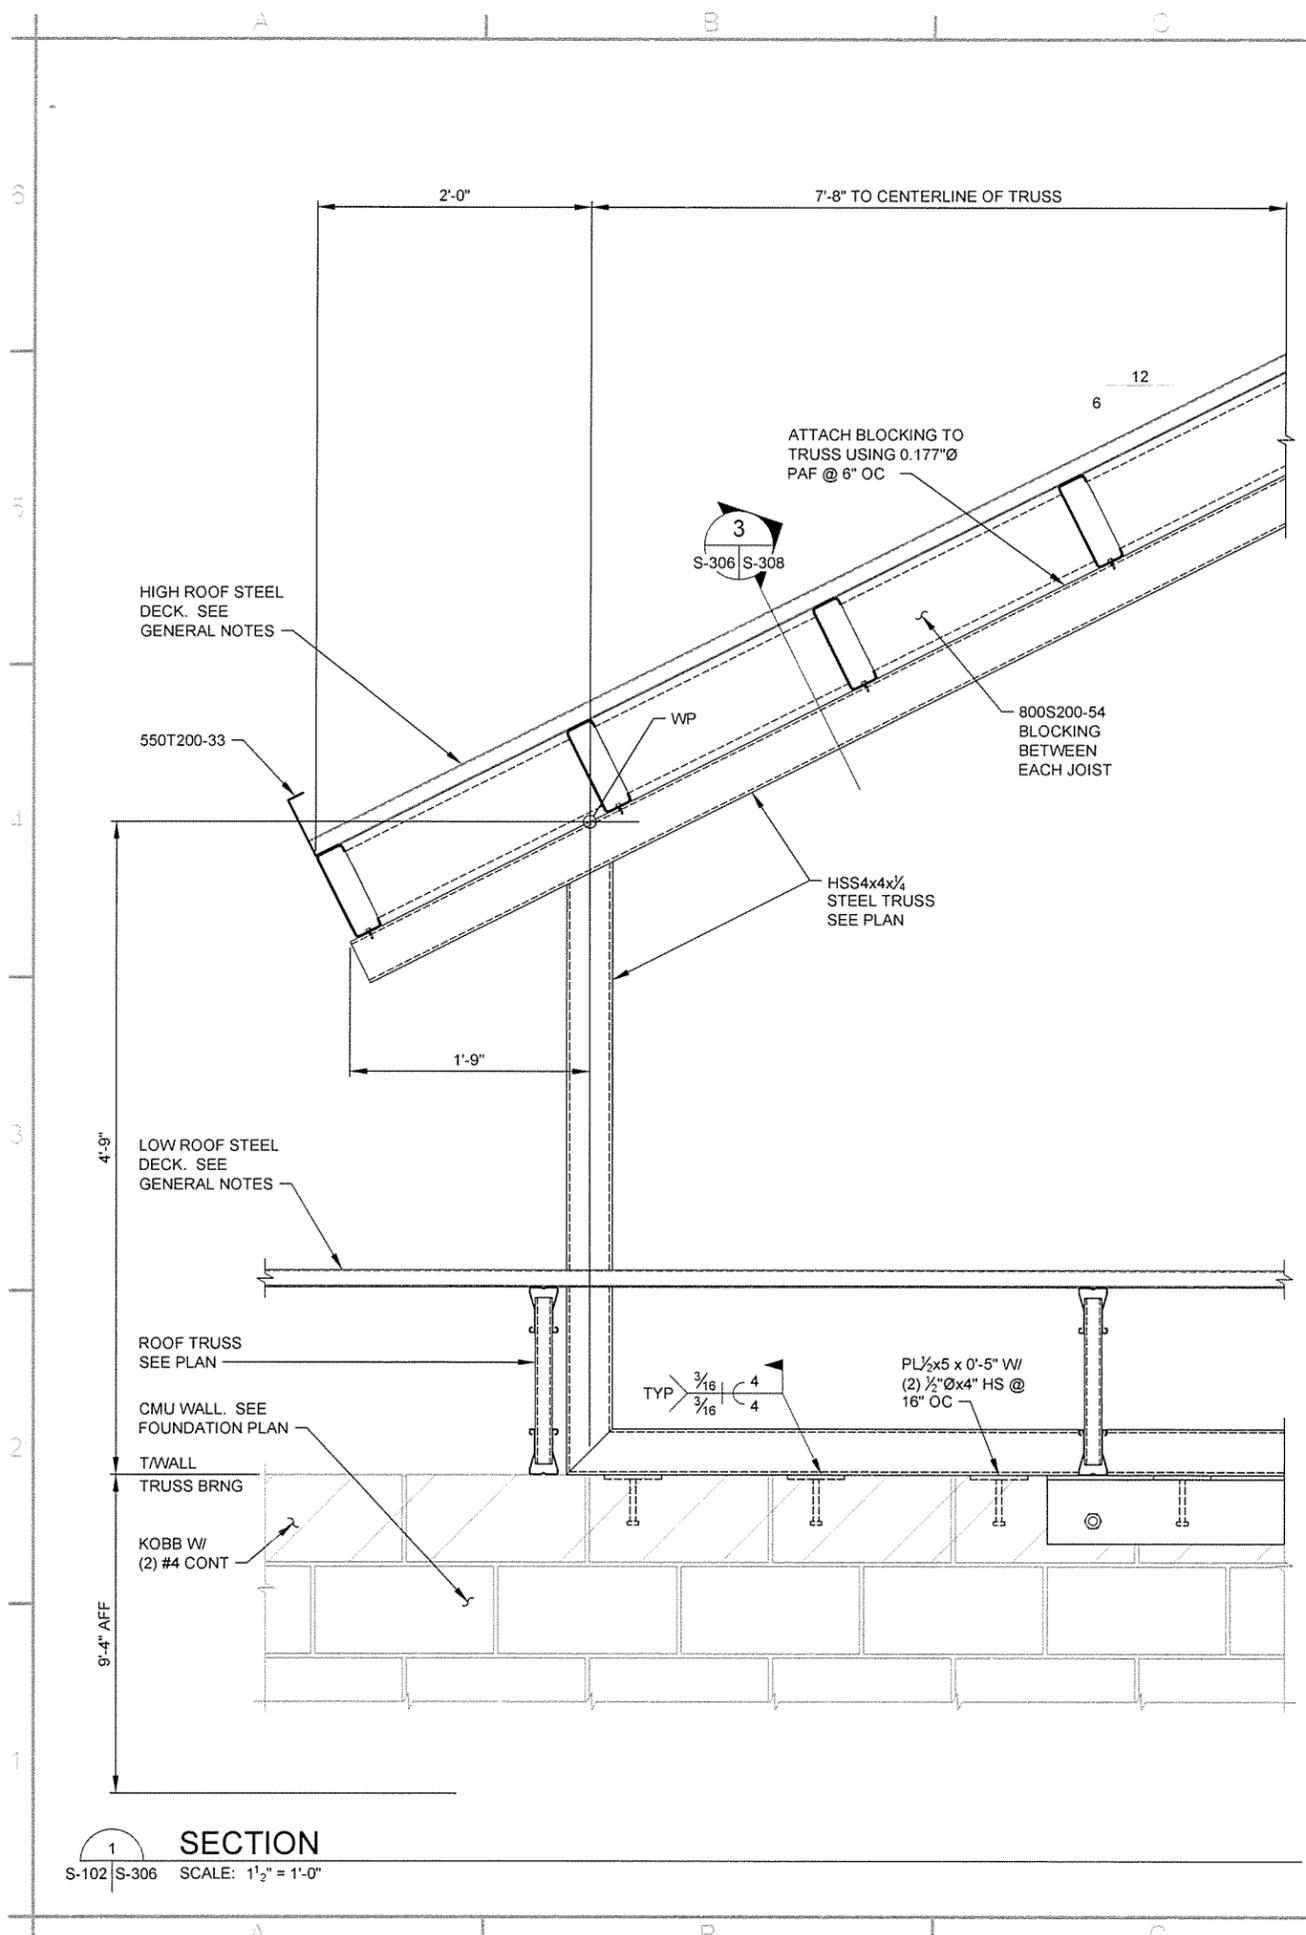
ISSUED FOR CONSTRUCTION
 Description
 IFC
 Symbol

Designed by D. CLEMENT	Submitted by John T. Watkins, III, PE, SE Director, Federal Services	Job Number 080451	N/A	N/A	N/A
Drawn by S. BOWEN	Plot Date 9/30/15	Plot Scale 1:1			
Checked by G. ARCHER	Dwg Code				
File Name AHT15WRS-306.DWG					


ARKANSAS HIGHWAY AND TRANSPORTATION DEPARTMENT
 ARKANSAS TOURIST INFORMATION CENTER
 (WHITE RIVER) (S)
 JOB 081451

TOURIST INFORMATION CENTER
 FRAMING SECTIONS



Sheet Reference Number:
S-306
 Sheet 90 of 130




SECTION 1
 S-102 | S-306 SCALE: 1 1/2" = 1'-0"

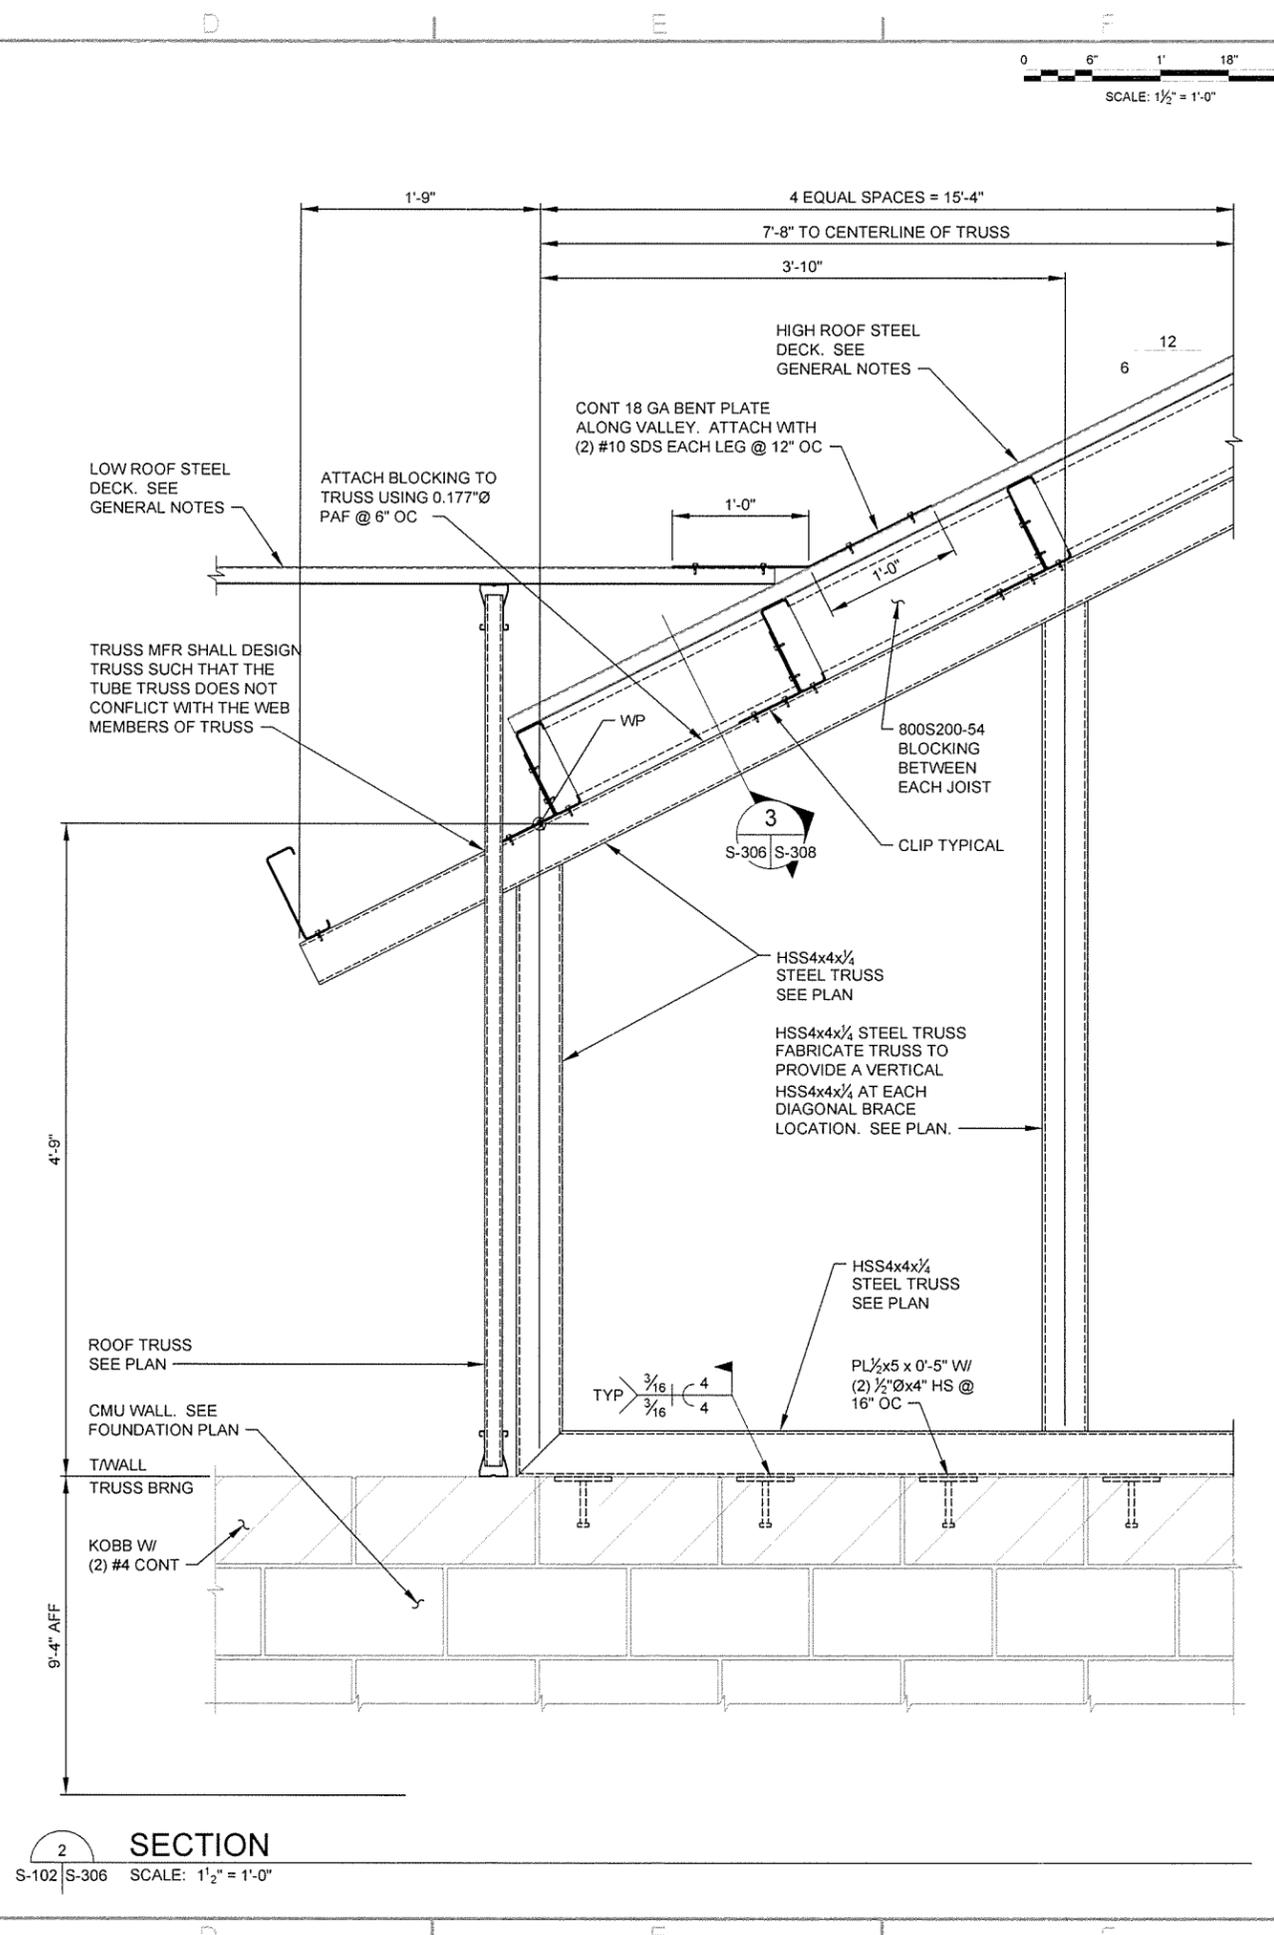


SECTION 2
 S-102 | S-306 SCALE: 1 1/2" = 1'-0"

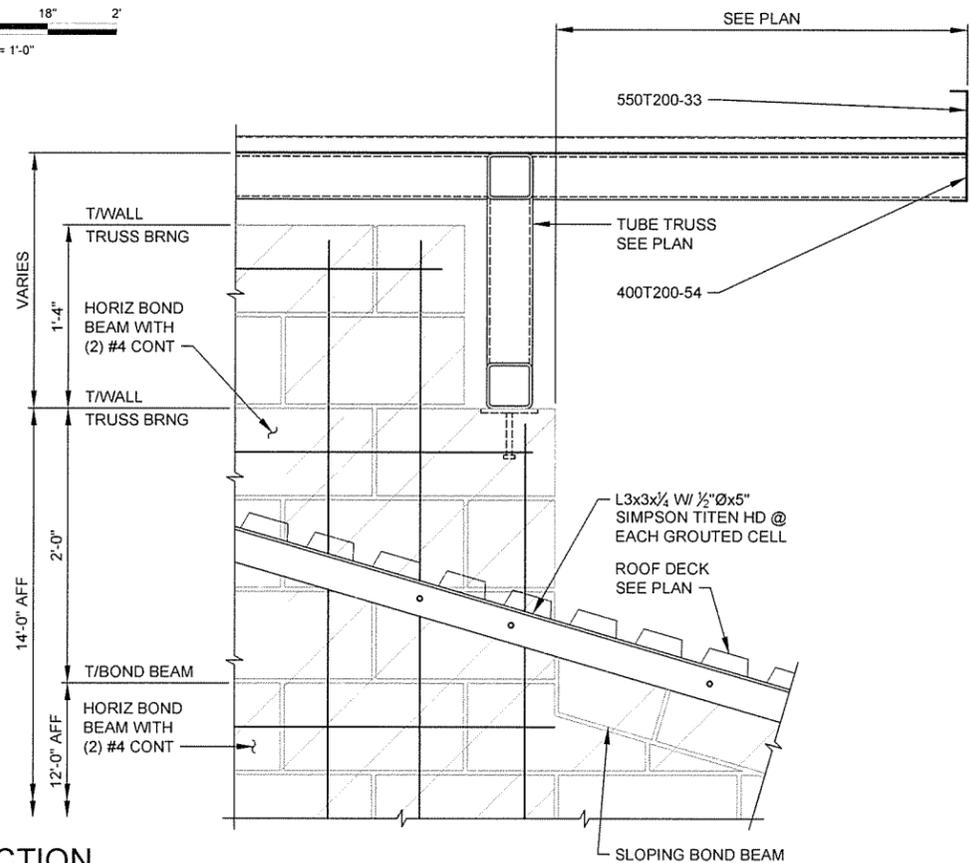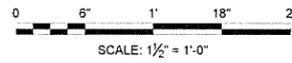


SECTION 1
S-102/S-307 SCALE: 1 1/2" = 1'-0"

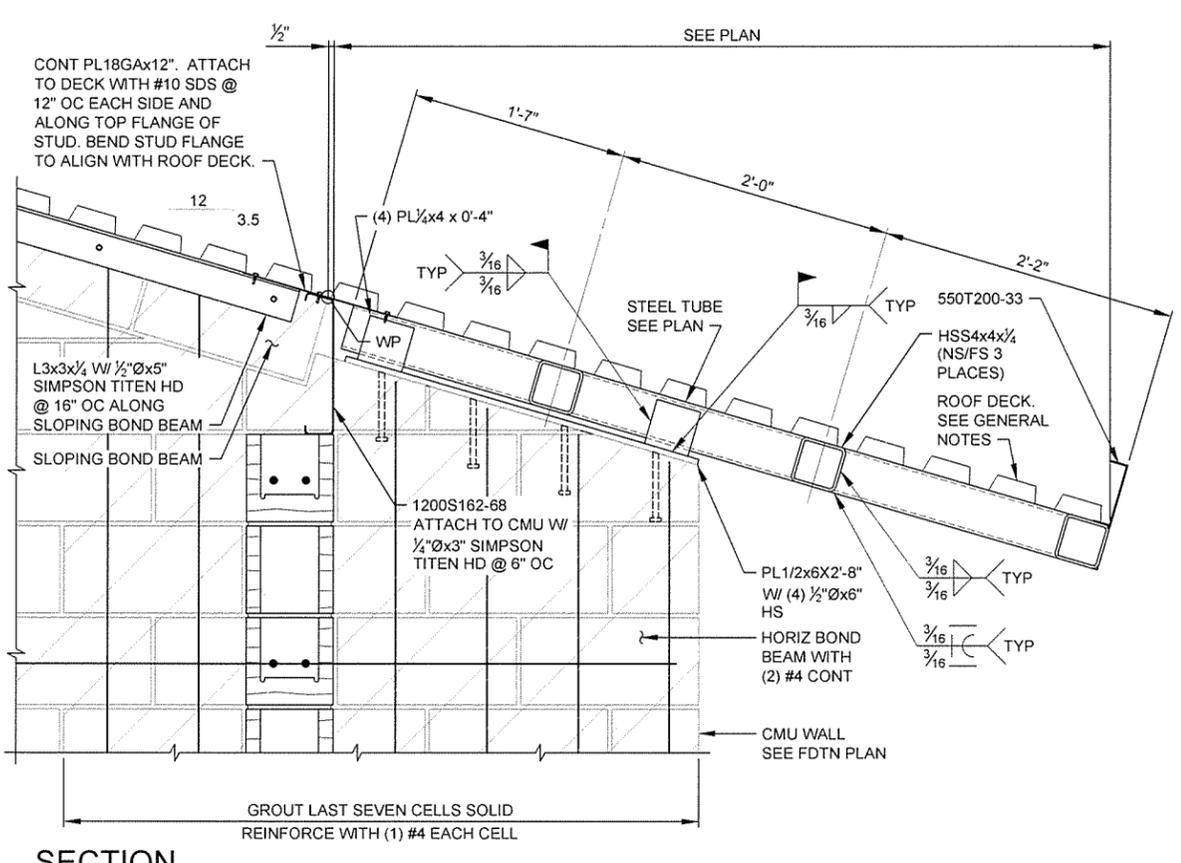

SECTION 2
S-102/S-307 SCALE: 1 1/2" = 1'-0"

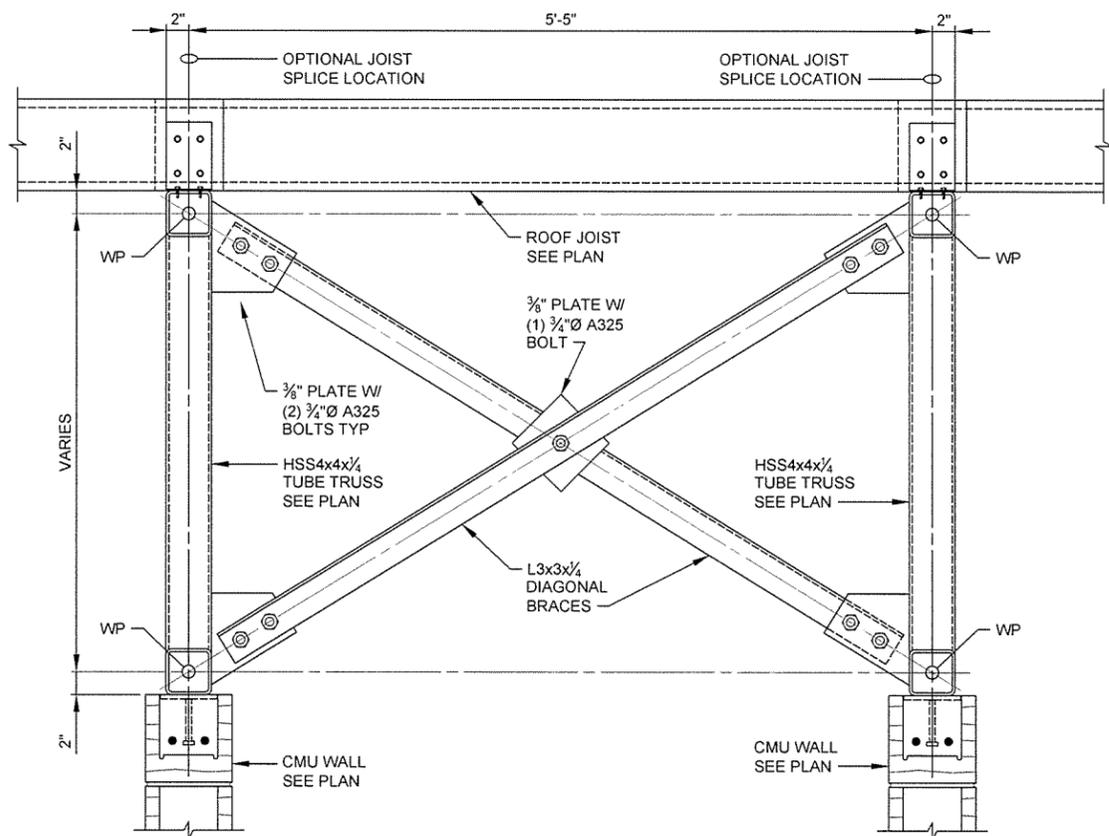

SECTION 3
S-102/S-307 SCALE: 1 1/2" = 1'-0"

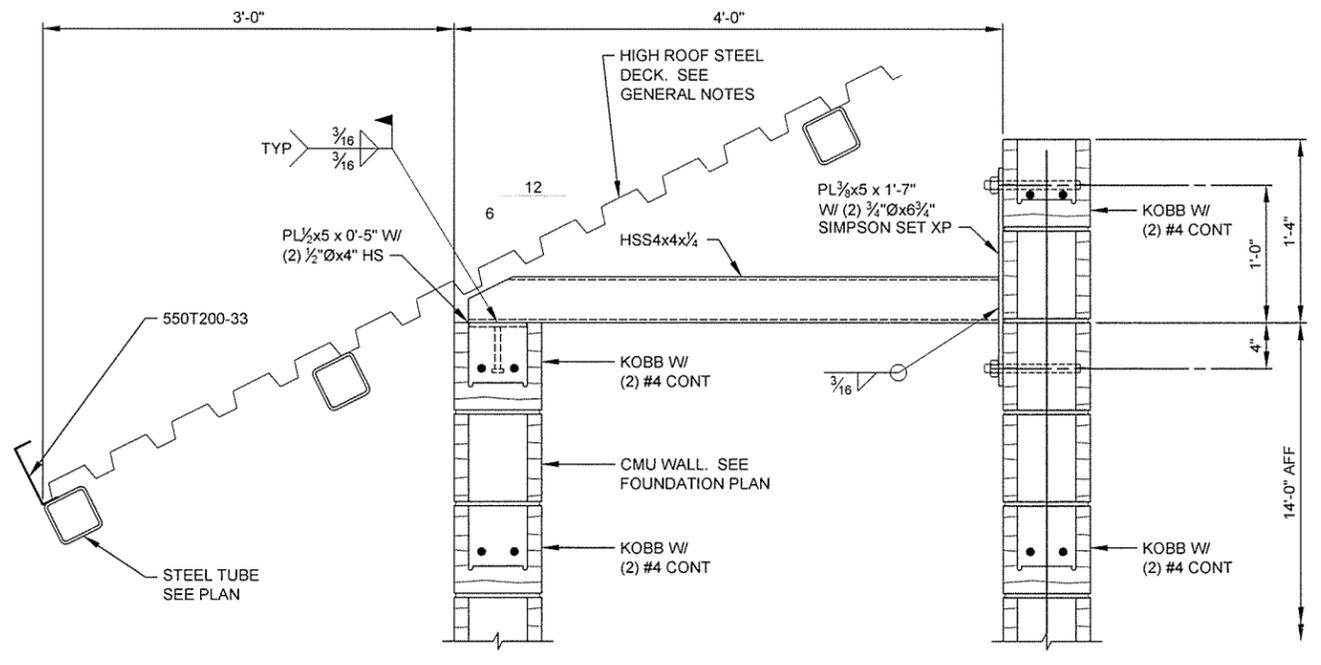

SECTION 4
S-102/S-307 SCALE: 1 1/2" = 1'-0"

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No. 766
ARKANSAS ENGINEER

STATE OF ARKANSAS
LICENSED PROFESSIONAL ENGINEER
No. 15642
R. Taylor Clement
9/30/15


JRR	Appr
10/11/15	Date
ISSUED FOR CONSTRUCTION	Description
IPC	Symbol

Job Number	066451
Submitted by	John T. Vanders III, PE, SE Director, Federal Services
Plat Scale	N/A
Plat Date	11
Plot Date	9/30/15
Dwg Code	
Designed by	D. CLEMENT
Drawn by	S. BOWEN
Checked by	G. ARCHER
File Name	AHHSWS-S-307.DWG


ARKANSAS HIGHWAY AND TRANSPORTATION DEPARTMENT
ARKANSAS TOURIST INFORMATION CENTER
(WHITE RIVER) (S)
JOB 061451
TOURIST INFORMATION CENTER
FRAMING SECTIONS

Sheet Reference Number:
S-307
Sheet 91 of 130


ARKANSAS
 LICENSED PROFESSIONAL ENGINEER
 TAYLOR CLEMENT
 No. 15642
 9/30/15

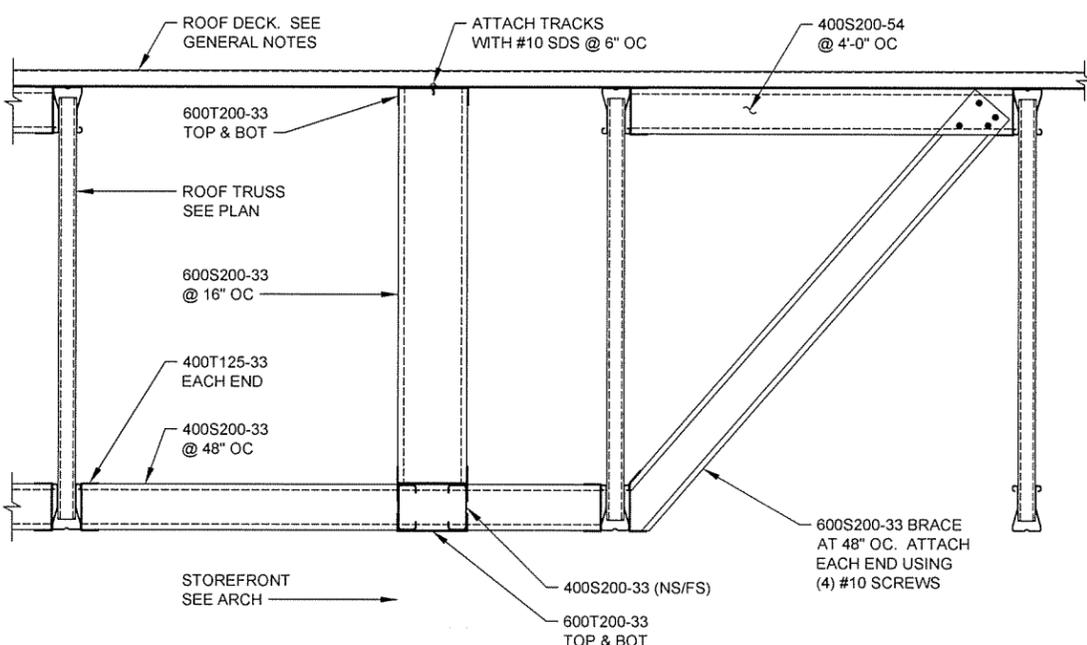


SECTION 1
 S-102 S-308 SCALE: 1/2" = 1'-0"

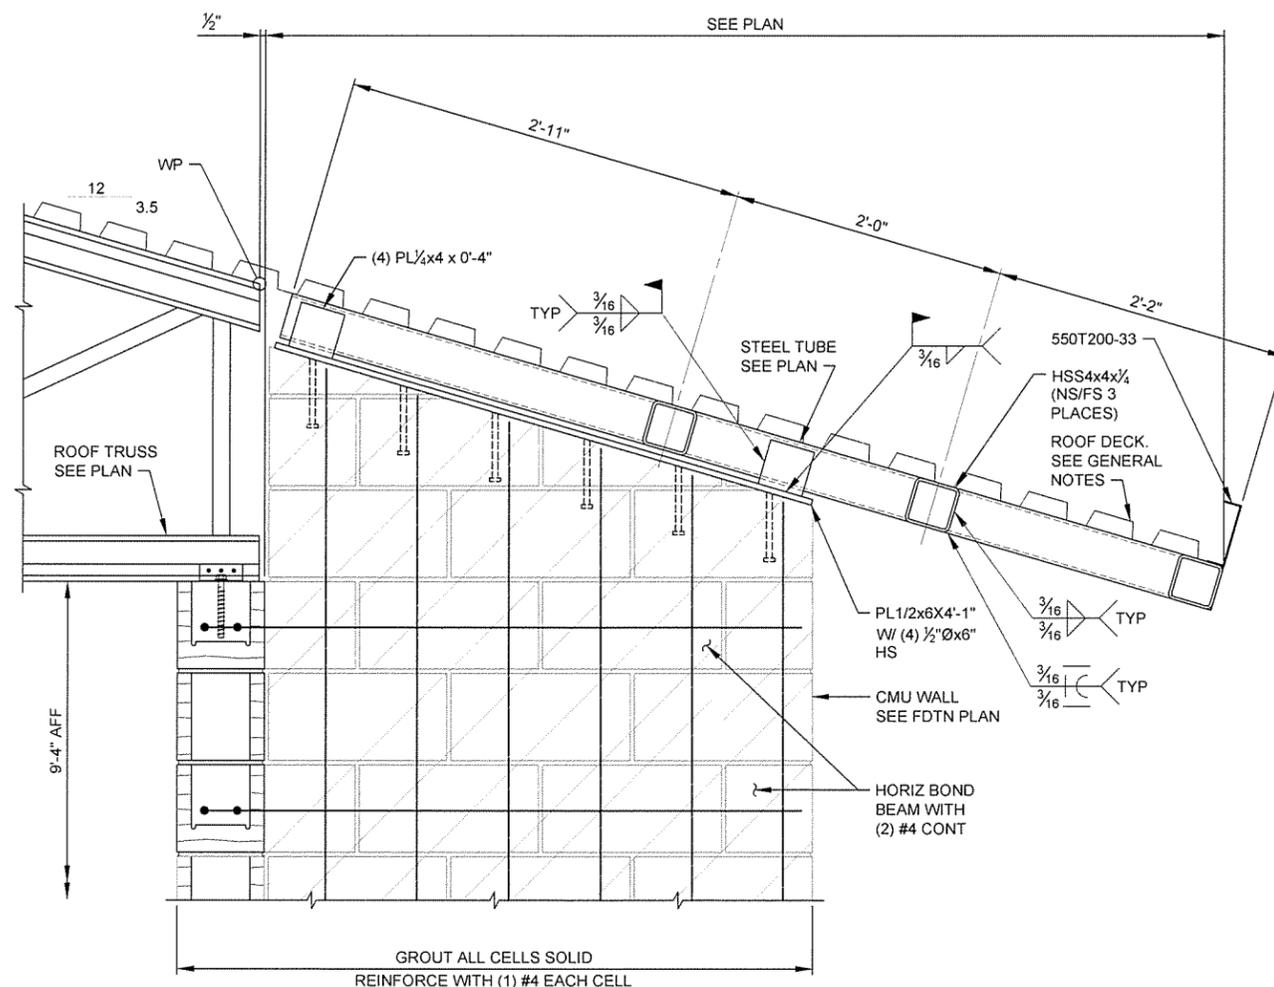

SECTION 2
 S-102 S-308 SCALE: 1/2" = 1'-0"

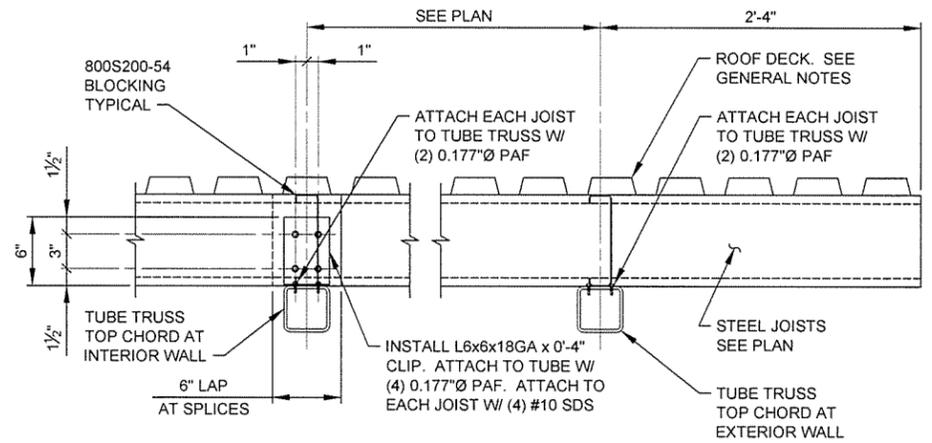

SECTION 3
 S-306 S-308 SCALE: 1/2" = 1'-0"

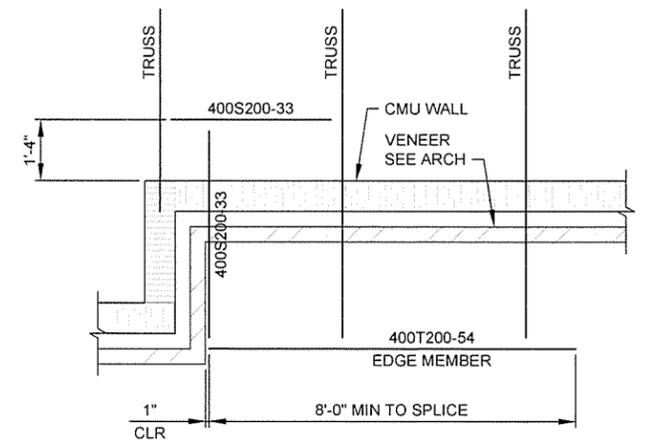

SECTION 4
 S-102 S-308 SCALE: 1/2" = 1'-0"




Job Number	060451	Job Title	Director, Technical Services
Submitted by	John T. Williams, P.E., SE	Plot Date	9/30/15
Designed by	D. CLEMENT	Checked by	G. ARCHER
Drawn by	S. BOWEN	File Name	AR15WR-S-308.DWG
Plot Scale	N/A	Job Scale	1:1
Date	10/1/15	Job Scale	1:1
Date	10/1/15	Job Scale	1:1
Date	10/1/15	Job Scale	1:1

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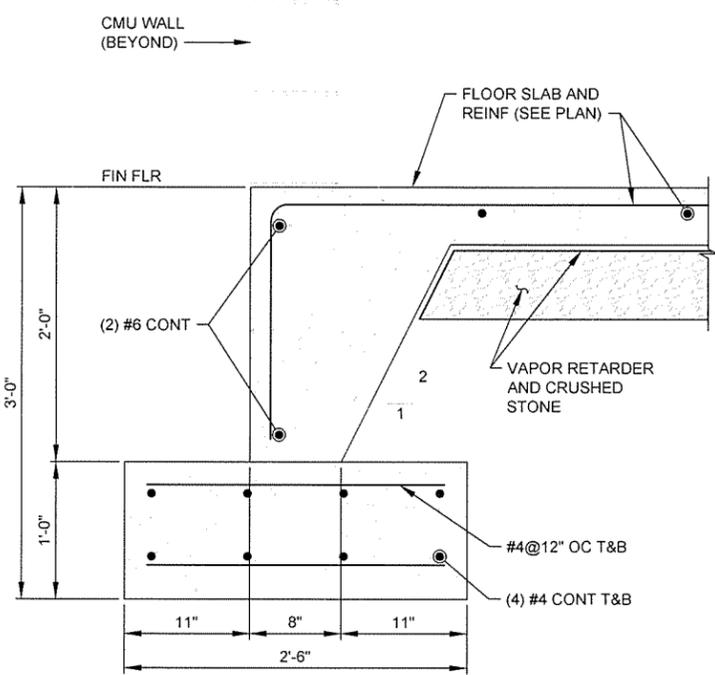
JRR	Appr.
10/1/15	Date
ISSUED FOR CONSTRUCTION	Description
IPC	Symbol

Submitted by John T. Watkins, III, PE, SE Director, Federal Services	Job Number 060451	N/A	N/A	N/A
Designed by D. CLEMENT	Drawn by S. BOWEN	Checked by G. ARCHER	Plot Date 9/30/15	Plot Scale 1:1
File Name AHTSWRS-S-321.DWG		Dwg Code		


ARKANSAS HIGHWAY AND TRANSPORTATION DEPARTMENT
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 (WHITE RIVER) (S)
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 FOUNDATION SECTIONS

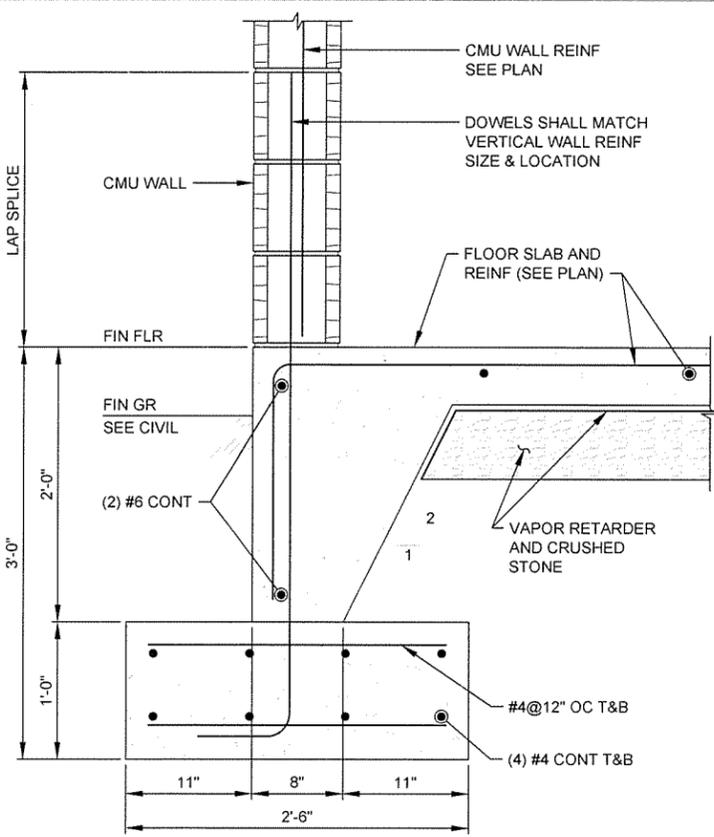


SECTION 1
 S-121|S-321 SCALE: 1/2" = 1'-0"




SECTION 2
 S-121|S-321 SCALE: 1/2" = 1'-0"

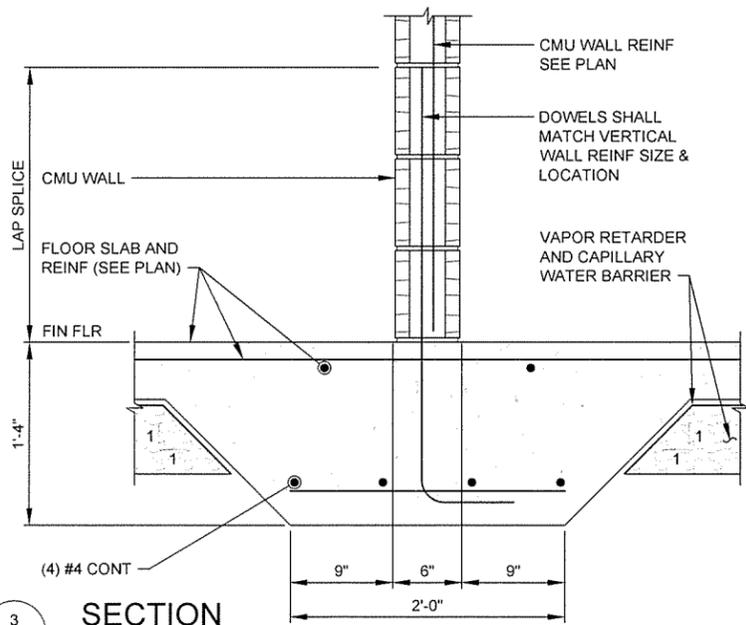

SECTION 3
 S-121|S-321 SCALE: 1/2" = 1'-0"







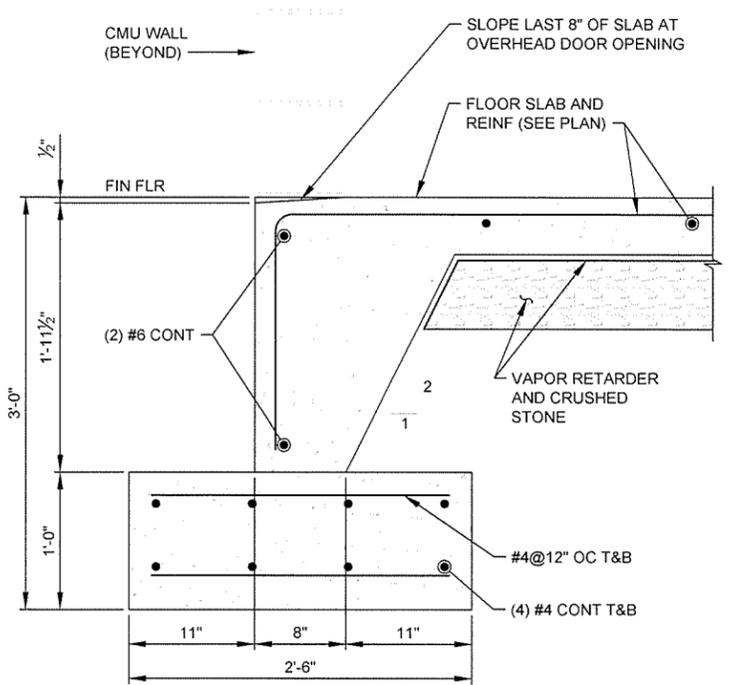



SECTION 4
 S-121|S-321 SCALE: 1/2" = 1'-0"

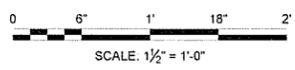


Submitted by John T. Watkins, III, PE, SE Director, Federal Services	Job Number 060451	N/A	N/A	N/A
Designed by D. CLEMENT	Plot Date 9/30/15	Plot Scale 1:1	Dwg Code	File Name AHS15WRFS-322.DWG
Drawn by S. BOWEN	Checked by G. ARCHER			

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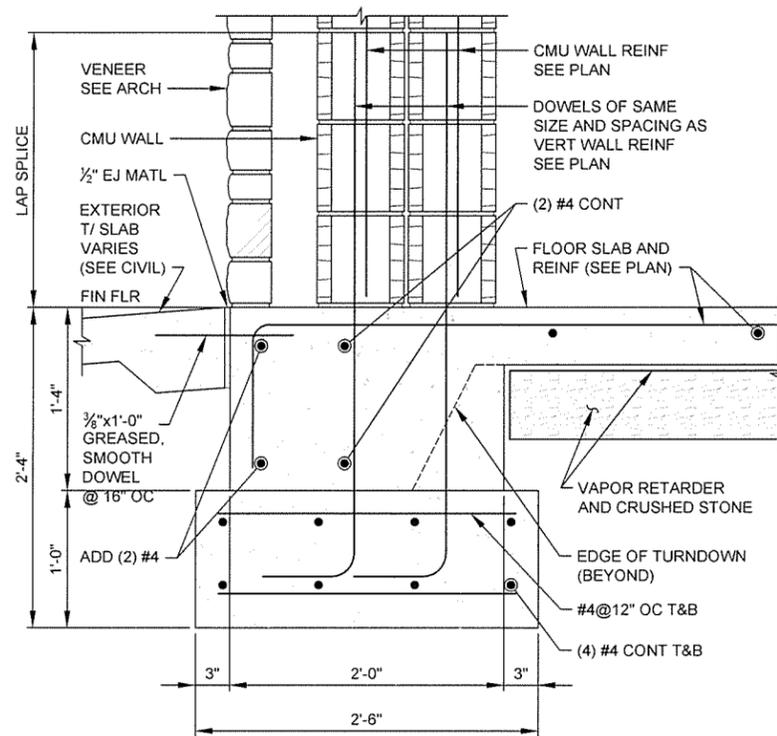


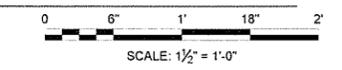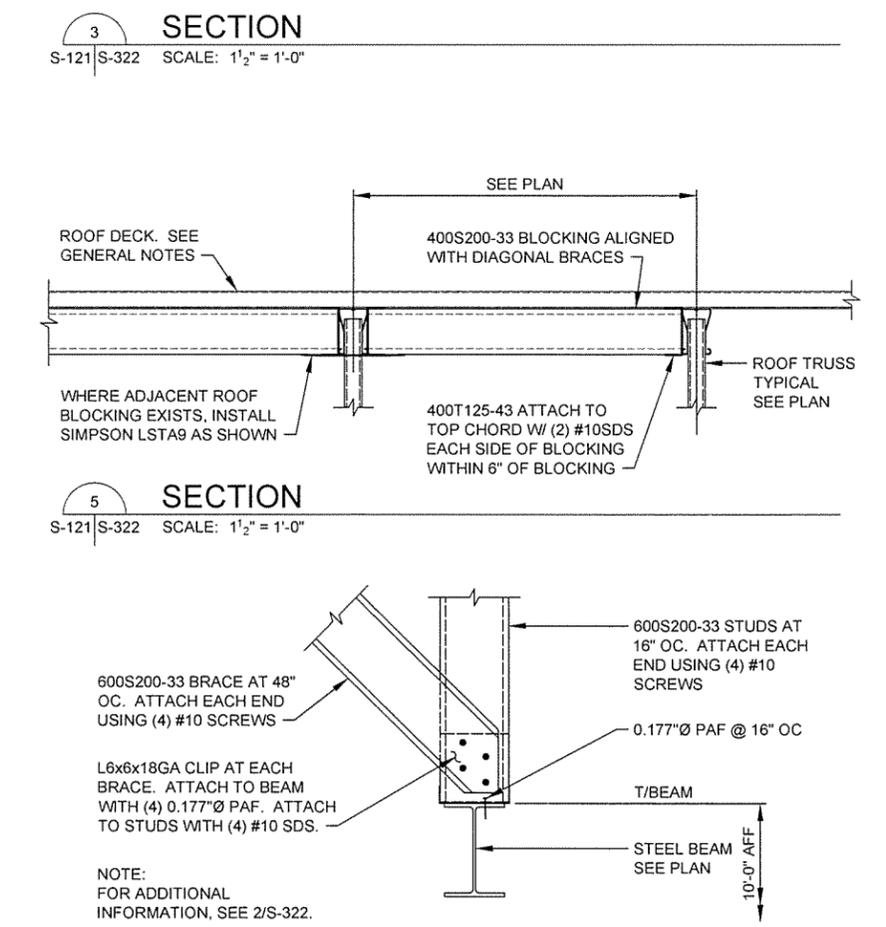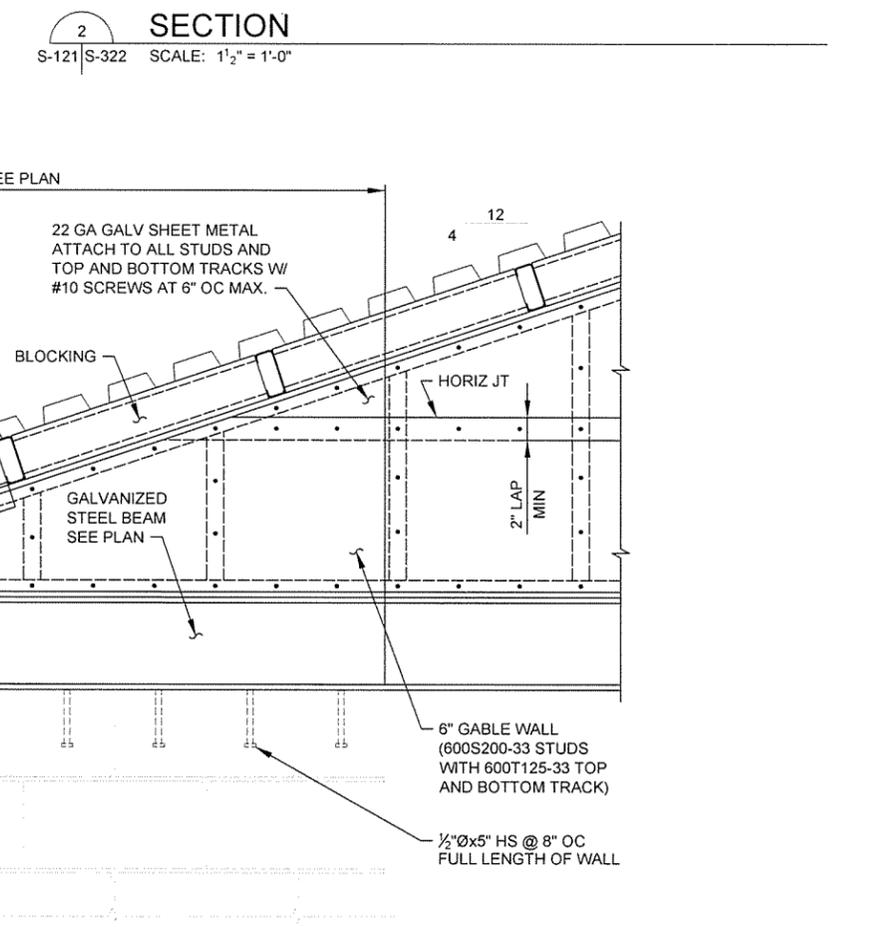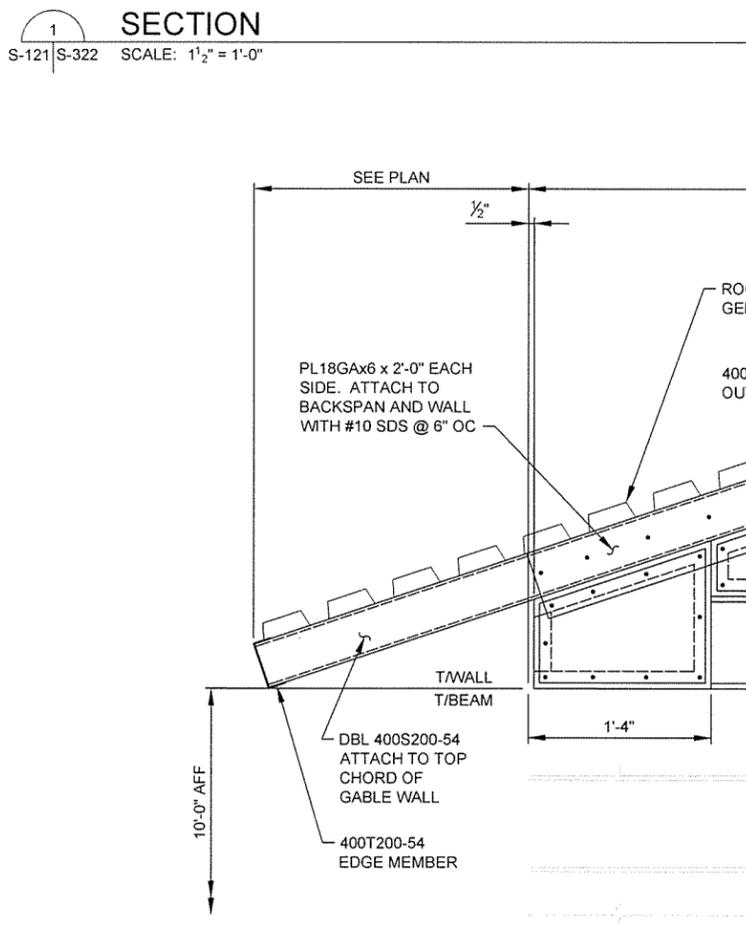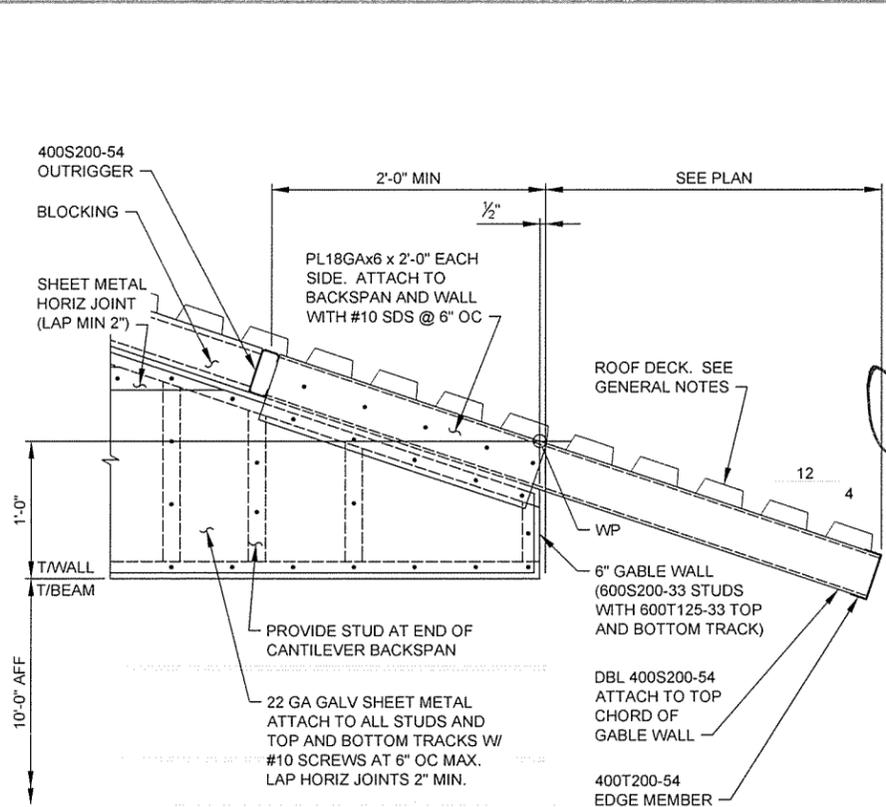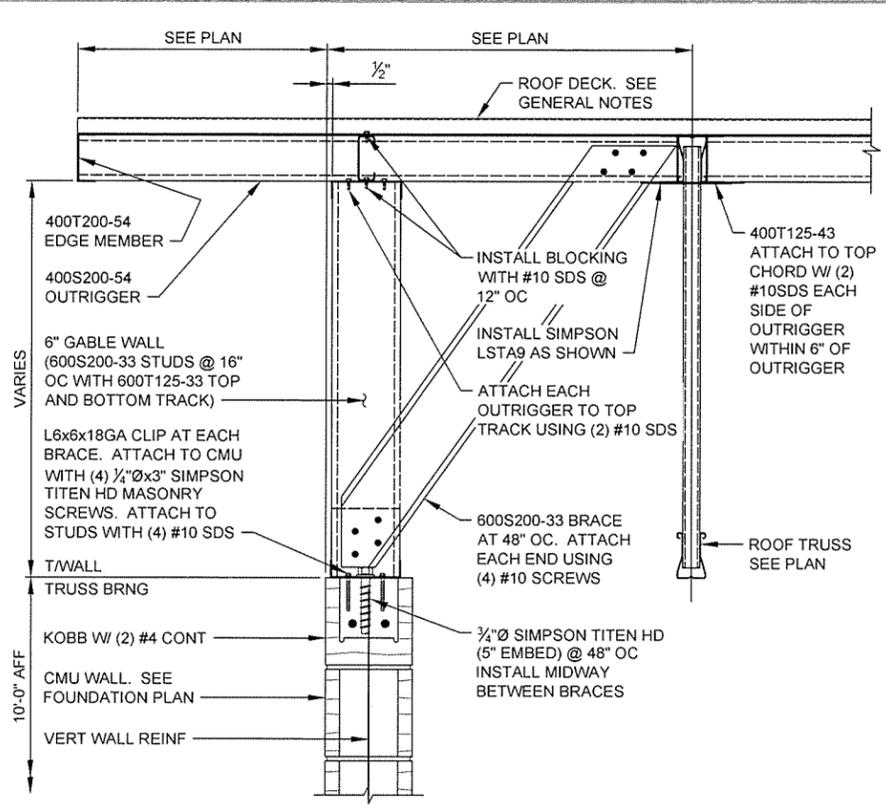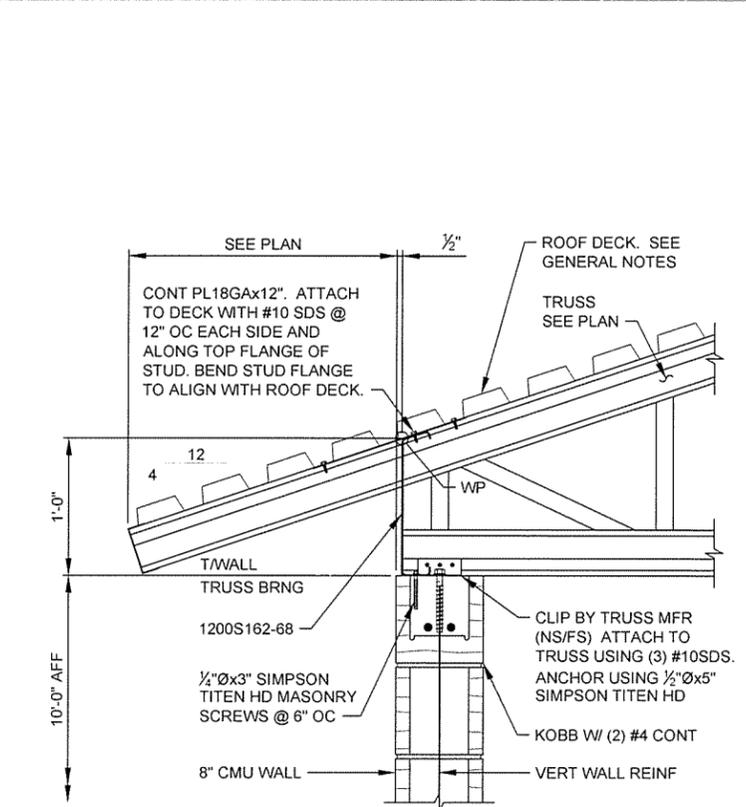

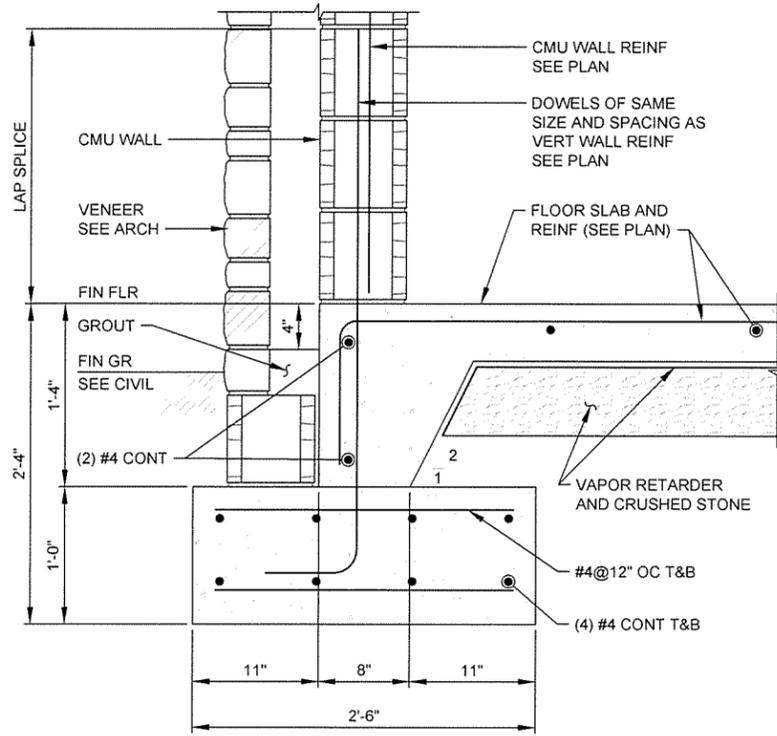
SECTION 1
S-131|S-331 SCALE: 1 1/2" = 1'-0"

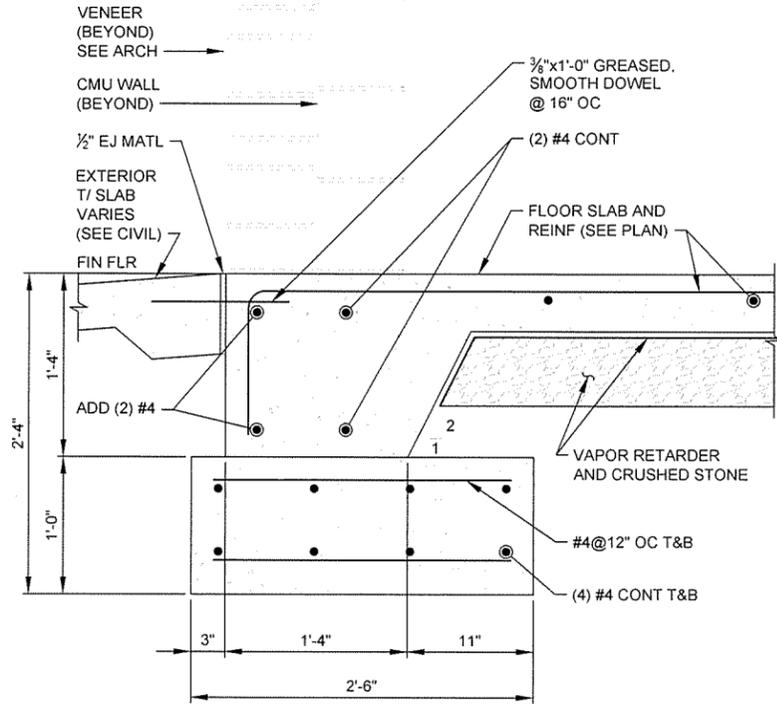


SECTION 2
S-131|S-331 SCALE: 1 1/2" = 1'-0"




SECTION 3
S-131|S-331 SCALE: 1 1/2" = 1'-0"

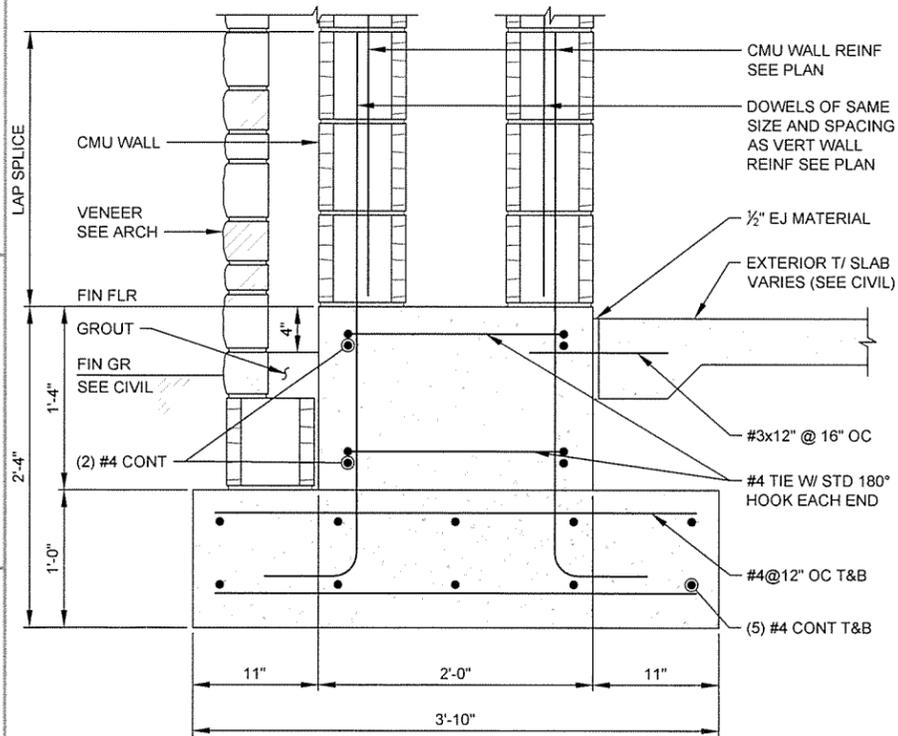


SECTION 4
S-131|S-331 SCALE: 1 1/2" = 1'-0"

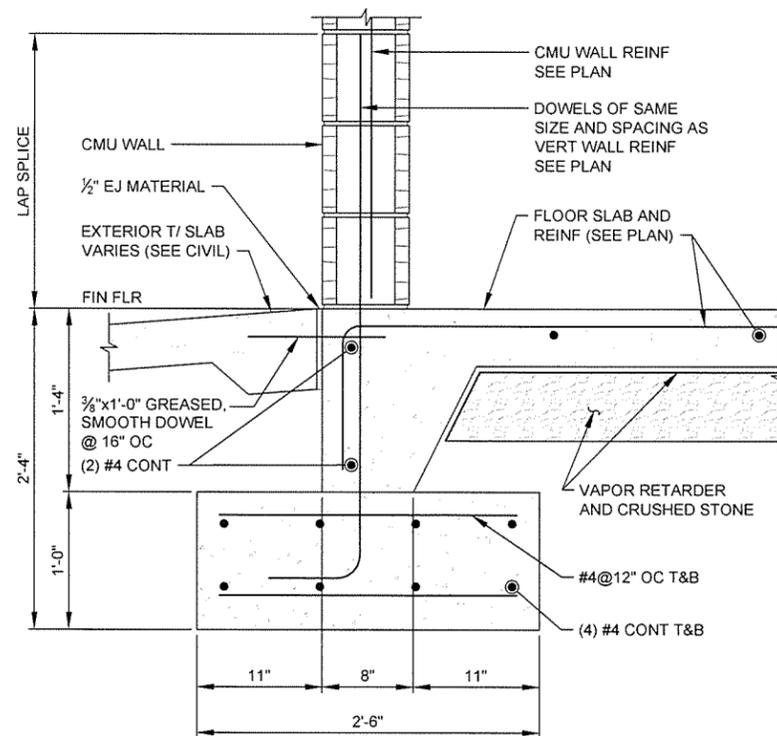

SECTION 5
S-131|S-331 SCALE: 1 1/2" = 1'-0"

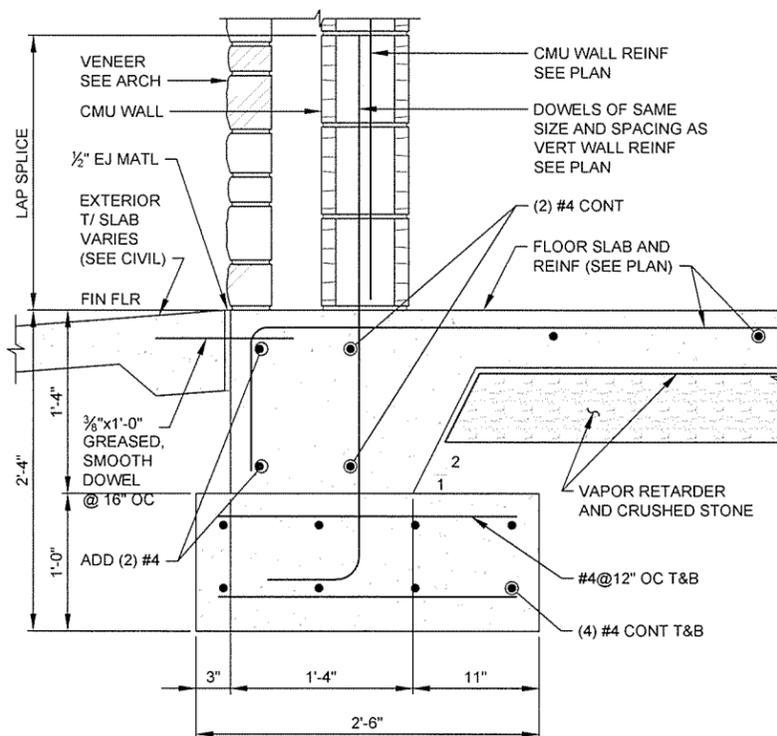

SECTION 6
S-131|S-331 SCALE: 1 1/2" = 1'-0"

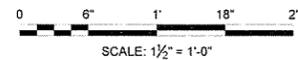


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TAYLOR CLEMENT
No. 15642
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STATE OF ARKANSAS


JRR	Appr.
10/11/15	Date
ISSUED FOR CONSTRUCTION	Description
IFC	Symbol

Submitted by	Job Number	060451
John T. Watkins, III, PE, SE Director, Federal Services	N/A	N/A
Designed by	Plot Date	9/30/15
D. CLEMENT	Plot Scale	1:1
Drawn by	Dwg Code	
S. BOWEN	G. ARCHER	
Checked by	File Name	AH15WRF-S-331.DWG



ARKANSAS HIGHWAY AND TRANSPORTATION DEPARTMENT
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JOB 061451
TRUCKER-VENDING BUILDING
FOUNDATION SECTIONS

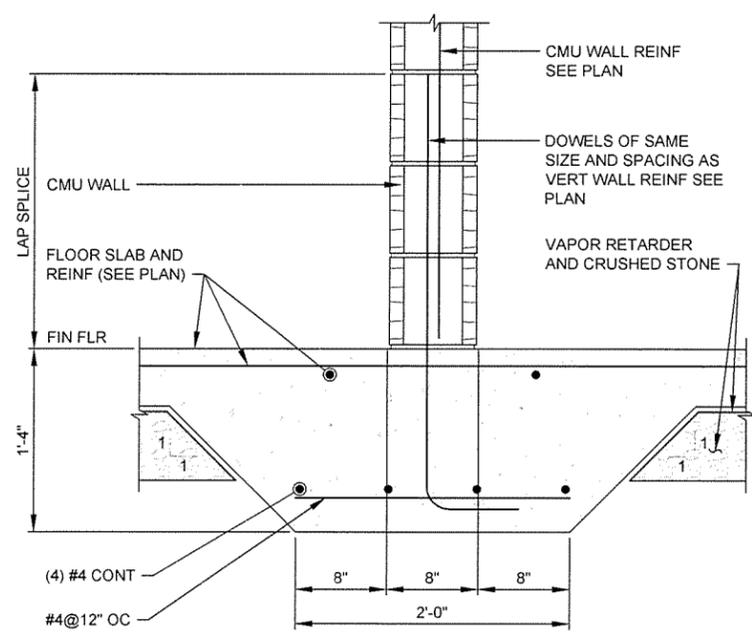

SECTION 1
S-131|S-332 SCALE: 1/2" = 1'-0"

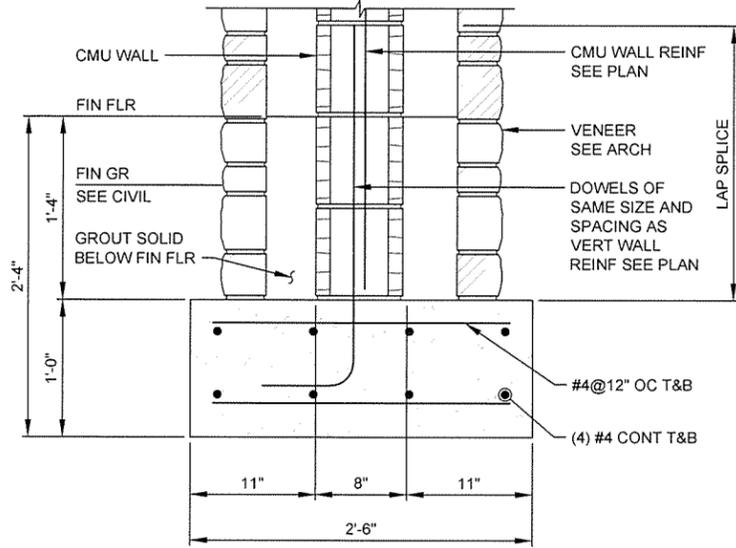

SECTION 2
S-131|S-332 SCALE: 1/2" = 1'-0"

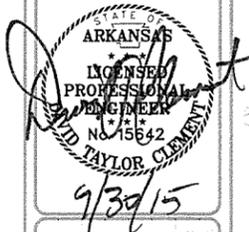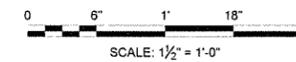


JRR	Appr
10/1/15	Date
ISSUED FOR CONSTRUCTION	Description
IFC	Symbol

Designed by: D. CLEMENT	Submitted by: John T. Watkins, III, PE, SE Director, Federal Services	Job Number: 069A51
Drawn by: S. BOWEN	Plot Date: 9/30/15	Plot Scale: 1:1
Checked by: G. ARCHER	Draw Code:	N/A
File Name: A15WKS-S-332.DWG		N/A


ARKANSAS HIGHWAY AND TRANSPORTATION DEPARTMENT
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TRUCKER-VENDING BUILDING
 FOUNDATION SECTIONS

Sheet Reference Number:
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 Sheet 96 of 130

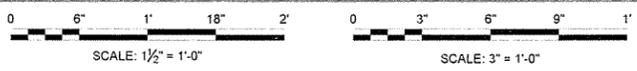

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David Clement
ARKANSAS LICENSED PROFESSIONAL ENGINEER
No. 15642
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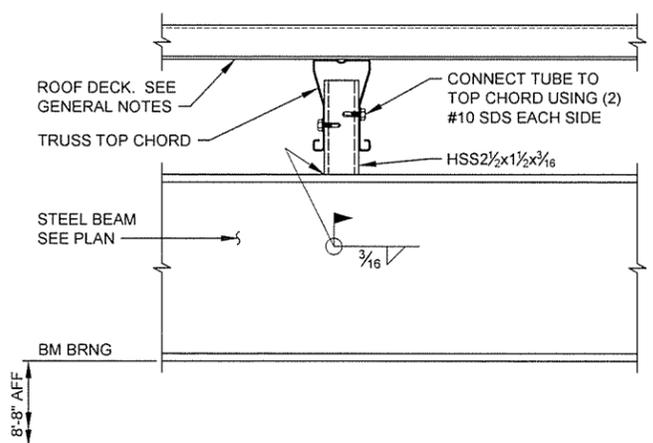
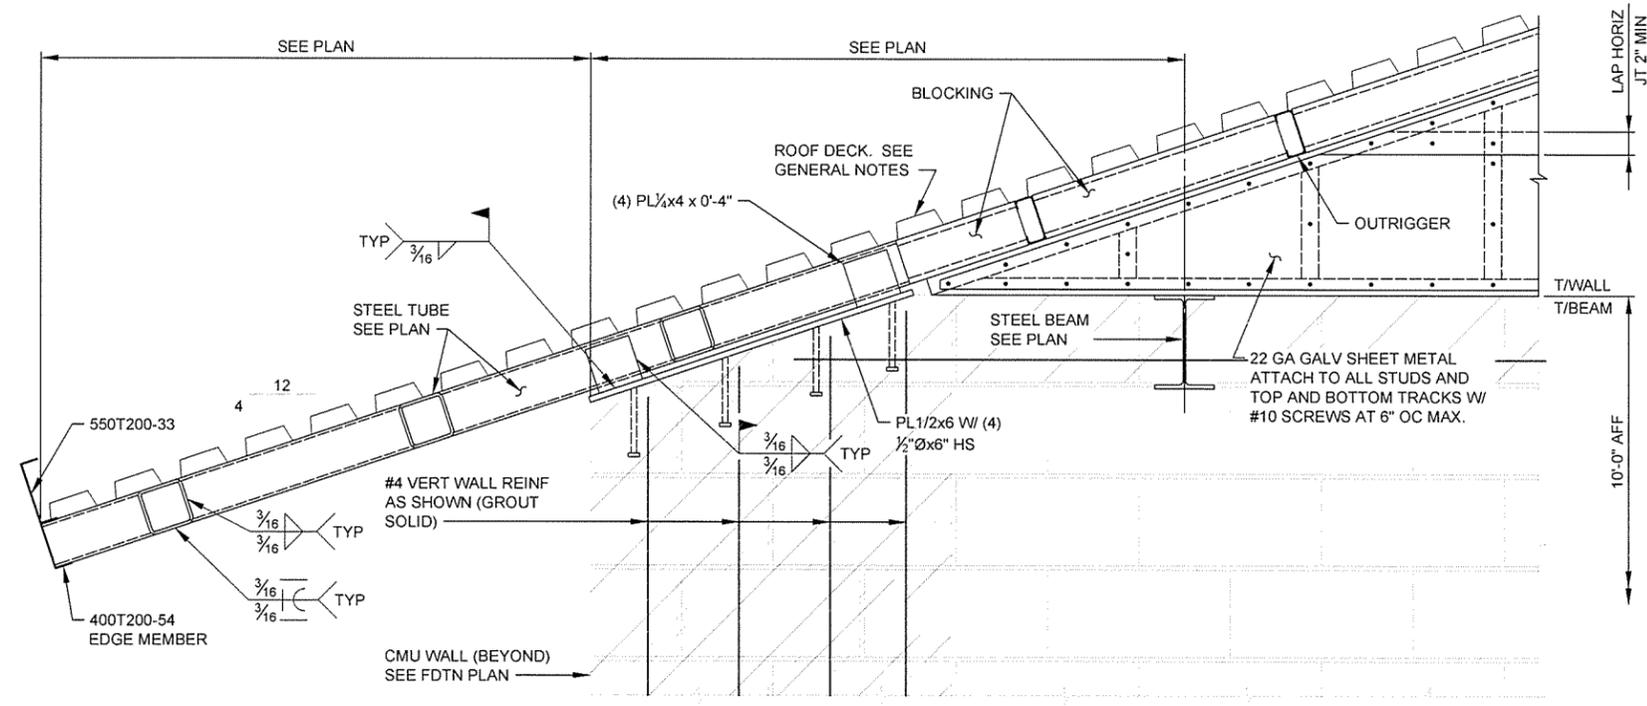
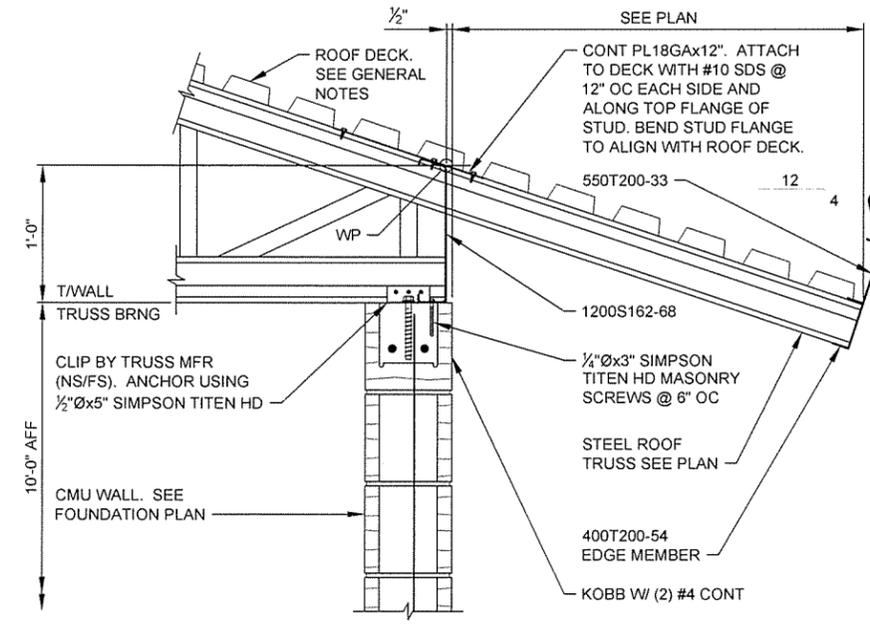
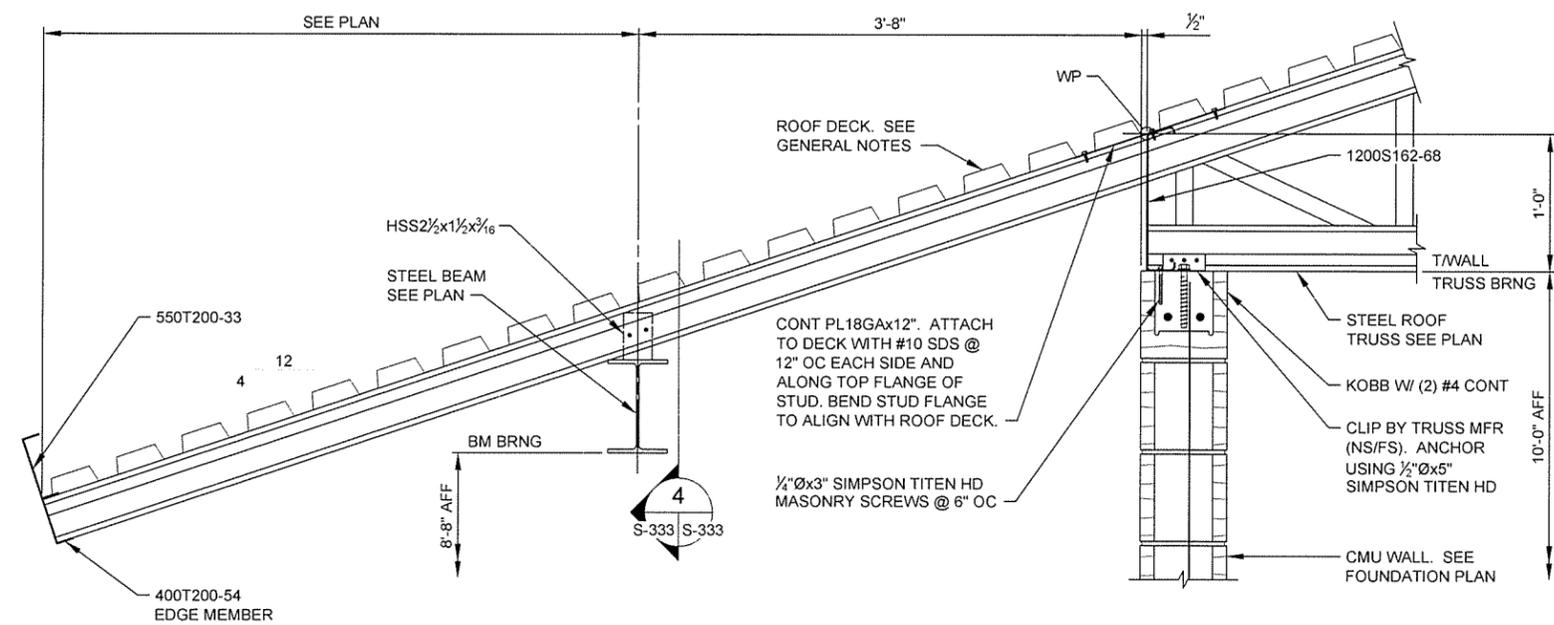
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10/11/15	Date
ISSUED FOR CONSTRUCTION	Description
IPC	Symbol


Job Number	066451
Submitted by	SE, SE
Director, Federal Services	N/A
Plot Scale	1:1
Plot Date	9/30/15
Drawn by	S. BOVEN
Checked by	G. ARCHER
File Name	AH15MWS-S-333.DWG
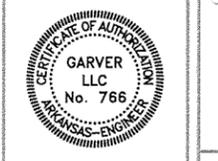
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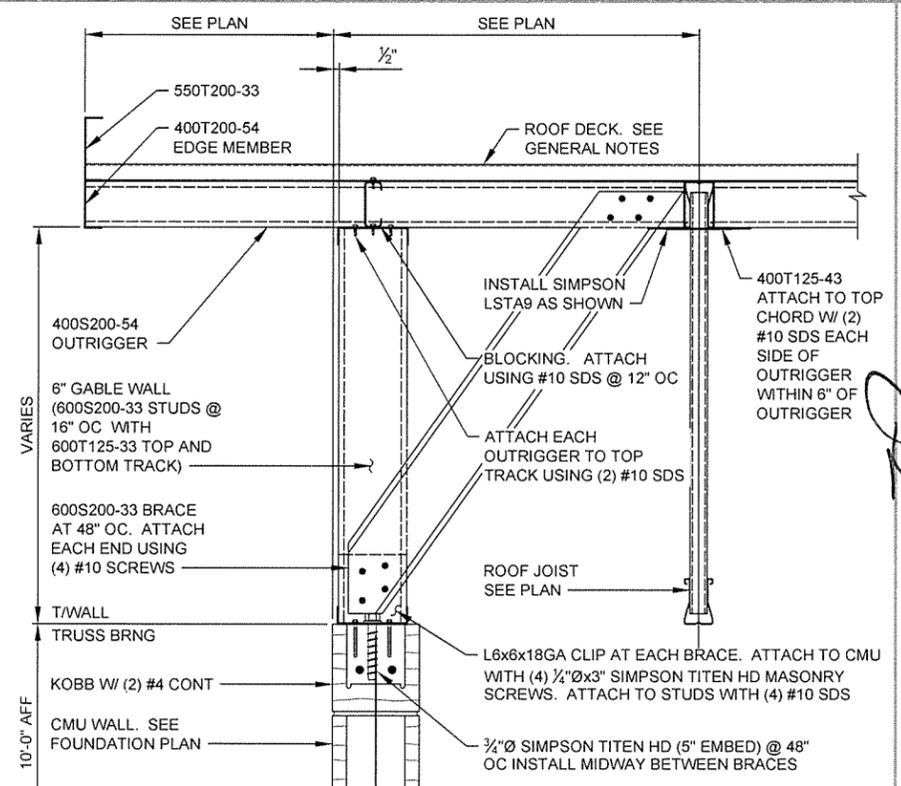
TRUCKER-VENDING BUILDING
FRAMING SECTIONS

Sheet Reference Number:
S-333
Sheet 97 of 130




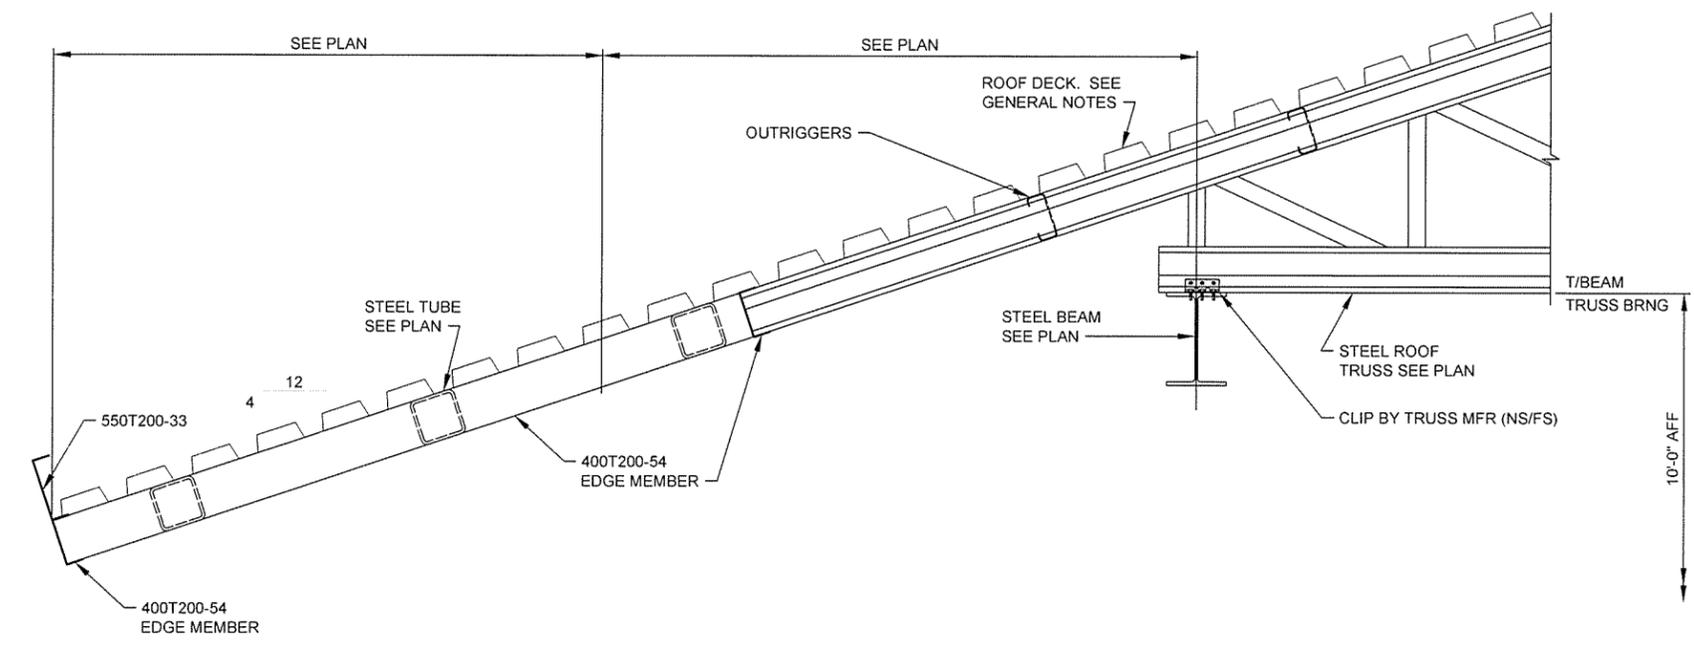


SECTION 1
S-131|S-334 SCALE: 1/2" = 1'-0"




SECTION 2
S-131|S-334 SCALE: 1/2" = 1'-0"

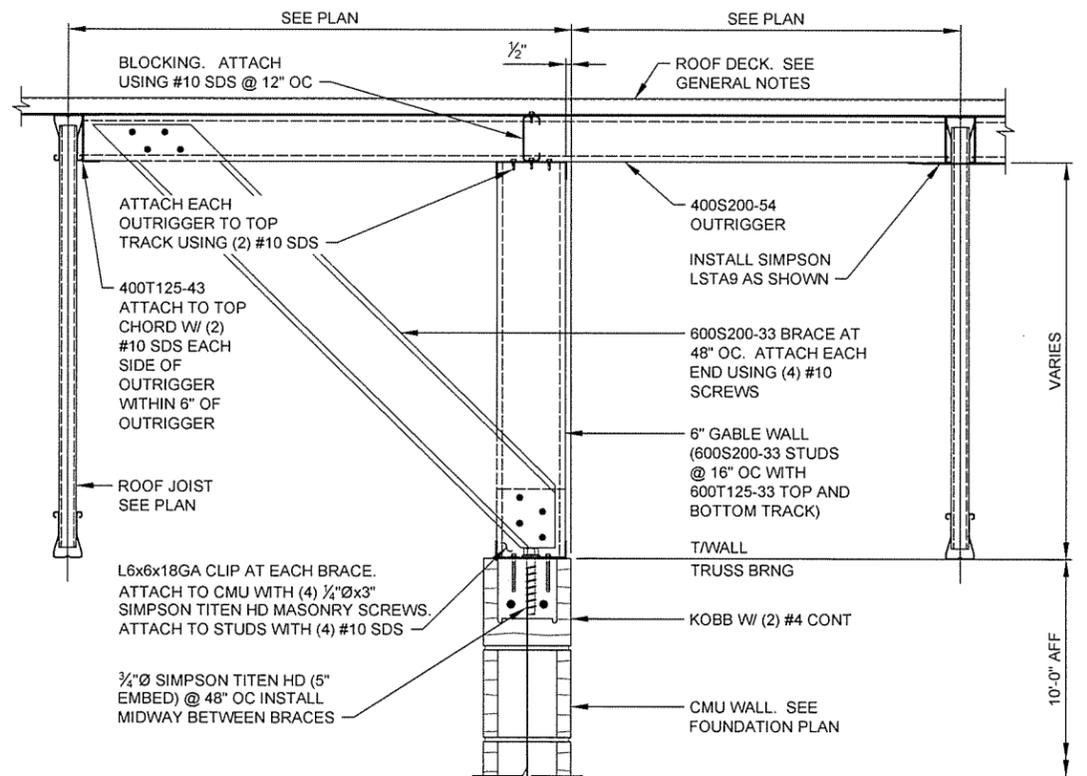

SECTION 3
S-131|S-334 SCALE: 1/2" = 1'-0"

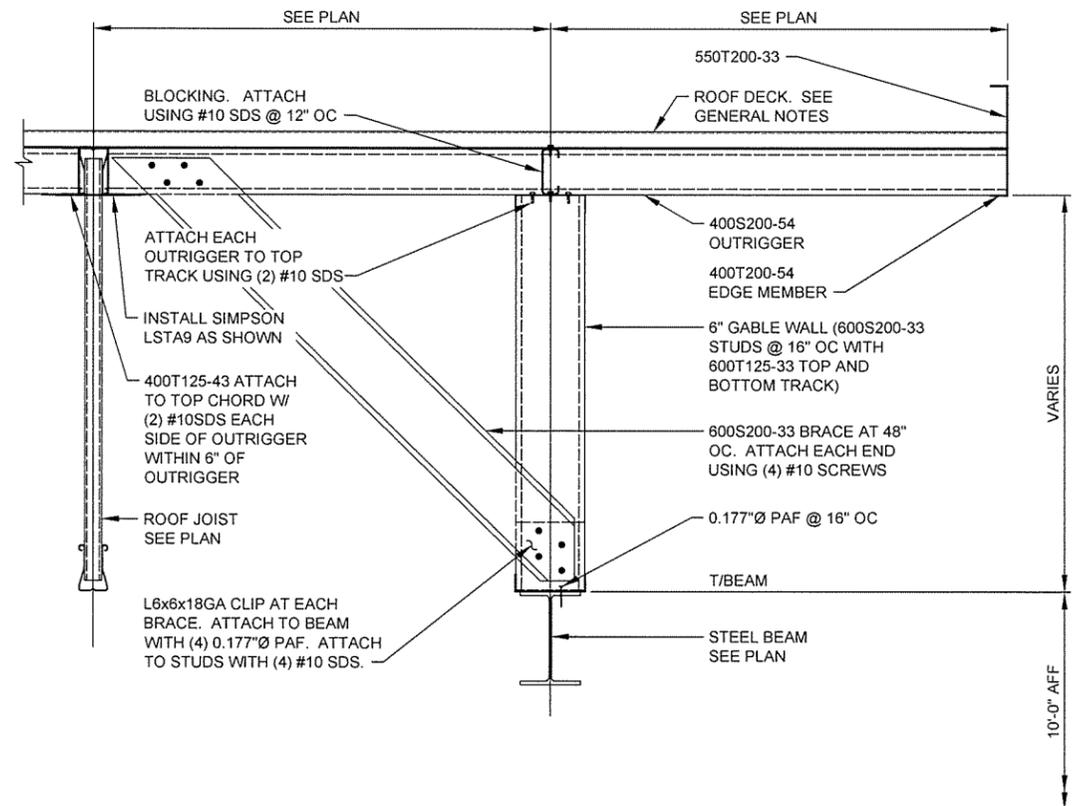

SECTION 4
S-131|S-334 SCALE: 1/2" = 1'-0"

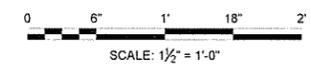

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STATE OF ARKANSAS
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DAVID TAYLOR CLEMENT
No. 15642

9/30/15


JRR
Appr.
10/1/15
Date

ISSUED FOR CONSTRUCTION
Description
IPC
Symbol


Submitted by John T. Vapiano III, PE, SE Director, Federal Services	Job Number 069451	N/A	N/A	N/A
Designed by D. CLEMENT	Plot Date 9/30/15	Plot Scale 1:1	Dwg Code	File Name ARHSW-S-334.DWG
Drawn by S. BOWEN	Checked by G. ARCHER			

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JOB 061451
TRUCKER-VENDING BUILDING
FRAMING SECTIONS


Sheet Reference Number:
S-334
Sheet 98 of 130

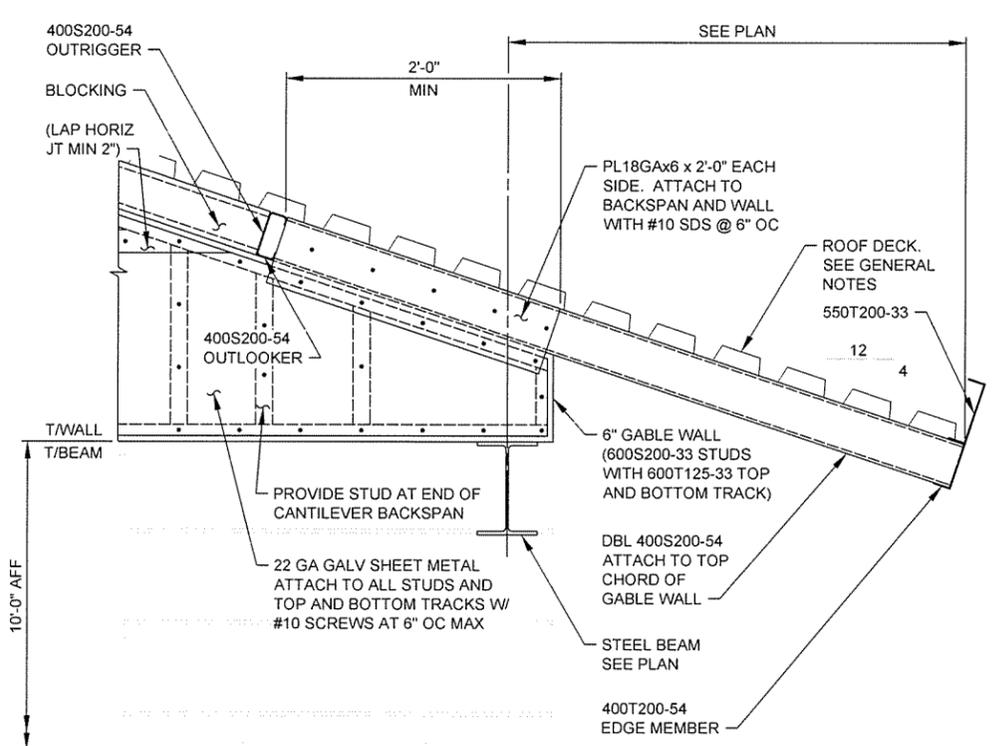


SECTION 1
S-131 | S-335 SCALE: 1 1/2" = 1'-0"

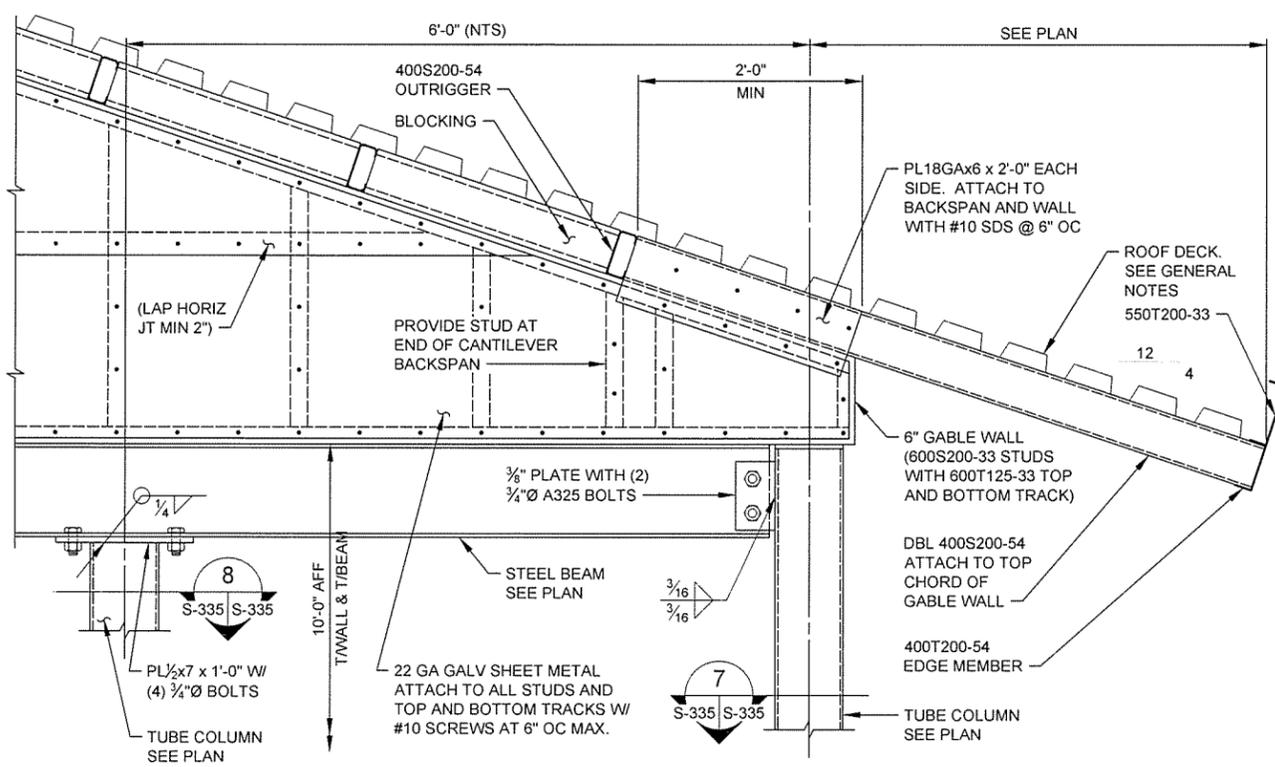


SECTION 2
S-131 | S-335 SCALE: 1 1/2" = 1'-0"

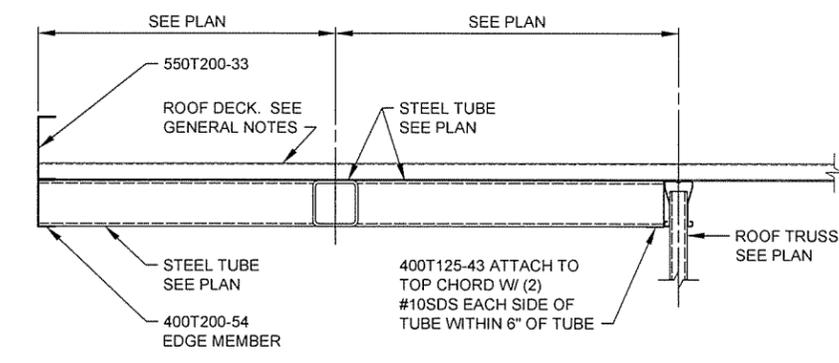


SECTION 3
S-131 | S-335 SCALE: 1 1/2" = 1'-0"

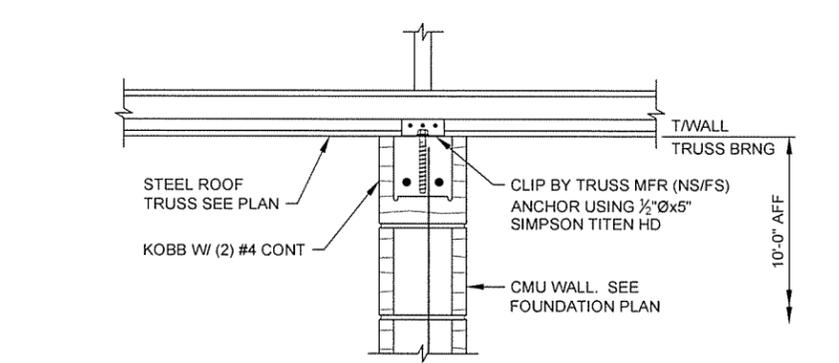


SECTION 5
S-131 | S-335 SCALE: 1 1/2" = 1'-0"

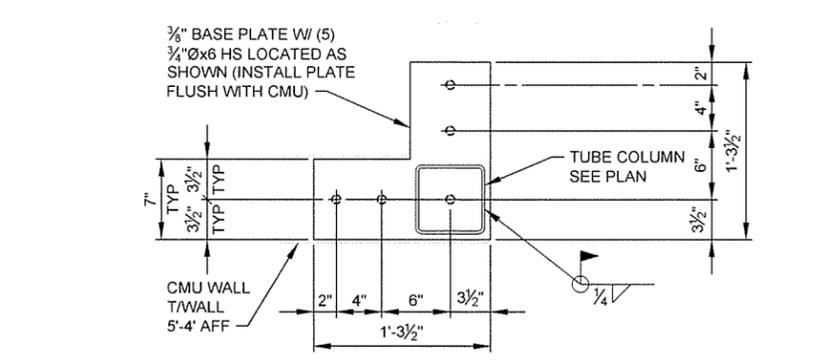


SECTION 7
S-335 | S-335 SCALE: 1 1/2" = 1'-0"

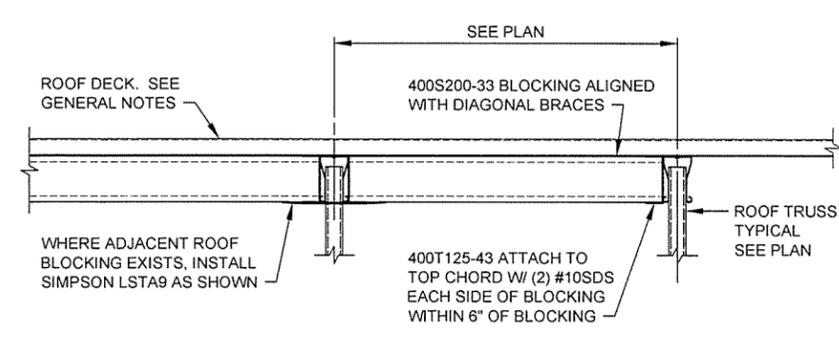


SECTION 4
S-131 | S-335 SCALE: 1 1/2" = 1'-0"

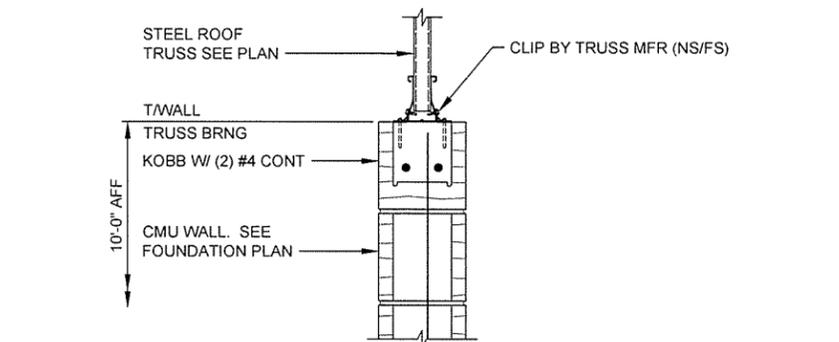

SECTION 6
S-131 | S-335 SCALE: 1 1/2" = 1'-0"

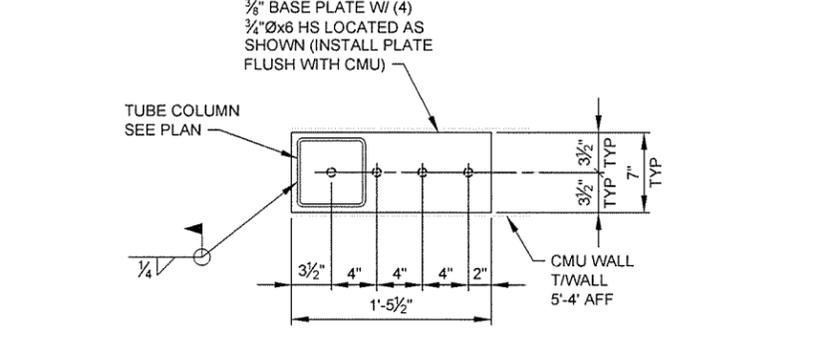

SECTION 8
S-335 | S-335 SCALE: 1 1/2" = 1'-0"

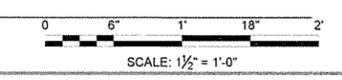


STATE OF ARKANSAS
LICENSED PROFESSIONAL ENGINEER
No. 15642
9/30/15

JRR	Appr.
10/1/15	Date
ISSUED FOR CONSTRUCTION	Description
IFC	Symbol


Job Number:	069451	N/A	N/A	N/A
Submitted by:	John T. Watkins III, P.E., SE Director, Federal Services	Plot Scale:	1:1	File Name:
Designed by:	D. CLEMENT	Drawn by:	S. BOWEN	Checked by:
Plot Date:	9/30/15	Draw Code:	G. ARCHER	File Name:
AH15WRS-S-335.DWG				

ARKANSAS HIGHWAY AND TRANSPORTATION DEPARTMENT
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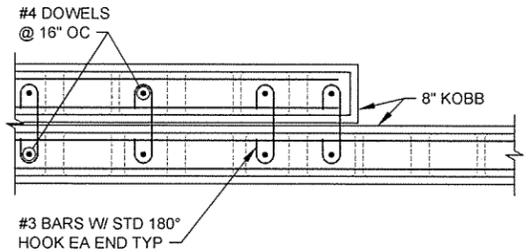
TRUCKER-VENDING BUILDING
FRAMING SECTIONS

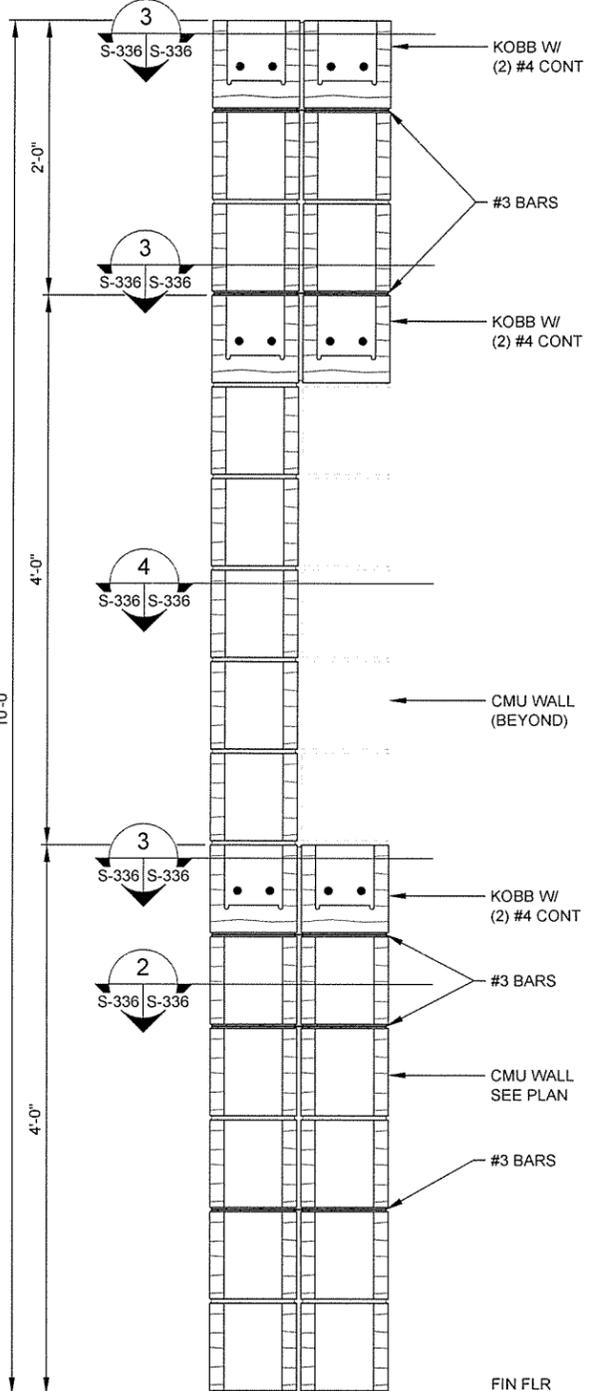


SECTION 1
S-131 | S-336 SCALE: 1 1/2" = 1'-0"

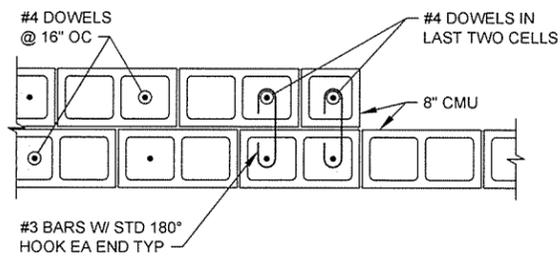


SECTION 2
S-336 | S-336 SCALE: 1" = 1'-0"



SECTION 3
S-336 | S-336 SCALE: 1" = 1'-0"

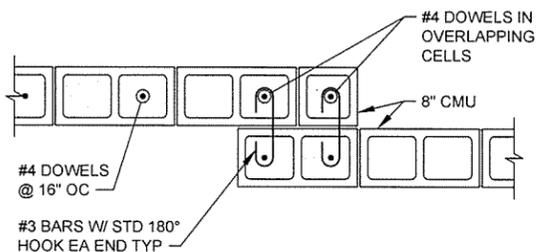

SECTION 4
S-336 | S-336 SCALE: 1" = 1'-0"

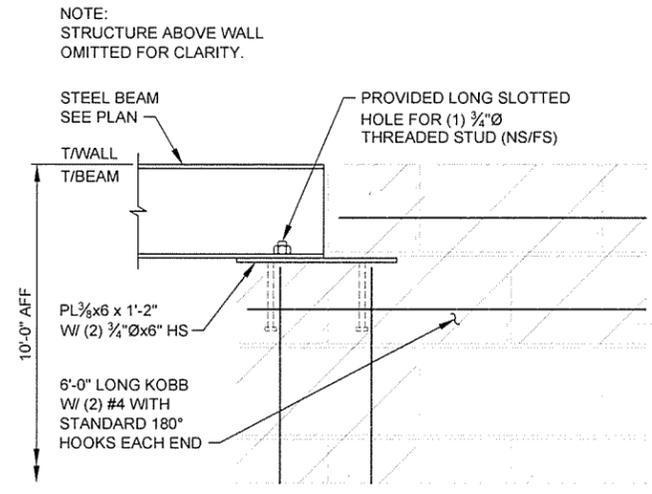

SECTION 5
S-131 | S-336 SCALE: 1 1/2" = 1'-0"

NOTE:
STRUCTURE ABOVE WALL
OMITTED FOR CLARITY.




STATE OF ARKANSAS
LICENSED PROFESSIONAL ENGINEER
NO. 15642
9/30/15
David Taylor Clement

JRR	Appr.
10/1/15	Date
ISSUED FOR CONSTRUCTION	Description
FC	Symbol

Job Number	060-51
Submitted by	John T. Walters, III, PE, SE Director, Federal Services
Drawn by	S. BOWEN
Checked by	G. ARCHER
Plot Date	9/30/15
Plot Scale	1:1
Dwg. Code	
File Name	AH15WR-S-336.DWG


ARKANSAS HIGHWAY AND TRANSPORTATION DEPARTMENT
ARKANSAS TOURIST INFORMATION CENTER
(WHITE RIVER) (S)
JOB 081451
TRUCKER-VENDING BUILDING
FRAMING SECTIONS

Sheet Reference Number:
S-336
Sheet 100 of 130

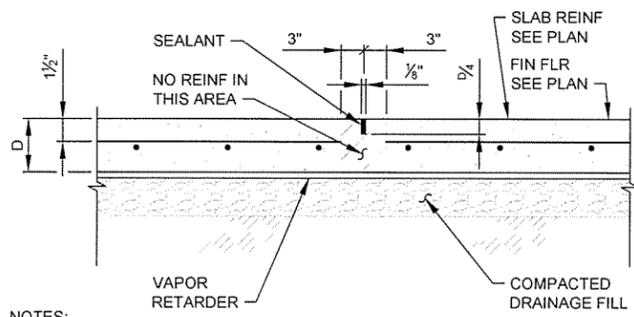


NOTES:
 1. SEE FOUNDATION PLAN(S) FOR ADDITIONAL SLAB INFORMATION INCLUDING DEPTH AND REINFORCING.
 2. THE SAWCUTTING SHALL BE DONE AS SOON AS THE CONCRETE HAS HARDENED SUFFICIENTLY TO PERMIT CUTTING WITHOUT CHIPPING, SPALLING, OR TEARING, BUT NOT MORE THAN EIGHT HOURS AFTER CASTING.
 3. THE CONTRACTOR MAY ELECT TO SAWCUT ANY CONSTRUCTION JOINTS AS SHOWN ON PLAN.

SAWCUT CONTROL JOINT

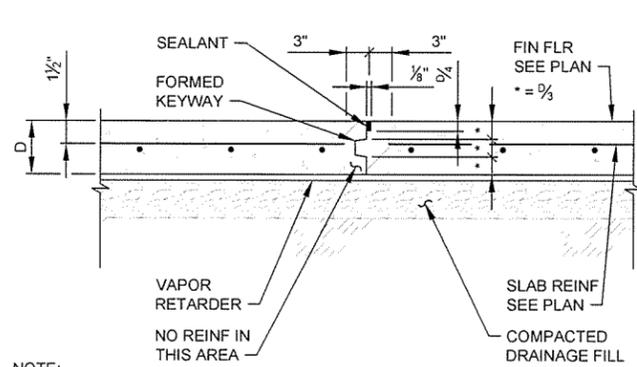


NOTE:
 SEE FOUNDATION PLAN(S) FOR ADDITIONAL SLAB INFORMATION INCLUDING DEPTH AND REINFORCING.

CONSTRUCTION JOINT

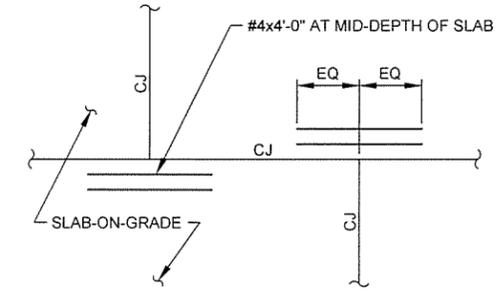

1 **DETAIL - TYPICAL SLAB JOINTS**
 S-501 SCALE: NONE

2 **DETAIL - REINF AT CONSTRUCTION JOINT**
 S-501 SCALE: NONE

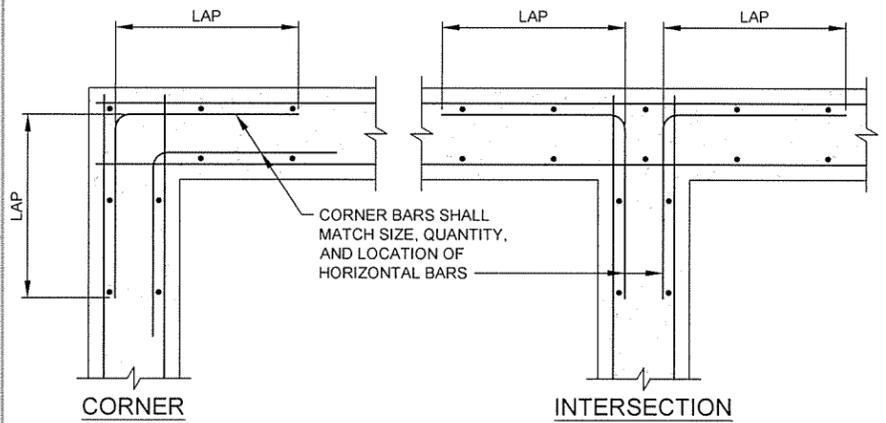

3 **DETAIL - FOOTING REINFORCING**
 S-501 SCALE: NONE

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STATE OF ARKANSAS
 CERTIFICATE OF AUTHORIZATION
GARVER
 LLC
 No. 766
 PROFESSIONAL ENGINEER


STATE OF ARKANSAS
 LICENSED PROFESSIONAL ENGINEER
 No. 15642
 DAVID TAYLOR CLEMENT
 9/30/15

JRR	Appr.
10/1/15	Date
ISSUED FOR CONSTRUCTION	Description
IPC	Symbol

Submitted by John T. Watkins, III, P.E., SE Director, Federal Services	Job Number 060-51	N/A	N/A	N/A
Plot Date 9/30/15	Plot Scale 1:1	Divg Code	File Name AHSWRS-S-501.DWG	
Designed by D. CLEMENT	Drawn by S. BOVEN	Checked by G. ARCHER		

ARKANSAS HIGHWAY AND TRANSPORTATION DEPARTMENT
 ARKANSAS TOURIST INFORMATION CENTER
 (WHITE RIVER) (S)
 JOB 061451
TYPICAL DETAILS


Sheet Reference Number:
S-501
 Sheet 101 of 130

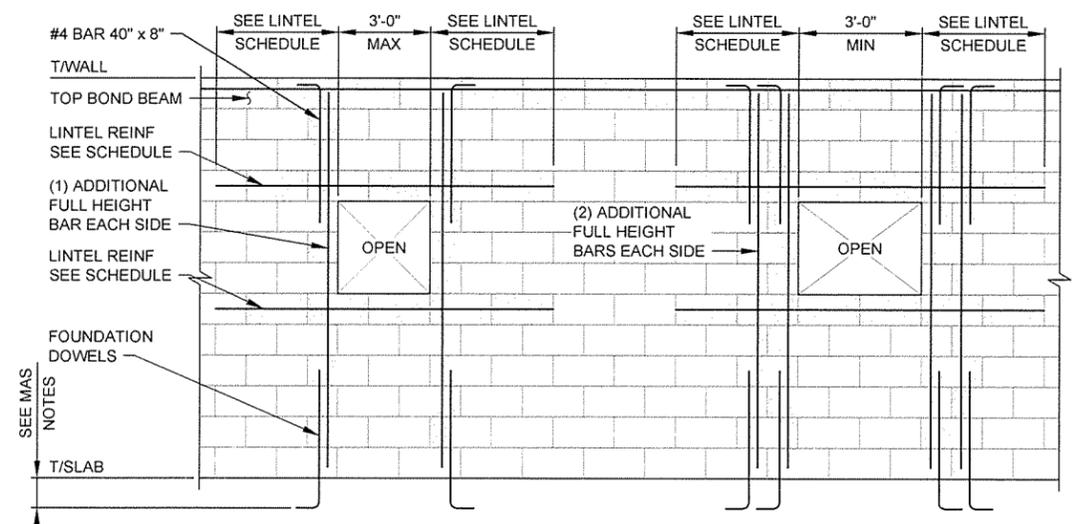

MASONRY LINTEL SCHEDULE					
MARK	BEARING LENGTH	NOMINAL DEPTH	TOP BARS	BOTTOM BARS	CLEAR SPAN (S)
L1	2'-0"	8"	NONE	(2)#5	0'-0" < S < 3'-4"
L2	2'-0"	16"	NONE	(2)#5	3'-4" < S < 6'-8"
L3	2'-0"	24"	(2)#5	(2)#5	6'-8" < S < 10'-0"




LOOSE LINTEL SCHEDULE			
MARK	BEARING LENGTH	MATERIAL	CLEAR SPAN (S)
L4	8" MIN	L4x4x1/2	0'-0" < S < 5'-6"
L5	8" MIN	L4x4x3/8	5'-6" < S < 8'-0"

NOTES:
 1. SEE ARCHITECTURE AND MECHANICAL DRAWINGS FOR OPENING SIZES AND LOCATIONS.
 2. USE SOLID BOTTOM BOND BEAMS AT OPENING HEADS ONLY. USE KNOCK-OUT BOND BEAMS ELSEWHERE.

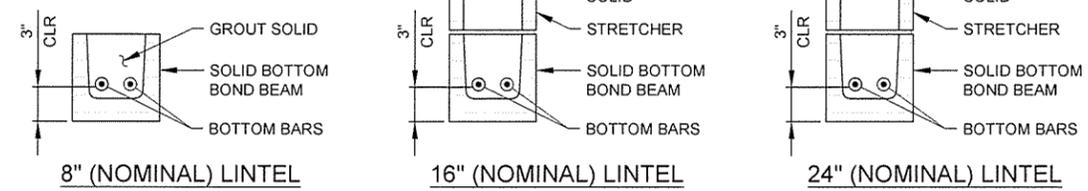

1 DETAIL - TYPICAL CMU WALL REINF AT OPENINGS
 SCALE: NONE





2 DETAIL - TYPICAL MASONRY LINTELS
 SCALE: NONE

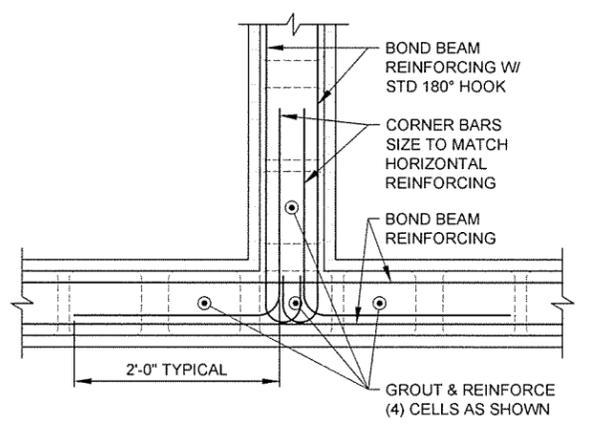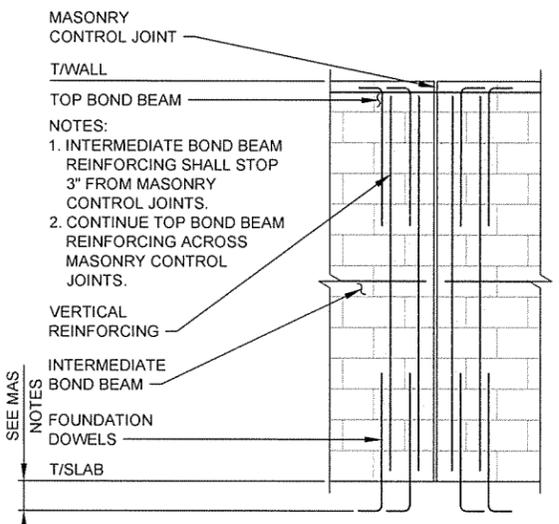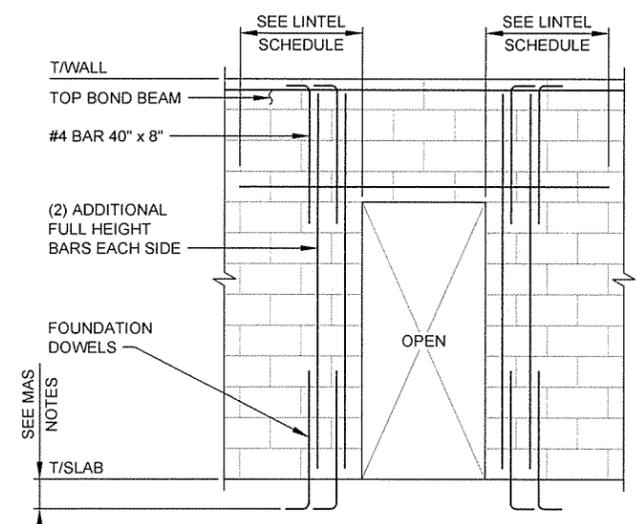

3 DETAIL - TYP CMU WALL REINF AT DOORS
 SCALE: NONE

4 DETAIL - TYP MASONRY CONTROL JT (WCJ)
 SCALE: NONE

5 DETAIL - TYP CMU WALL REINFORCING AT INTERSECTIONS
 SCALE: NONE

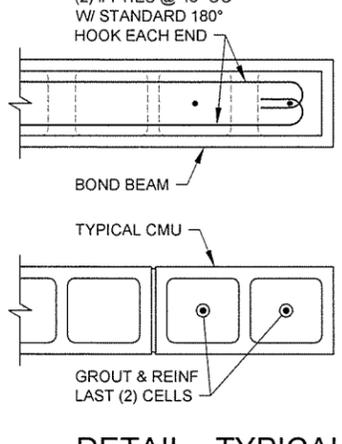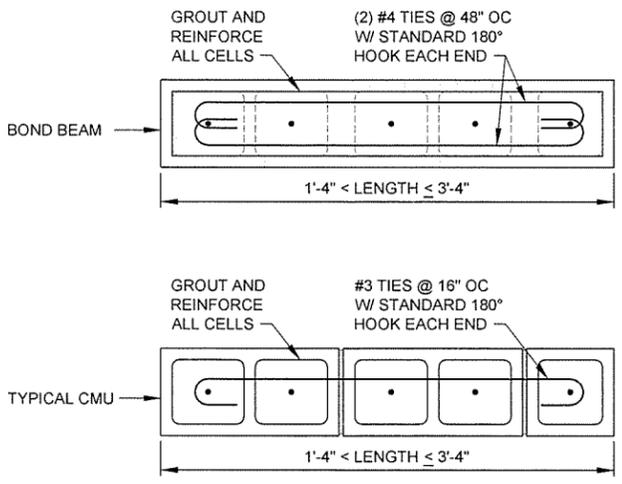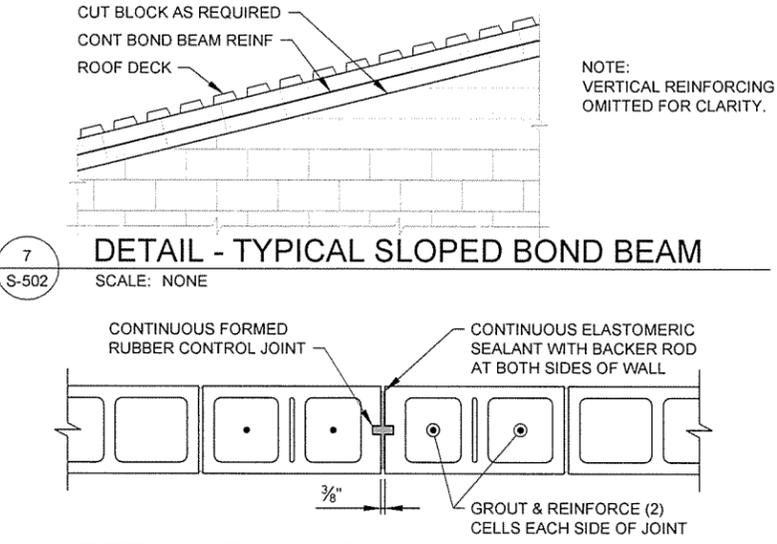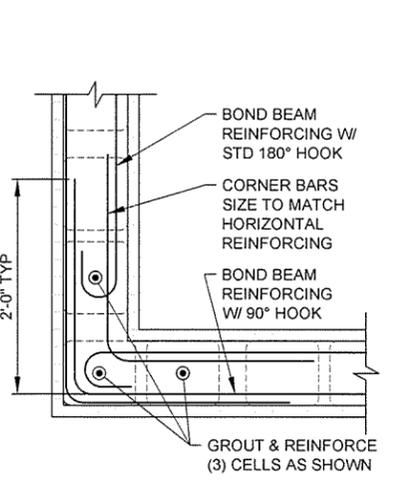

6 DET - TYP CMU WALL REINF AT CORNERS
 SCALE: NONE

7 DETAIL - TYP SLOPED BOND BEAM
 SCALE: NONE

9 DETAIL - TYP CMU WALL REINF AT PIERS
 SCALE: NONE

10 DETAIL - TYP CMU WALL REINF AT DEAD ENDS
 SCALE: NONE

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STATE OF ARKANSAS
 LICENSED PROFESSIONAL ENGINEER
 No. 766
 TAYLOR, CLEMENT

9/30/15
 JRR
 Date

10/1/15
 Date
 ISSUED FOR CONSTRUCTION
 Description
 IPC
 Symbol

Job Number: 000-51
 Submitted by: John T. Venable III, PE, SE
 Director, Federal Services
 Plot Scale: 1:1
 Plot Date: 9/30/15
 Drawn by: S. BOWEN
 Checked by: G. ARCHER
 File Name: AHTSWR-S-502.DWG

ARKANSAS HIGHWAY AND TRANSPORTATION DEPARTMENT
 ARKANSAS TOURIST INFORMATION CENTER
 (WHITE RIVER) (S)
 JOB 061451

Sheet Reference Number:
S-502
 Sheet 102 of 130

LEGEND


-  MECHANICAL EQUIPMENT (TYP.)
-  CEILING SUPPLY AIR DIFFUSER (TYP.)
-  CEILING RETURN AIR GRILLE (TYP.)
-  CEILING EXHAUST AIR GRILLE (TYP.)
-  BALANCING DAMPER W/ LOCKING QUADRANT
-  AIR DEVICE - DEVICE TYPE, NECK SIZE, CFM
-  THERMOSTAT, MOUNTED 54" AFF
-  TEMPERATURE AND HUMIDITY SENSORS, MOUNTED 54" AFF.

GENERAL NOTES

1. COORDINATE THE WORK OF THIS SHEET WITH ALL OTHER TRADES PRIOR TO STARTING CONSTRUCTION.
2. ALL LISTED ELEVATIONS ARE TO THE BOTTOM OF DUCT/DEVICE/EQUIPMENT UNLESS OTHERWISE NOTED.
3. REFER TO THE STRUCTURAL DRAWINGS AND SPECIFICATIONS FOR INFORMATION ON THE SEISMIC CLASSIFICATION OF THIS BUILDING. CONTRACTOR IS RESPONSIBLE TO PROVIDE SEISMIC BRACING AS REQUIRED FOR THE MECHANICAL SYSTEMS ON THIS PROJECT. ALL SEISMIC RESTRAINTS SHALL BE DESIGNED AND STAMPED BY A REGISTERED PROFESSIONAL STRUCTURAL ENGINEER.
4. SEE SHEET A-302 FOR EXACT LOCATIONS OF WALL DIFFUSERS IN LOBBY 101.
5. SEE SHEET A-401 FOR EXACT LOCATION OF WALL DIFFUSERS IN RESTROOM AREAS.


KEYED NOTES

- 1 ERV UNIT SUSPENDED TIGHT TO BOTTOM OF TRUSSES.
- 2 14/12 EXHAUST DUCT UP THROUGH ROOF TO ROOF HOOD..
- 3 14/12" INTAKE DUCT UP THROUGH ROOF TO ROOF HOOD..
- 4 PROVIDE 6" PIP HOUSEKEEPING PAD AND ANCHOR CONDENSING UNIT TO PAD WITH EPOXIED-IN BOLTS AT EACH CORNER. FIELD ROUTE CONDENSATE LINES TO INDOOR UNITS. LINES ROUTED THROUGH WALLS OR UNDER SLABS SHALL BE PROVIDED WITH A 4" PVC SLEEVE SEALED WATERTIGHT AT BOTH ENDS.
- 5 COMPUTER ROOM UNIT MOUNTED ON WALL 7" AFF. PROVIDE WIRELESS REMOTE CONTROL IN LOCKING ENCLOSURE AS INDICATED.
- 6 REMOTE MOUNTED TEMPERATURE AND HUMIDITY SENSOR. CONNECT TO THERMOSTAT MOUNTED IN MECHANICAL CHASE.
- 7 AHU MOUNTED ON PRE-FAB RETURN PLENUM BASE W/ FILTER RACK. ROUTE CONDENSATE TO FLOOR DRAIN PROVIDED.
- 8 UNIT HEATER MOUNTED WITH BOTTOM 8" AFF
- 9 CEILING FAN SUSPENDED FROM ROOF STRUCTURE PER MANUFACTURER'S REQUIREMENTS. FAN SHALL BE MOUNTED 12'-8" AFF.
- 10 PROVIDE CHAIN LINK ENCLOSURE AROUND HEAT PUMP UNITS WITH LOCKING GATE AND CHAIN LINK TOP. REFER TO AHTD STANDARD DRAWING WF-3 FOR FENCE CONSTRUCTION DETAILS.
- 11 COORDINATE PLACEMENT OF CONDENSING UNITS/PADS WITH ELECTRICAL AND WATER UTILITIES IN THIS AREA. UNITS SHALL NOT OBSTRUCT ELECTRICAL PANEL FOR A MINIMUM OF 3' IN FRONT OF PANEL, AND SHALL NOT BE SET ON TOP OF BURIED ELECTRICAL CONDUIT OR WATER LINES/VALVES.

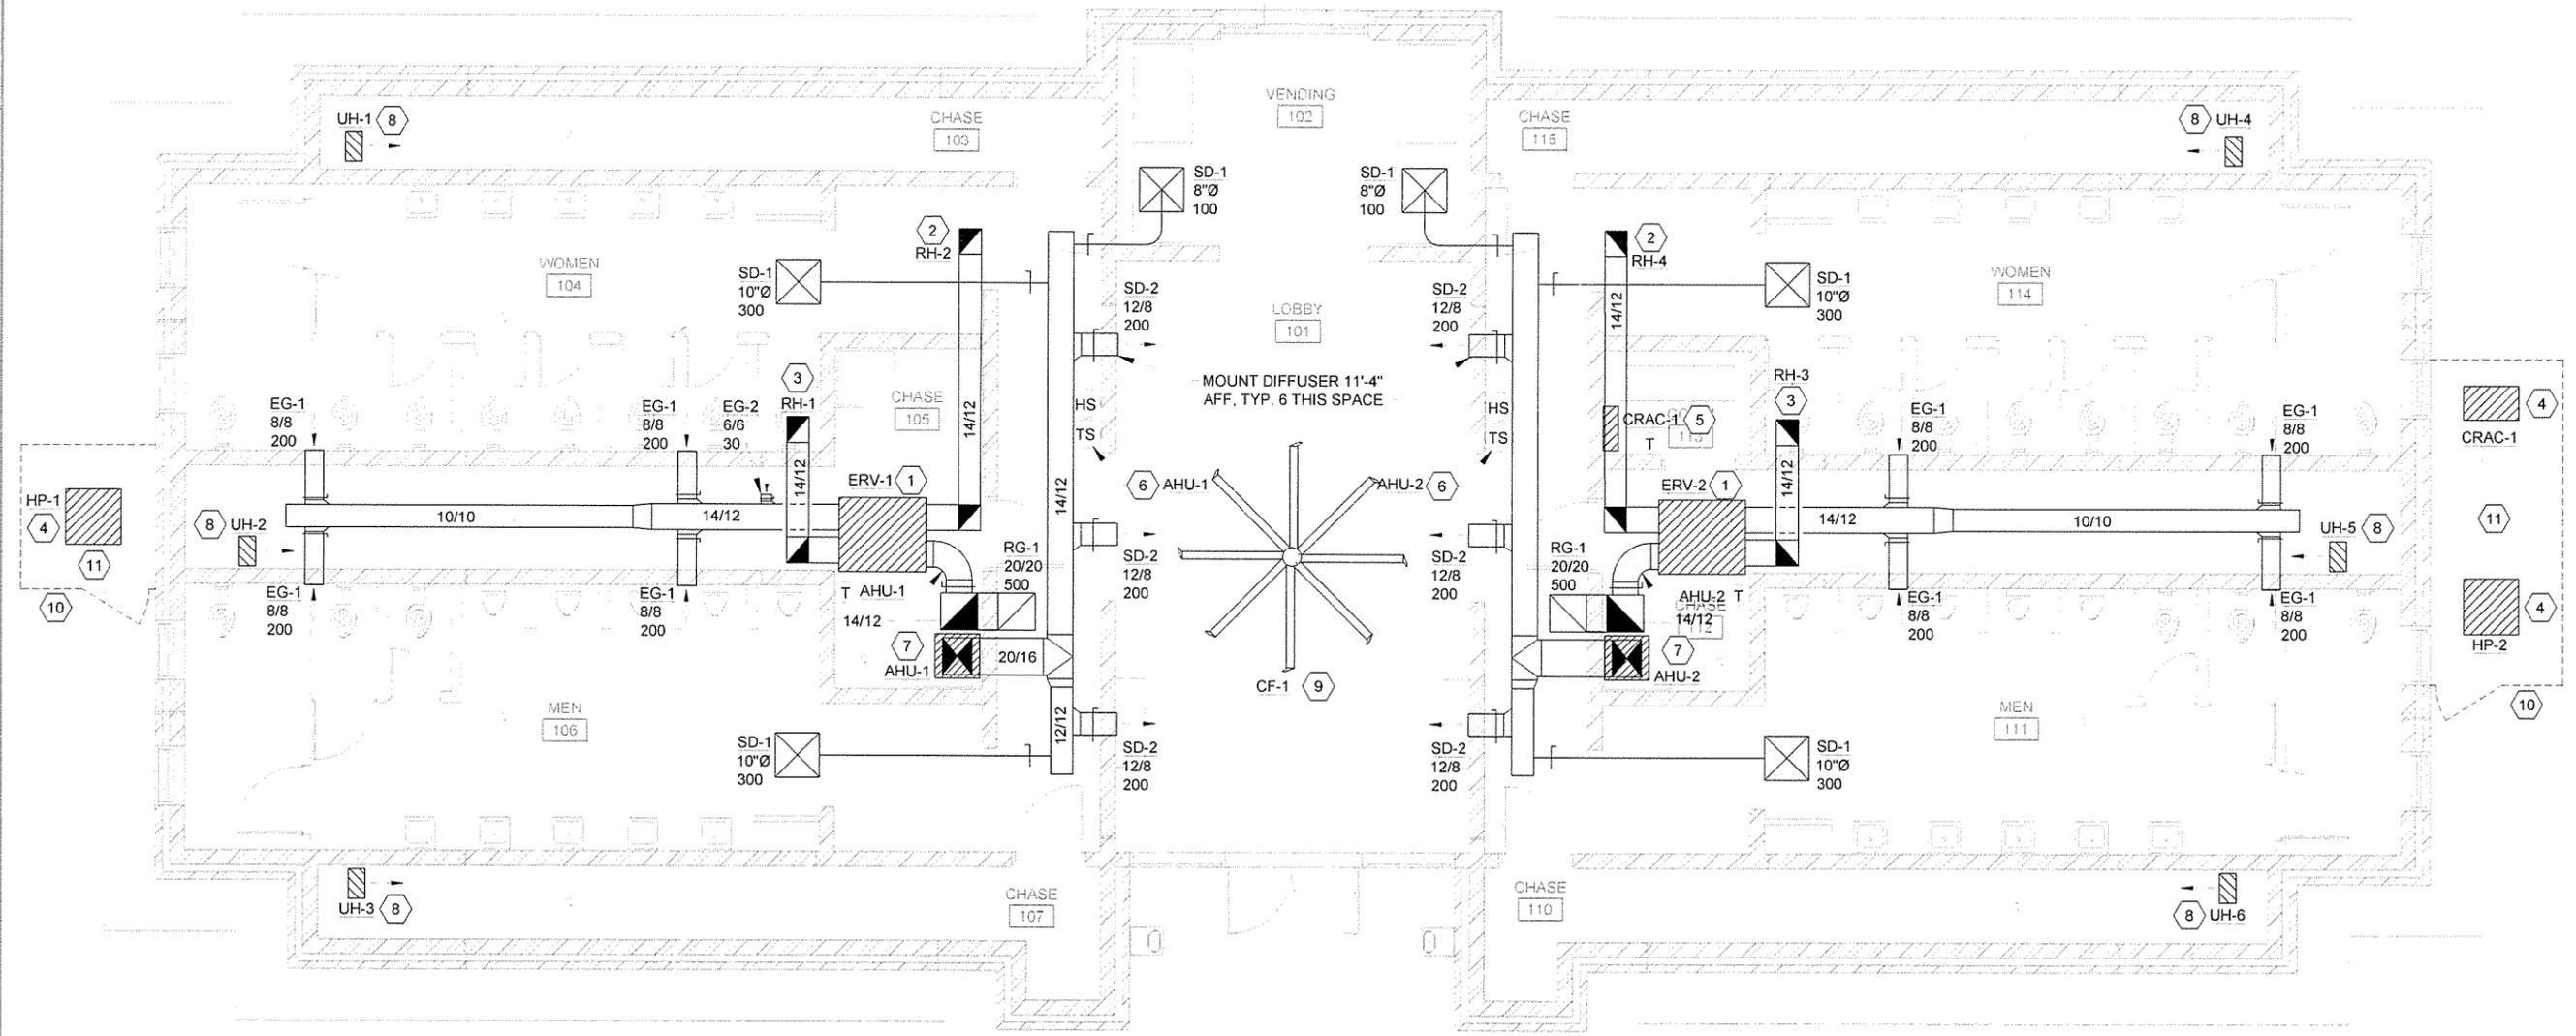

 PROJECT NORTH

 **FLOOR PLAN**
SCALE: 1/4" = 1'-0"

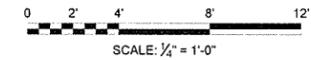

JRR	Appr.
10/1/15	Date
ISSUED FOR CONSTRUCTION	Description
IFC	Symbol

Submitted by:	Job Number:	Director:	Plot Scale:
John T. Williams, III, P.E., S.E.	09Q-451	N/A	1:1
Director, Federal Services			
Drawn by:	Checked by:	File Name:	
L. SUGGS	B. BRADSHAW	AHTSWR-101.DWG	

ARKANSAS HIGHWAY AND TRANSPORTATION DEPARTMENT
 ARKANSAS TOURIST INFORMATION CENTER
 (WHITE RIVER) (S)
 JOB 061451

TOURIST INFORMATION CENTER
 MECHANICAL PLAN

EQUIPMENT SCHEDULE

UH-1 AND UH-2
 REZNOR EGH8 ELECTRIC UNIT HEATER OR EQUAL, 10 KW, 700 CFM, 240 V.
 PROVIDE WITH WALL MOUNTING BRACKET AND MOUNT WITH TOP OF UNIT 12"
 BELOW CEILING. PROVIDE WITH WALL MOUNTED THERMOSTAT.

EF-1
 GREENHECK MODEL SE1-12-432 PROPELLER EXHAUST FAN OR EQUAL, 1200 CFM
 AT 0.25" ESP. 120 V, 1/8 HP. 16" SQUARE WALL OPENING. PROVIDE WITH FLUSH
 EXTERIOR GRAVITY BACKDRAFT DAMPER AND INTERIOR OSHA GUARD.

LVR-1
 RUSKIN MODEL ELC6375DAX COMBINATION LOUVER OR EQUAL, 24"X32" SIZE, 1.94
 SQ. FT. FREE AREA, WITH INTEGRAL DAMPER AND LINKAGE, AND BIRDSCREEN
 KYNAR FINISH TO MATCH BUILDING COLOR. PROVIDE 120 VOLT DAMPER
 ACTUATOR AND INTERLOCK W/ EF-1.

CONTROL NOTES

EF-1:


- FAN SHALL BE CONTROLLED BY AN ADJUSTABLE OPEN ON RISE THERMOSTAT. FAN SHALL ENERGIZE WHEN THE SPACE TEMPERATURE RISES ABOVE THE THERMOSTAT SETPOINT. THERMOSTAT SHALL BE ADJUSTABLE FROM 55°F TO 85°F.
- FAN SHALL ALSO BE PROVIDED WITH A MANUAL OVERRIDE TO ENERGIZE THE FAN MANUALLY WHEN ENGAGED.
- FAN SHALL BE INTERLOCKED WITH LVR-1. LVR-1 SHALL BE OPEN WHEN EF-1 IS ENERGIZED AND CLOSE WHEN EF-1 IS DE-ENERGIZED.

UH-1

- UNIT FAN AND HEATING COIL SHALL ENGAGE WHEN THE WALL MOUNTED THERMOSTAT CALLS FOR HEATING.

GENERAL NOTES

- COORDINATE THE WORK OF THIS SHEET WITH ALL OTHER TRADES PRIOR TO STARTING CONSTRUCTION.
- ALL LISTED ELEVATIONS ARE TO THE BOTTOM OF DUCT/DEVICE/EQUIPMENT UNLESS OTHERWISE NOTED.
- REFER TO THE STRUCTURAL DRAWINGS AND SPECIFICATIONS FOR INFORMATION ON THE SEISMIC CLASSIFICATION OF THIS BUILDING. CONTRACTOR IS RESPONSIBLE TO PROVIDE SEISMIC BRACING AS REQUIRED FOR THE MECHANICAL SYSTEMS ON THIS PROJECT. ALL SEISMIC RESTRAINTS SHALL BE DESIGNED AND STAMPED BY A REGISTERED PROFESSIONAL STRUCTURAL ENGINEER.

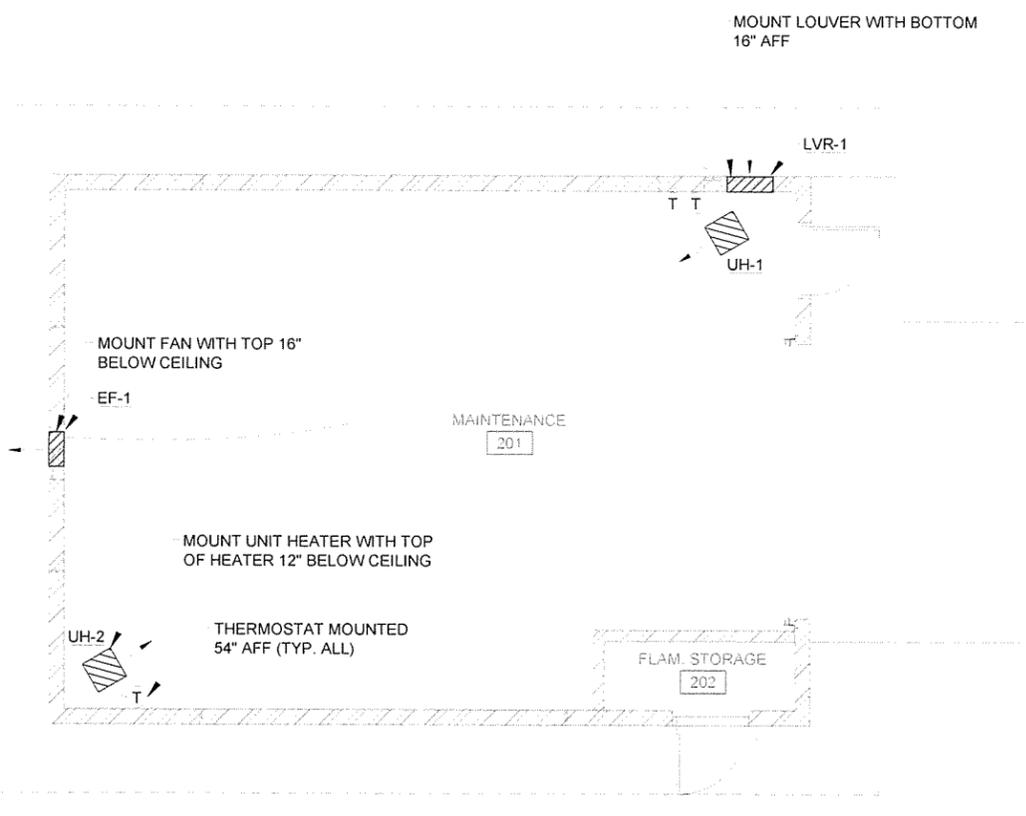

KEYED NOTES


LEGEND

- MECHANICAL EQUIPMENT (TYP.)
- CEILING SUPPLY AIR DIFFUSER (TYP.)
- CEILING RETURN AIR GRILLE (TYP.)
- CEILING EXHAUST AIR GRILLE (TYP.)
- BALANCING DAMPER W/ LOCKING QUADRANT
- SD-1**
10x6
160
AIR DEVICE - DEVICE TYPE, NECK SIZE, CFM
- THERMOSTAT, MOUNTED 54" AFF



1
M-121

FLOOR PLAN
 SCALE: 1/4" = 1'-0"

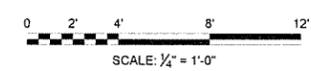

Job Number	060451
Submitted by	John T. Williams, PE, SE Director, Energy Services
Drawn by	L. SUGGS
Checked by	B. BRADSHAW
Plot Date	9/29/15
Plot Scale	1:1
Drwg Code	
File Name	ARTS\VR-1-121.DWG
Issued For Construction	
Date	10/1/15
Appr	JRR

Job Number	060451
Submitted by	John T. Williams, PE, SE Director, Energy Services
Drawn by	L. SUGGS
Checked by	B. BRADSHAW
Plot Date	9/29/15
Plot Scale	1:1
Drwg Code	
File Name	ARTS\VR-1-121.DWG
Issued For Construction	
Date	10/1/15
Appr	JRR

ARKANSAS HIGHWAY AND TRANSPORTATION DEPARTMENT
 ARKANSAS TOURIST INFORMATION CENTER
 (WHITE RIVER) (S)
 -JOB 061451
 MAINTENANCE BUILDING
 MECHANICAL PLAN

Sheet Reference Number:
M-121
 Sheet 104 of 130

EQUIPMENT SCHEDULE

AHU-1
 TRANE TAM4-18 OR EQUAL SPLIT SYSTEM AIR HANDLING UNIT WITH EMERGENCY STRIP HEATING. 550 CFM AIRFLOW AT 0.5" WG ESP, 550 CFM OSA, COOLING CAPACITY 12.0MBH SENSIBLE, 6.9MBH LATENT AT 82F DB/97F WB ENTERING CONDITIONS. HEATING CAPACITY 17.7MBH AT 17F. 3.8 KW ELECTRIC HEATER. FILTER RACK WITH MERV 8 1" FILTER. SINGLE POINT ELECTRICAL, 240 VOLT, 1 PHASE, 23A MCA, 25A MOCAP.

HP-1
 TRANE 4TWR5018 OR EQUAL HEAT PUMP UNIT, 1.5 TONS NOMINAL CAPACITY. 240 VOLT, 1 PHASE, 9A MCA, 15A MOCAP. MINIMUM 14 SEER. PROVIDE WITH SHORT CYCLE TIMER, DEFROST CONTROL.

ERV-1:
 GREENHECK MINICORE-5 ENERGY RECOVERY VENTILATOR OR EQUAL, 550 CFM INTAKE, 550 CFM EXHAUST, 0.5" SP SUPPLY AND EXHAUST FANS, MERV 8 INTAKE AND EXHAUST FILTERS, TOTAL ENTHALPY CORE W/ 61% MINIMUM EFFECTIVENESS AT 98° F DW / 80° F WB. PROVIDE BACKDRAFT DAMPER AND CEILING SUSPENSION KIT. 120V / 17.6A MCA / 25A MOCAP.

UH-1
 REZNOR EGE8 ELECTRIC UNIT HEATER OR EQUAL, 5 KW, 310 CFM, 240 V. PROVIDE WITH WALL MOUNTING BRACKET AND MOUNT WITH TOP OF UNIT 12" BELOW STRUCTURE. PROVIDE WITH INTEGRAL THERMOSTAT SET TO 55° F.

SD-1
 TITUS MODEL SG-1500FL ALUMINUM SECURITY GRILLE OR EQUAL, 10"x10" DUCT SIZE, WITH WELDED ALUMINUM SECURITY CORE AND MOUNTING ANGLES, WHITE FINISH, MAX. NC 25.

EG-1
 TITUS MODEL SG-1500FL ALUMINUM SECURITY GRILLE OR EQUAL, 10"x10" DUCT SIZE, WITH WELDED ALUMINUM SECURITY CORE AND MOUNTING ANGLES, WHITE FINISH, MAX. NC 25.

EG-2
 TITUS MODEL 50F EXHAUST GRILLE OR EQUAL, 6"x6" DUCT CONNECTION, ALUMINUM, WITH EGGRATE CORE AND WHITE FINISH. MAX. NC 25.

LVR-1 AND LVR-2
 RUSKIN MODEL ELF6375X WALL LOUVER OR EQUAL, 16"x 16", 0.88 SQ. FT. FREE AREA, ALUMINUM CONSTRUCTION, BIRDSCREEN, KYNAR FINISH TO MATCH BUILDING COLOR

CONTROL NOTES


- AHU-1 & 2 / HP-1 & 2:**
- UNIT SHALL BE CONTROLLED BY AUTOMATIC HEATING/COOLING CHANGE-OVER 7 DAY PROGRAMMABLE THERMOSTAT/HUMIDISTAT WITH REMOTE TEMPERATURE SENSOR AND HUMIDITY SENSOR LOCATED AS SHOWN ON PLAN. PROVIDE REMOTE SENSORS WITH ANTI-TAMPER ENCLOSURES.
 - AHU FAN SHALL RUN CONTINUOUSLY.
 - THE SYSTEM SHALL RUN IN HEATING / COOLING MODE WHENEVER THE THERMOSTAT CALLS FOR HEATING / COOLING. THE HEAT PUMP WILL ENGAGE IN HEATING / COOLING MODE AS REQUIRED. EMERGENCY ELECTRIC HEATING SHALL BE ACTIVATED ONLY IN THE EVENT OF THE FAILURE OF THE HEAT PUMP TO MAINTAIN A DISCHARGE AIR TEMPERATURE OF 95° F MINIMUM.
 - THE SYSTEM WILL RUN IN DEHUMIDIFICATION MODE WHEN THE HUMIDISTAT CALLS FOR DEHUMIDIFICATION, THE HEAT PUMP SHALL RUN IN COOLING MODE AND THE AIR HANDLER ELECTRIC HEATER WILL STAGE TO PROVIDE ROOM NEUTRAL AIR AS MEASURED BY THE DISCHARGE AIR SENSOR.
 - CALLS FOR HEATING / COOLING WILL TAKE PRIORITY OVER CALLS FOR DEHUMIDIFICATION.

- ERV-1:**
- UNIT FANS SHALL RUN CONTINUOUSLY.

- UH-1**
- UNIT FAN AND HEATING COIL SHALL ENGAGE WHEN THE UNIT-MOUNTED THERMOSTAT CALLS FOR HEATING.

GENERAL NOTES

- COORDINATE THE WORK OF THIS SHEET WITH ALL OTHER TRADES PRIOR TO STARTING CONSTRUCTION.
- ALL LISTED ELEVATIONS ARE TO THE BOTTOM OF DUCT/DEVICE/EQUIPMENT UNLESS OTHERWISE NOTED.
- REFER TO THE STRUCTURAL DRAWINGS AND SPECIFICATIONS FOR INFORMATION ON THE SEISMIC CLASSIFICATION OF THIS BUILDING. CONTRACTOR IS RESPONSIBLE TO PROVIDE SEISMIC BRACING AS REQUIRED FOR THE MECHANICAL SYSTEMS ON THIS PROJECT. ALL SEISMIC RESTRAINTS SHALL BE DESIGNED AND STAMPED BY A REGISTERED PROFESSIONAL STRUCTURAL ENGINEER.
- SEE SHEET A-431 FOR EXACT LOCATION OF WALL DIFFUSERS IN RESTROOM AREAS.

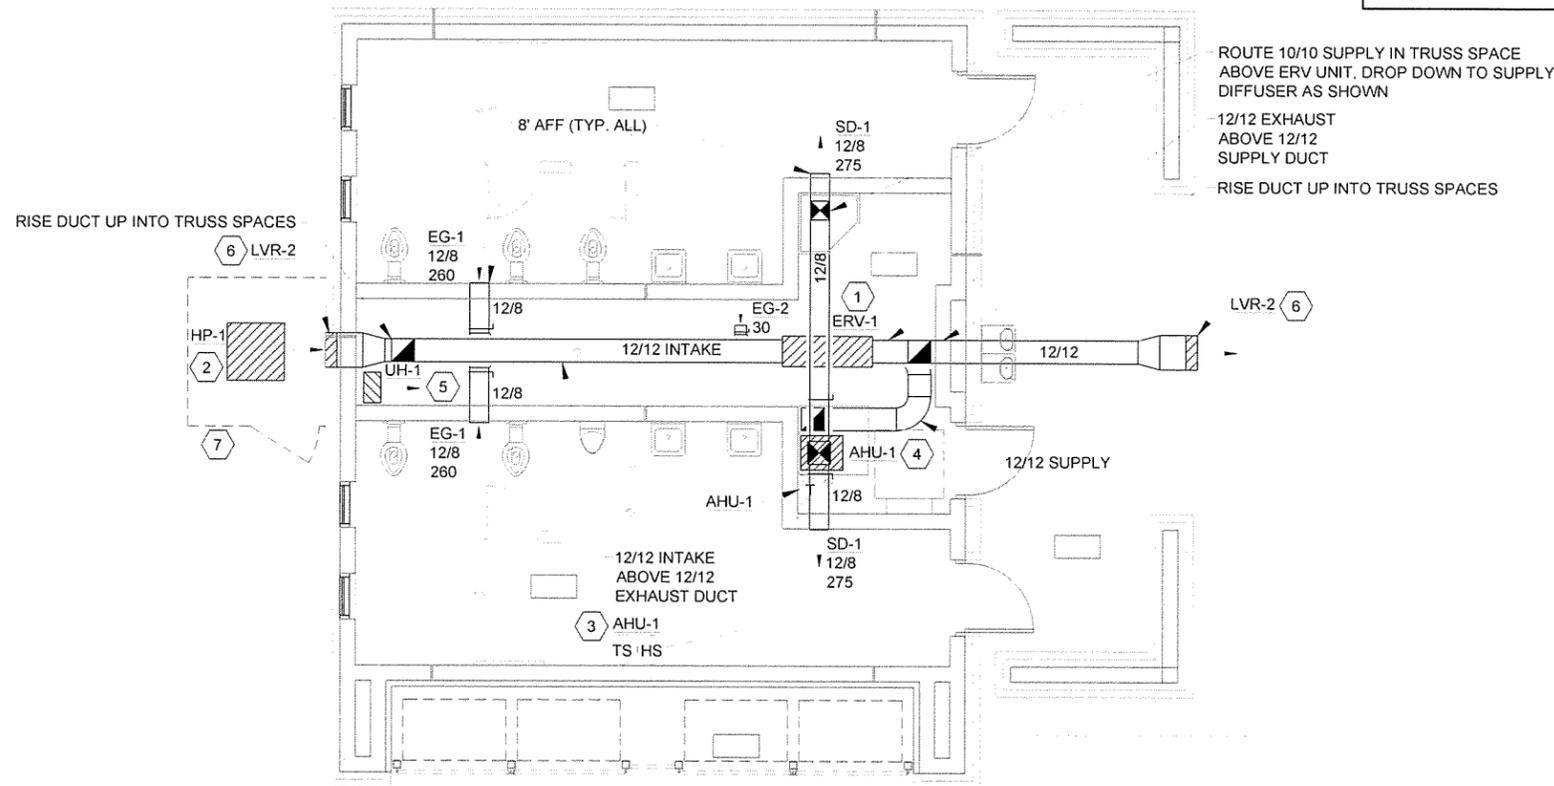

KEYED NOTES

- ERV UNIT SUSPENDED TIGHT TO BOTTOM OF TRUSSES.
- PROVIDE 6" PIP HOUSEKEEPING PAD AND ANCHOR CONDENSING UNIT TO PAD WITH EPOXIED-IN BOLTS AT EACH CORNER. FIELD ROUTE CONDENSATE LINES TO INDOOR UNITS. LINES ROUTED THROUGH WALLS OR UNDER SLABS SHALL BE PROVIDED WITH A 4" PVC SLEEVE SEALED WATERTIGHT AT BOTH ENDS.
- REMOTE MOUNTED TEMPERATURE AND HUMIDITY SENSOR. CONNECT TO THERMOSTAT MOUNTED IN MECHANICAL CHASE.
- AHU MOUNTED ON PRE-FAB RETURN PLENUM BASE W/ FILTER RACK.
- UNIT HEATER MOUNTED WITH TOP 12" BELOW BOTTOM OF STRUCTURE.
- LOUVER MOUNTED HIGH IN GABLE WALL. SEE ARCH. ELEVATIONS FOR EXACT MOUNTING HEIGHT.
- PROVIDE CHAIN LINK ENCLOSURE AROUND HEAT PUMP UNITS WITH LOCKING GATE AND CHAIN LINK TOP. REFER TO AHTD STANDARD DRAWING WF-3 FOR FENCE CONSTRUCTION DETAILS.

LEGEND


- MECHANICAL EQUIPMENT (TYP.)
- CEILING SUPPLY AIR DIFFUSER (TYP.)
- CEILING RETURN AIR GRILLE (TYP.)
- CEILING EXHAUST AIR GRILLE (TYP.)
- BALANCING DAMPER W/ LOCKING QUADRANT
- AIR DEVICE - DEVICE TYPE, NECK SIZE, CFM
- THERMOSTAT, MOUNTED 54" AFF
- TEMPERATURE AND HUMIDITY SENSORS, MOUNTED 54" AFF.



1
M-131

FLOOR PLAN

SCALE: 1/4" = 1'-0"

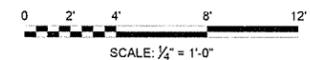

JRR
Appr

10/1/15
Date

ISSUED FOR CONSTRUCTION
Description

IFC
Symbol

Submitted by John T. Watkins, III, P.E., SE Director, Federal Services	Job Number 060451	N/A	N/A	N/A
Drawn by L. SUGGS	Plot Date 9/29/15	Plot Scale 1:1	Draw Code	File Name ARTISVR-M-131.DWG

ARKANSAS HIGHWAY AND TRANSPORTATION DEPARTMENT
 ARKANSAS TOURIST INFORMATION CENTER
 (WHITE RIVER) (S)
 JOB 061451
 TRUCKER-VENDING BUILDING
 MECHANICAL PLAN

Sheet Reference Number:

M-131

Sheet 105 of 130

EQUIPMENT SCHEDULE

AHU-1 / AHU-2
 TRANE TAM4-42 OR EQUAL SPLIT SYSTEM AIR HANDLING UNIT WITH EMERGENCY STRIP HEATING. 1300 CFM AIRFLOW AT 0.5" WG ESP. 875 CFM OSA. COOLING CAPACITY 32.0MBH SENSIBLE, 8.0MBH LATENT AT 80F DB/67F WB ENTERING CONDITIONS, HEATING CAPACITY 26.2MBH AT 17F. 9.6 KW 3-STAGE ELECTRIC HEATER. PRE-FABRICATED RETURN PLENUM BASE W/ FILTER RACK WITH MERV 8 1" FILTER. SINGLE POINT ELECTRICAL, 240 VOLT, 1 PHASE, 53A MCA, 60A MOCP.

HP-1 AND HP-2
 TRANE 4TWR5042 OR EQUAL HEAT PUMP UNIT, 3.5 TONS NOMINAL CAPACITY, 240 VOLT, 1 PHASE, 23A MCA, 40A MOCP. MINIMUM 14 SEER. PROVIDE WITH SHORT CYCLE TIMER, DEFROST CONTROL.

CRAC-1
 LG MODEL LSN090HSV4/LSU090HSV4 OR EQUAL DUCTLESS MINI-SPLIT HEAT PUMP, 350 CFM, 9MBH COOLING CAPACITY, 10.8MBH HEATING CAPACITY, 21 SEER. SINGLE POINT ELECTRICAL, 240 VOLT, 1 PHASE, 10A MCA, 15A MOCP.

ERV-1 / ERV-2:
 GREENHECK ERV-10 ENERGY RECOVERY VENTILATOR OR EQUAL, 875 CFM INTAKE, 830 CFM EXHAUST, 0.5" SP SUPPLY AND EXHAUST FANS, MERV 8 INTAKE AND EXHAUST FILTERS, TOTAL ENTHALPY CORE W/ 58% MINIMUM EFFECTIVENESS AT 98° F DW / 80° F WB. PROVIDE BACKDRAFT DAMPER AND SUSPENSION KIT. 120V / 22A MCA / 30A MOCP.

RH-1 / RH-3
 GREENHECK FGI ROOF INTAKE HOOD OR EQUAL, 18"X18" NECK, 900 CFM, PROVIDE WITH 8" ROOF CURB TO MATCH ROOF CONSTRUCTION, AND BIRDSCREEN. COLOR TO MATCH ROOF.

RH-2 / RH-4
 GREENHECK FGR ROOF EXHAUST HOOD OR EQUAL, 18"X18" NECK, 800 CFM, PROVIDE WITH 8" ROOF CURB TO MATCH ROOF CONSTRUCTION, AND BIRDSCREEN. COLOR TO MATCH ROOF.

UH-1 / UH-2 / UH-3 / UH-4 / UH-5 / UH-6
 REZNOR EGEB ELECTRIC UNIT HEATER OR EQUAL, 5 KW, 310 CFM, 240 V. PROVIDE WITH WALL MOUNTING BRACKET AND MOUNT WITH TOP OF UNIT 8' AFF. PROVIDE WITH INTEGRAL THERMOSTAT SET TO 55° F.

SD-1
 TITUS MODEL TMSA ALUMINUM SUPPLY DIFFUSER OR EQUAL, STEEL, 24"X24" FACE. WHITE FINISH. NECK SIZE AS INDICATED ON PLANS, MAX. NC 25.

SD-2
 TITUS MODEL 300FL SUPPLY DIFFUSER OR EQUAL, 10"X6" DUCT CONNECTION, DOUBLE DEFLECTION, ALUMINUM, WHITE FINISH, MAX. NC 25.

RG-1
 TITUS MODEL 50F RETURN GRILLE OR EQUAL, 24"X24" FACE, ALUMINUM, WITH EGGCRATE CORE AND WHITE FINISH. MAX. NC 25.

EG-1
 TITUS MODEL SG-1500FL ALUMINUM SECURITY GRILLE OR EQUAL, 8"X8" DUCT SIZE, WITH WELDED ALUMINUM SECURITY CORE AND MOUNTING ANGLES. WHITE FINISH, MAX. NC 25.

EG-2
 TITUS MODEL 50F EXHAUST GRILLE OR EQUAL, 6"X6" DUCT CONNECTION, ALUMINUM, WITH EGGCRATE CORE AND WHITE FINISH. MAX. NC 25.

CF-1
 BIG ASS FANS MODEL "ISIS" IS10 CEILING FAN OR EQUAL, 10' DIAMETER, WITH 8 ALUMINUM AIRFOIL BLADES WITH SILVER WINGLETS, GEARLESS DIRECT DRIVE MOTOR, 120V, 1 PHASE, 3.9A. PROVIDE WITH MANUFACTURER'S CONTROL SWITCH MOUNTED IN THE JANITOR'S CLOSET. PROVIDE WITH MANUFACTURER'S STRUCTURAL MOUNTING SYSTEM INCLUDING STABILIZING GUY WIRES, AND INSTALL ACCORDING TO MANUFACTURER'S REQUIREMENTS.


CONTROL NOTES

- AHU-1 & 2 / HP-1 & 2:**
- UNIT SHALL BE CONTROLLED BY AUTOMATIC HEATING/COOLING CHANGE-OVER 7 DAY PROGRAMMABLE THERMOSTAT/HUMIDISTAT WITH REMOTE TEMPERATURE SENSOR AND HUMIDITY SENSOR LOCATED AS SHOWN ON PLAN. PROVIDE REMOTE SENSORS WITH ANTI-TAMPER ENCLOSURES.
 - AHU FAN SHALL RUN CONTINUOUSLY.
 - THE SYSTEM SHALL RUN IN HEATING / COOLING MODE WHENEVER THE THERMOSTAT CALLS FOR HEATING / COOLING. THE HEAT PUMP WILL ENGAGE IN HEATING / COOLING MODE AS REQUIRED. EMERGENCY ELECTRIC HEATING SHALL BE ACTIVATED ONLY IN THE EVENT OF THE FAILURE OF THE HEAT PUMP TO MAINTAIN A DISCHARGE AIR TEMPERATURE OF 95° F MINIMUM.
 - THE SYSTEM WILL RUN IN DEHUMIDIFICATION MODE WHEN THE HUMIDISTAT CALLS FOR DEHUMIDIFICATION, THE HEAT PUMP SHALL RUN IN COOLING MODE AND THE AIR HANDLER ELECTRIC HEATER WILL STAGE TO PROVIDE ROOM NEUTRAL AIR AS MEASURED BY THE DISCHARGE AIR SENSOR.
 - CALLS FOR HEATING / COOLING WILL TAKE PRIORITY OVER CALLS FOR DEHUMIDIFICATION.


- CRAC-1:**
- UNIT SHALL BE CONTROLLED BY AUTOMATIC HEATING/COOLING CHANGE-OVER 7 DAY PROGRAMMABLE THERMOSTAT LOCATED AS SHOWN ON PLAN. AHU FAN SHALL RUN WHENEVER THERMOSTAT CALLS FOR HEATING/COOLING.

- ERV-1 & 2:**
- UNIT FANS SHALL RUN CONTINUOUSLY.


- UH-1 THRU 6**
- UNIT FAN AND HEATING COIL SHALL ENGAGE WHEN THE UNIT-MOUNTED THERMOSTAT CALLS FOR HEATING.

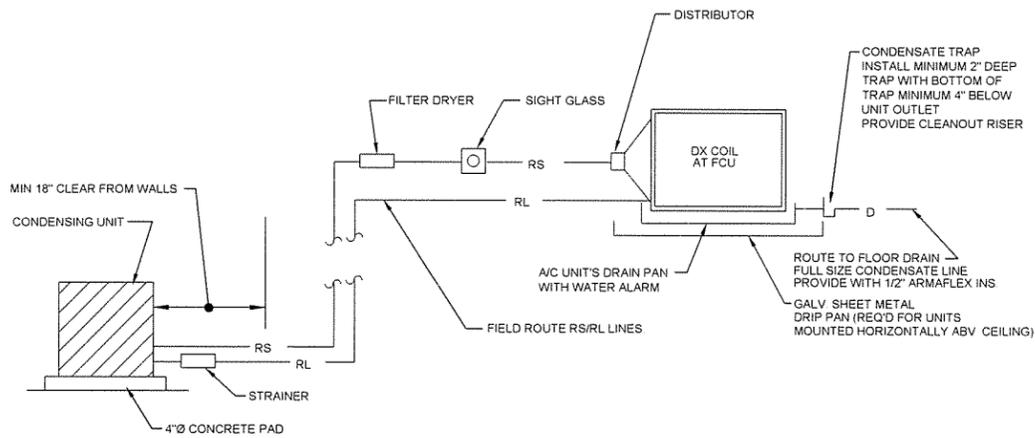


1 SPLIT SYSTEM HEAT PUMP INSTALLATION DETAIL
 SCALE: NONE

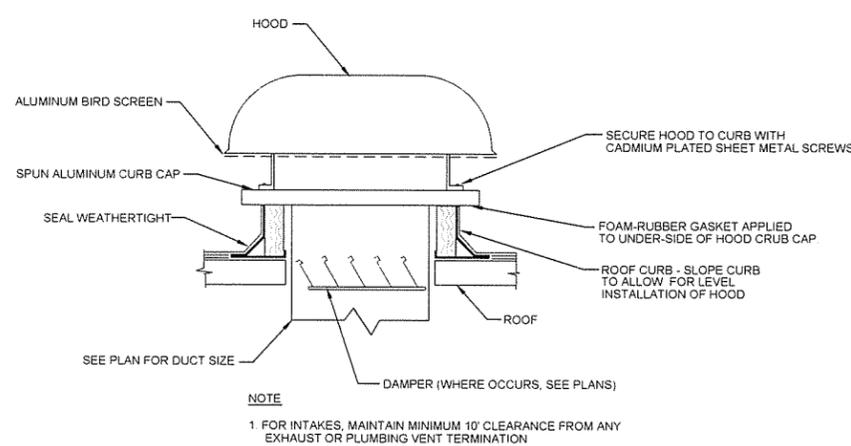

2 ROOF INTAKE / EXHAUST HOOD INSTALLATION DETAIL
 SCALE: NONE

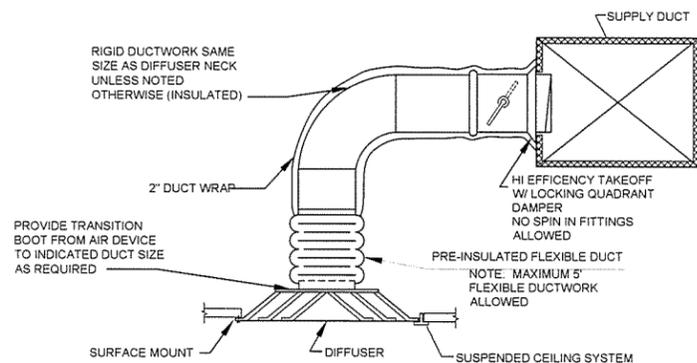

3 SUPPLY DIFFUSER / RETURN/EXHAUST GRILLE DETAIL
 SCALE: NONE

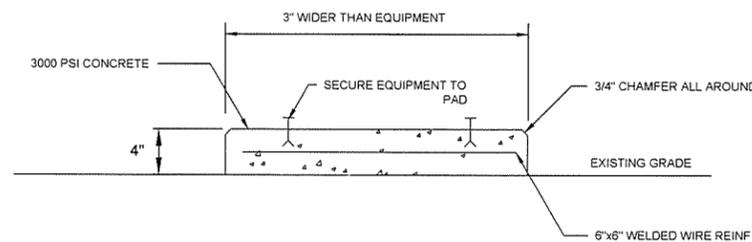

- NOTES:**
- PROVIDE HOUSEKEEPING PADS FOR ALL NEW, GROUND MOUNTED, MECHANICAL EQUIPMENT
 - INSTALL STAINLESS STEEL EXPANSION ANCHORS AND SECURE EQUIPMENT TO PAD
 - DO NOT POUR PAD IN DIRECT CONTACT WITH ANY ADJACENT WALL SURFACES

4 OUTDOOR HVAC EQUIPMENT PAD DETAIL
 SCALE: NONE

GARVER
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 501-376-3633
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CERTIFICATE OF AUTHORIZATION
 GARVER LLC
 No. 766
 ARKANSAS-ENGINEER

STATE OF ARKANSAS
 LICENSED PROFESSIONAL ENGINEER
 No. 11074
 LEE E. SUGGS

ISSUED FOR CONSTRUCTION	IFC Symbol
Date	10/1/15
Appr.	JRR


Submitted by	John T. Williams, III, P.E., SE	Director, Regional Services
Designed by	L. SUGGS	
Drawn by	L. SUGGS	
Checked by	B. BRADSHAW	
File Name	ARTSR-M-201.DWG	
Job Number	060451	
Plot Date	9/29/15	
Plot Scale	1:1	
Drwg Code		

ARKANSAS HIGHWAY AND TRANSPORTATION DEPARTMENT
 ARKANSAS TOURIST INFORMATION CENTER
 (WHITE RIVER) (S)
 JOB 060451


TOURIST INFORMATION CENTER
 MECHANICAL DETAILS



4701 Northshore Drive
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LEGEND

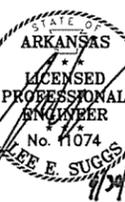

ABBREVIATIONS

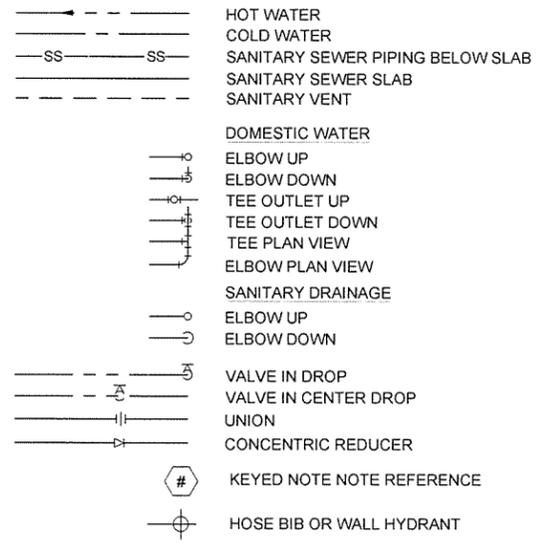COTG	CLEANOUT TO GRADE
TWCOTG	TWO-WAY CLEANOUT TO GRADE
CO	INTERIOR CLEANOUT
VTR	VENT THROUGH ROOF
FD	FLOOR DRAIN
AFF	ABOVE FINISHED FLOOR
AFG	ABOVE FINISHED GRADE
CW	DOMESTIC COLD WATER
HW	DOMESTIC HOT WATER
DWV	DRAIN WASTE AND VENT
GPM	GALLONS PER MINUTE
GPF	GALLONS PER FLUSH
DFU	DRAIN FIXTURE UNITS
WFU	WATER FIXTURE UNITS
OD	OUTSIDE DIAMETER
I.P.S.	IRON PIPE SIZE
WHA	WATER HAMMER ARRESTOR

VALVE SYMBOLS



FINAL FIXTURE INSTALLATION NOTE:

- THE CONTRACTOR IS CAUTIONED THAT CEILING, WALL, AND FLOOR COATING SYSTEMS WILL BE APPLIED TO ALL RESTROOM SURFACES. THRU-WALL ROUGH-IN FOR FIXTURES MAY OCCUR AT THE CONTRACTOR'S DISCRETION, WHETHER DURING INSTALLATION OR AFTER THE CONCRETE MASONRY WALLS ARE INSTALLED, BUT FINAL INSTALLATION OF WALL HUNG AND CARRIER MOUNTED FIXTURES SHALL ONLY OCCUR AFTER THE CEILING, WALL AND FLOOR COATINGS ARE COMPLETE.

PLUMBING MATERIALS NOTES:

- DOMESTIC WATER PIPING ABOVE SLAB SHALL BE TYPE 'L' DRAWN COPPER WITH WROUGHT COPPER FITTINGS AND LEAD FREE SOLDER JOINTS OR MECHANICAL "PRO-PRESS" TYPE FITTINGS. ROUTE IN CHASES AS INDICATED ON THE DRAWINGS. DO NOT INSTALL ABOVE CEILING.
- INSULATE ALL ABOVE SLAB DOMESTIC WATER WITH 1/2 INCH THICK FLEXIBLE UNICELLULAR INSULATION (ARMAFLEX OR EQUAL).
- ALL DOMESTIC WATER BELOW SLAB SHALL BE PLASTIC COATED TYPE 'K' COPPER TUBE WITH NO FITTINGS.
- SANITARY SEWER PIPING ABOVE FINISH FLOOR SHALL BE SCHEDULE 40 PVC DWV EXCEPT FOR WATER CLOSET CARRIER FITTINGS. SLOPE ALL PIPING 3" AND LARGER IN SIZE AT 1/8 INCH PER FOOT. SLOPE ALL PIPING LESS THAN 3" SIZE AT 1/4 INCH PER FOOT.
- SANITARY SEWER PIPING BELOW FINISH FLOOR OR GRADE SHALL BE SCHEDULE 40 PVC DWV. SLOPE ALL PIPING 3" AND LARGER IN SIZE AT 1/8 INCH PER FOOT. SLOPE ALL PIPING LESS THAN 3" SIZE AT 1/4 INCH PER FOOT.
- ALL MOUNTING HARDWARE, THRU BOLTS, NUTS, CAP NUTS, WASHERS, BACKER PLATES, ETC. SHALL BE TYPE 316 STAINLESS STEEL.
- ALL WATER CLOSET CARRIERS SHALL BE COATED CAST IRON WITH APPROPRIATE HARDWARE. PAINT ALL CAST IRON PARTS TO MINIMIZE OXIDATION PROCESS.

PLUMBING CLEANOUT NOTES:

- FLOOR CLEANOUT (FCO), CLEANOUT TO GRADE WHERE APPLICABLE (COTG), AND TWO-WAY CLEANOUT TO GRADE (TWCOTG) SHALL BE ZURN Z1400-Z WITH BRONZE PLUG OR EQUAL.

GENERAL PLUMBING NOTES:

- PROVIDE ALL REQUIRED PIPE, FITTING, VALVES, HANGERS, SUPPORTS, SLEEVES, INSERTS, TRAPS AND OTHER SUCH EQUIPMENT, ITEMS AND DEVICES, AS MAY BE REQUIRED FOR A COMPLETE AND OPERATING SYSTEM OR SYSTEMS, INCLUDING ALL POINTS AUXILIARY TO THE SYSTEM OR SYSTEMS WHETHER OR NOT SPECIFICALLY SET FORTH HEREIN AND/OR SHOWN ON THE DRAWINGS.
- WORK SHALL BE EXECUTED AND INSPECTED IN ACCORDANCE WITH LOCAL AND STATE CODES, LAWS, ORDINANCES, RULES AND REGULATIONS APPLICABLE TO THE PARTICULAR CLASS OF WORK AND ANY FEES IN CONNECTION THEREWITH SHALL BE PAID BY THE CONTRACTOR.
- ALL PLUMBING SHALL BE INSTALLED IN ACCORDANCE WITH THE 2006 ARKANSAS STATE PLUMBING CODE AND IN COMPLIANCE WITH THE REQUIREMENTS OF THE LOCAL AUTHORITY HAVING JURISDICTION.
- ALL DRAWINGS ARE DIAGRAMMATIC AND INDICATE THE GENERAL ARRANGEMENTS OR GEOMETRICAL RELATIONSHIPS OF EQUIPMENT AND SERVICES. THEY ARE NOT INTENDED TO SPECIFY OR SHOW EVERY OFFSET, SEQUENCE, DEVICE, OPTION, FITTING, OR COMPONENT.
- INFORMATION AND COMPONENTS SHOWN ON RISER DIAGRAMS OR DETAILS, BUT NOT SHOWN ON PLANS, AND VICE VERSA, SHALL BE PROVIDED AS IF EXPRESSLY REQUIRED BY BOTH.
- UNLESS NOTED OTHERWISE, THE INDICATION AND/OR DESCRIPTION OF ANY ITEM, IN THE DRAWINGS OR SPECIFICATIONS CARRIES WITH IT THE INSTRUCTION TO PROVIDE THE ITEM.
- CONTRACTOR WILL BE RESPONSIBLE FOR COORDINATING ALL WORK WITH THAT OF OTHER TRADES. REFER TO ARCHITECTURAL, ELECTRICAL, AND OTHER DRAWINGS FOR COMPLETE INFORMATION.
- INSTALL ALL EXPOSED PLUMBING PIPING ALONG UTILITY CHASE WALLS AS CLOSE TO THE CHASE WALLS AS POSSIBLE FOR MAXIMUM OWNER MAINTENANCE SPACE AND CLEAR FLOOR SPACE. INSTALL ALL EXPOSED OVERHEAD LINES AS HIGH AS POSSIBLE. REFER TO DETAILS ON PLANS FOR EXPECTED CLEARANCES FROM UTILITY CHASE WALLS.
- THE STRUCTURE(S) WITHIN THIS DESIGN PACKAGE ARE EXPECTED TO HAVE THE INTERIORS HOSED DOWN FOR CLEANING ON A REGULAR BASIS. TO THAT END, NEATLY AND CONTINUOUSLY SEAL WITH CLEAR SILICONE SEALANT AROUND ALL NEW WALL HUNG, STAINLESS STEEL LAVATORIES, WALL HUNG, STAINLESS STEEL URINALS AND WALL HUNG, CARRIER MOUNTED, STAINLESS STEEL WATER CLOSETS.
- COORDINATE WITH MASONRY CONTRACTOR TO ENSURE ALL CONCRETE MASONRY UNITS LOCATED AT WALL HUNG FIXTURES AND WATER CLOSET CARRIER BOLTS ARE GROUTED.
- NEATLY CABLE-TIE ALL LOW VOLTAGE WRING TO WALLS. BUNDLE MULTIPLE CABLES TOGETHER WHERE APPLICALE.

ISSUED FOR CONSTRUCTION	IFC Symbol
Date	10/1/15
Appr	JRR

Submitted by	Job Number
John T. Williams, PE, SE Director, Field Services	060451
Plat Date	Plot Scale
9/29/15	1:1
Drawn by	Checked by
K. SULLIVAN	B. BRADSHAW
Draw Code	File Name
	HT1514R-P-01.DWG

ARKANSAS HIGHWAY AND TRANSPORTATION DEPARTMENT
 ARKANSAS TOURIST INFORMATION CENTER
 (WHITE RIVER) (S)
 JOB 060451
 LEGEND, ABBREVIATIONS AND NOTES


Sheet Reference Number:
P-001
 Sheet 107 of 130

GENERAL NOTES

1. GENERAL NOTES


KEYED NOTES

- 1 SEE SITE PLAN FOR CONTINUATION. ESTIMATED DEMAND IS 81 DFU.
- 2 COORDINATE CONCRETE BLOCKOUT AS MAY BE REQUIRED FOR HORIZONTAL PIPING AND HORIZONTAL-TO-VERTICAL CONNECTION FITTING WITH FOUNDATION INSTALLER.
- 3 SLEEVE THROUGH STRUCTURAL STEM WALL. REFER TO STRUCTURAL SHEETS FOR EXTERIOR WALL FOUNDATION SECTIONS.

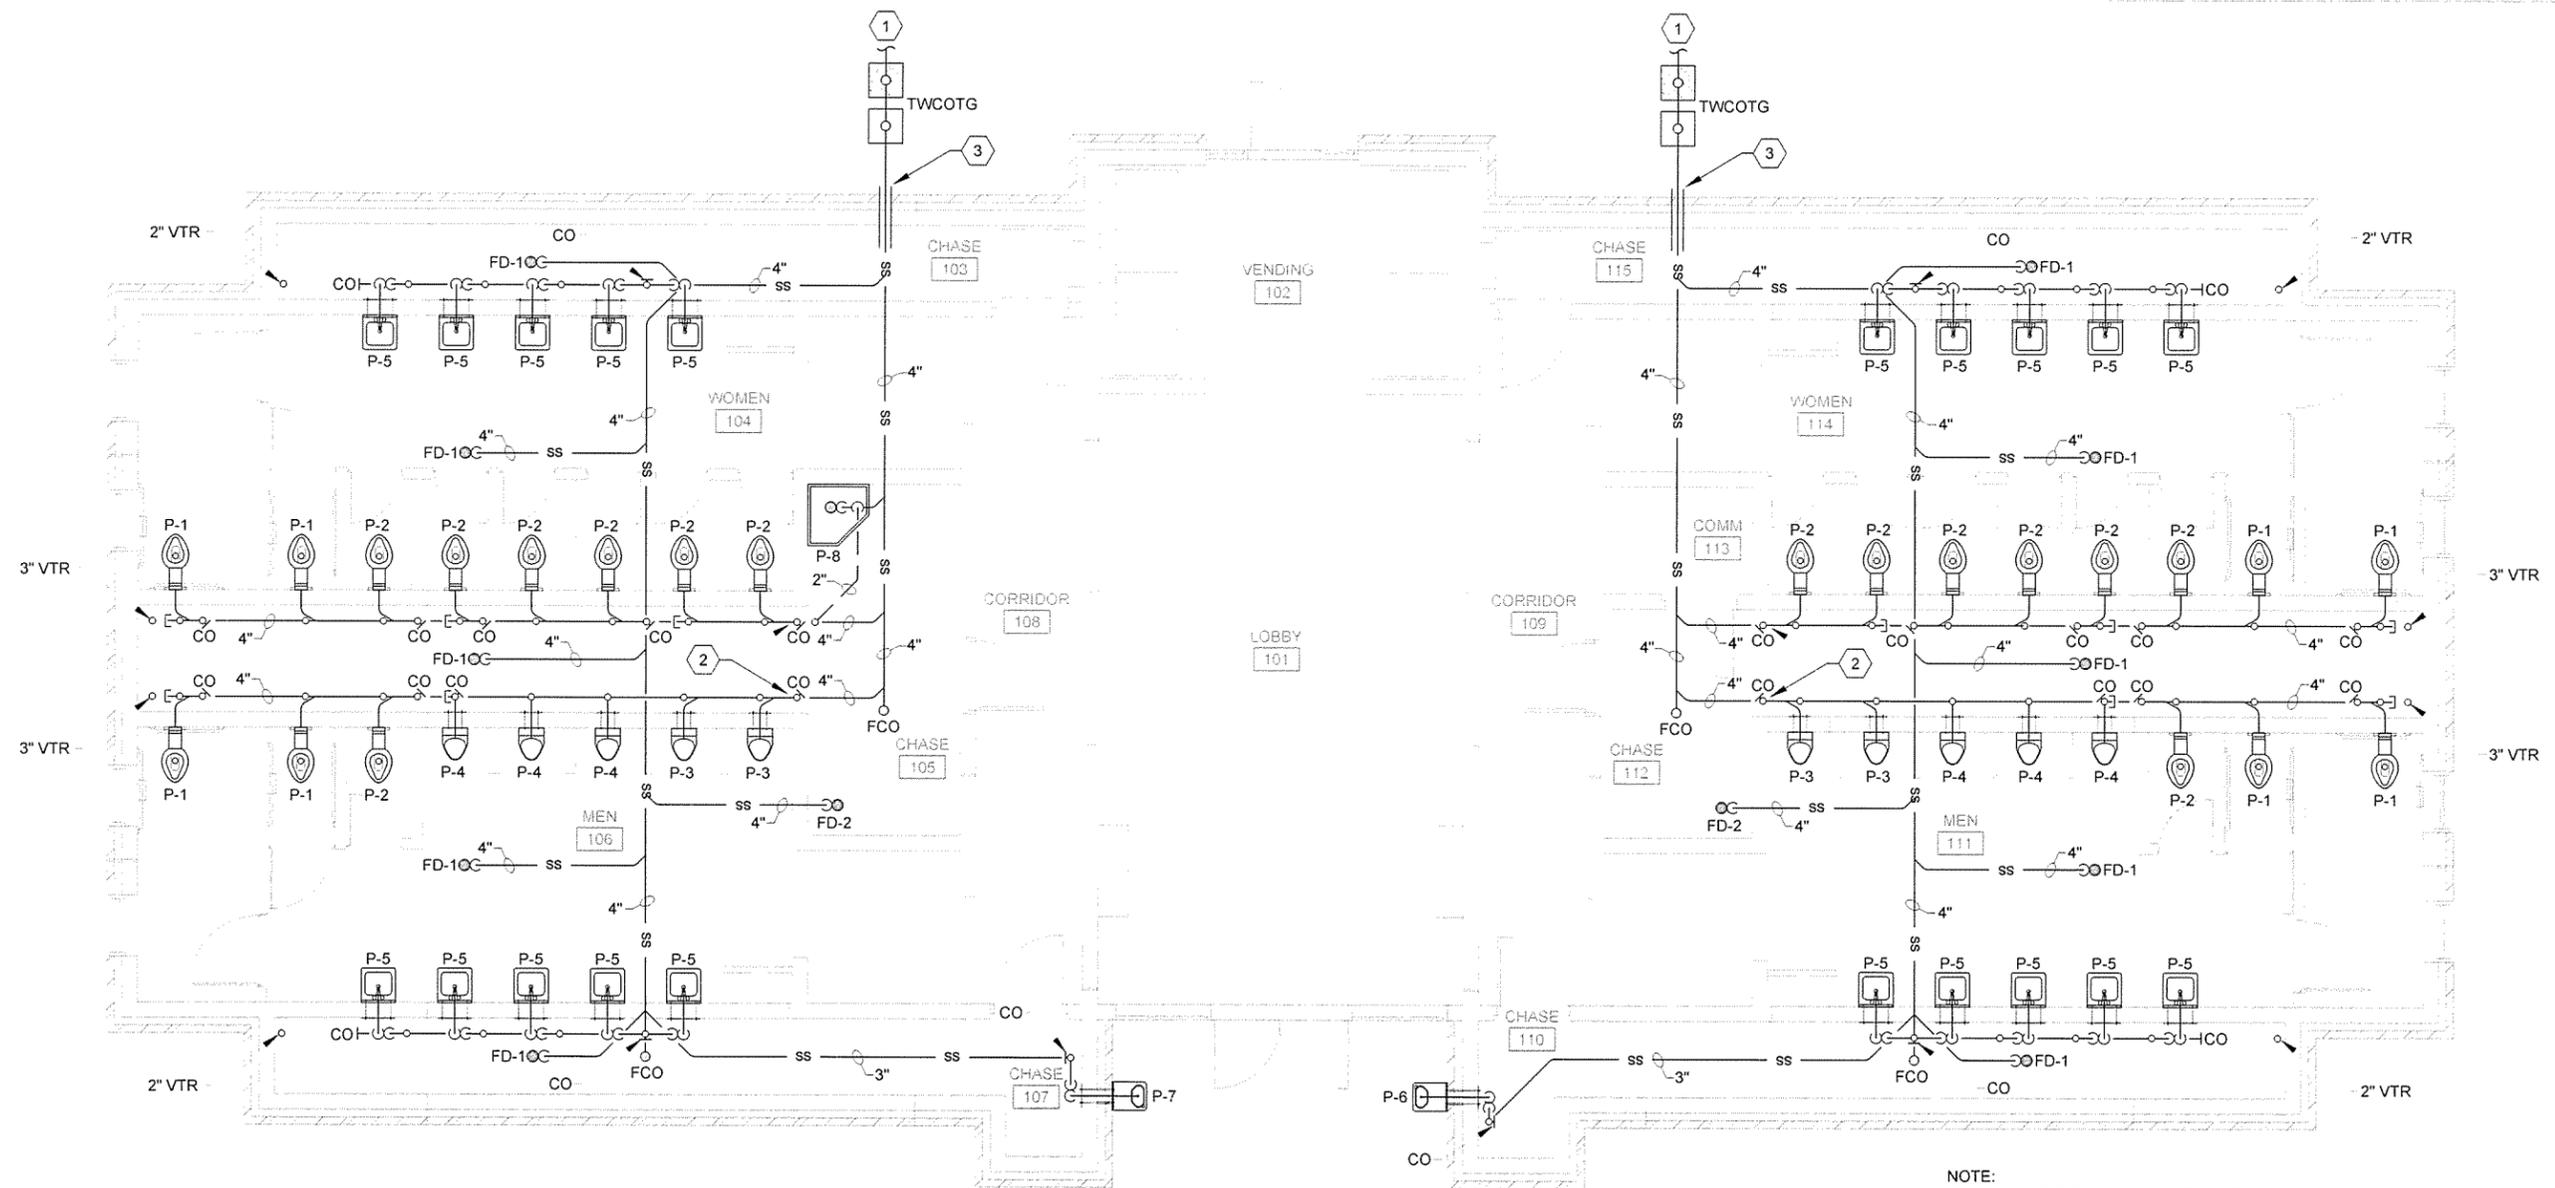

NOTE:
THIS PLAN IS TYPICAL FOR BOTH THE
EAST BOUND AND WEST BOUND TOURIST
INFORMATION CENTERS.

1 TOURIST INFORMATION CENTER - SANITARY SEWER PIPING PLAN
P-101 SCALE: 1/4" = 1'-0"

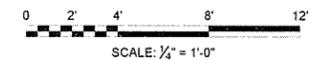

ISSUED FOR CONSTRUCTION	IFC Symbol
Date	Date
Appr.	Appr.


Job Number	060451
Submitted by	John T. Williams Services
Director	N/A
Plot Scale	1:1
Plot Date	9/28/15
Drug Code	N/A
Designed by	K. SULLIVAN
Drawn by	K. SULLIVAN
Checked by	B. BRADSHAW
File Name	ARHSMP-P-101.DWG

ARKANSAS HIGHWAY AND TRANSPORTATION DEPARTMENT
 ARKANSAS TOURIST INFORMATION CENTER
 (WHITE RIVER) (S)
 JOB 06 0451
 TOURIST INFORMATION CENTER
 SANITARY SEWER PIPING PLAN

GENERAL NOTES


KEYED NOTES

- 1 SEE SITE PLAN FOR CONTINUATION. ESTIMATED DEMAND IS 141 WFU. PER TABLE E103.3(3) - 77 GPM.
- 2 INSTALL FULL PORT BALL VALVE AT SERVICE ENTRANCE INTO UTILITY CHASE.
- 3 SLEEVE THROUGH STRUCTURAL STEM WALL. REFER TO STRUCTURAL SHEETS FOR EXTERIOR WALL FOUNDATION SECTIONS.
- 4 INSTALL WATER CHILLER FOR DRINKING FOUNTAIN ON SPECIFIED SHELF AS NOTED IN FIXTURE SCHEDULE, SHEET P-601.
- 5 SEE SITE PLAN FOR CONTINUATION. ESTIMATED DEMAND IS 16 WFU. PER TABLE E103.3(3) - 18 GPM.

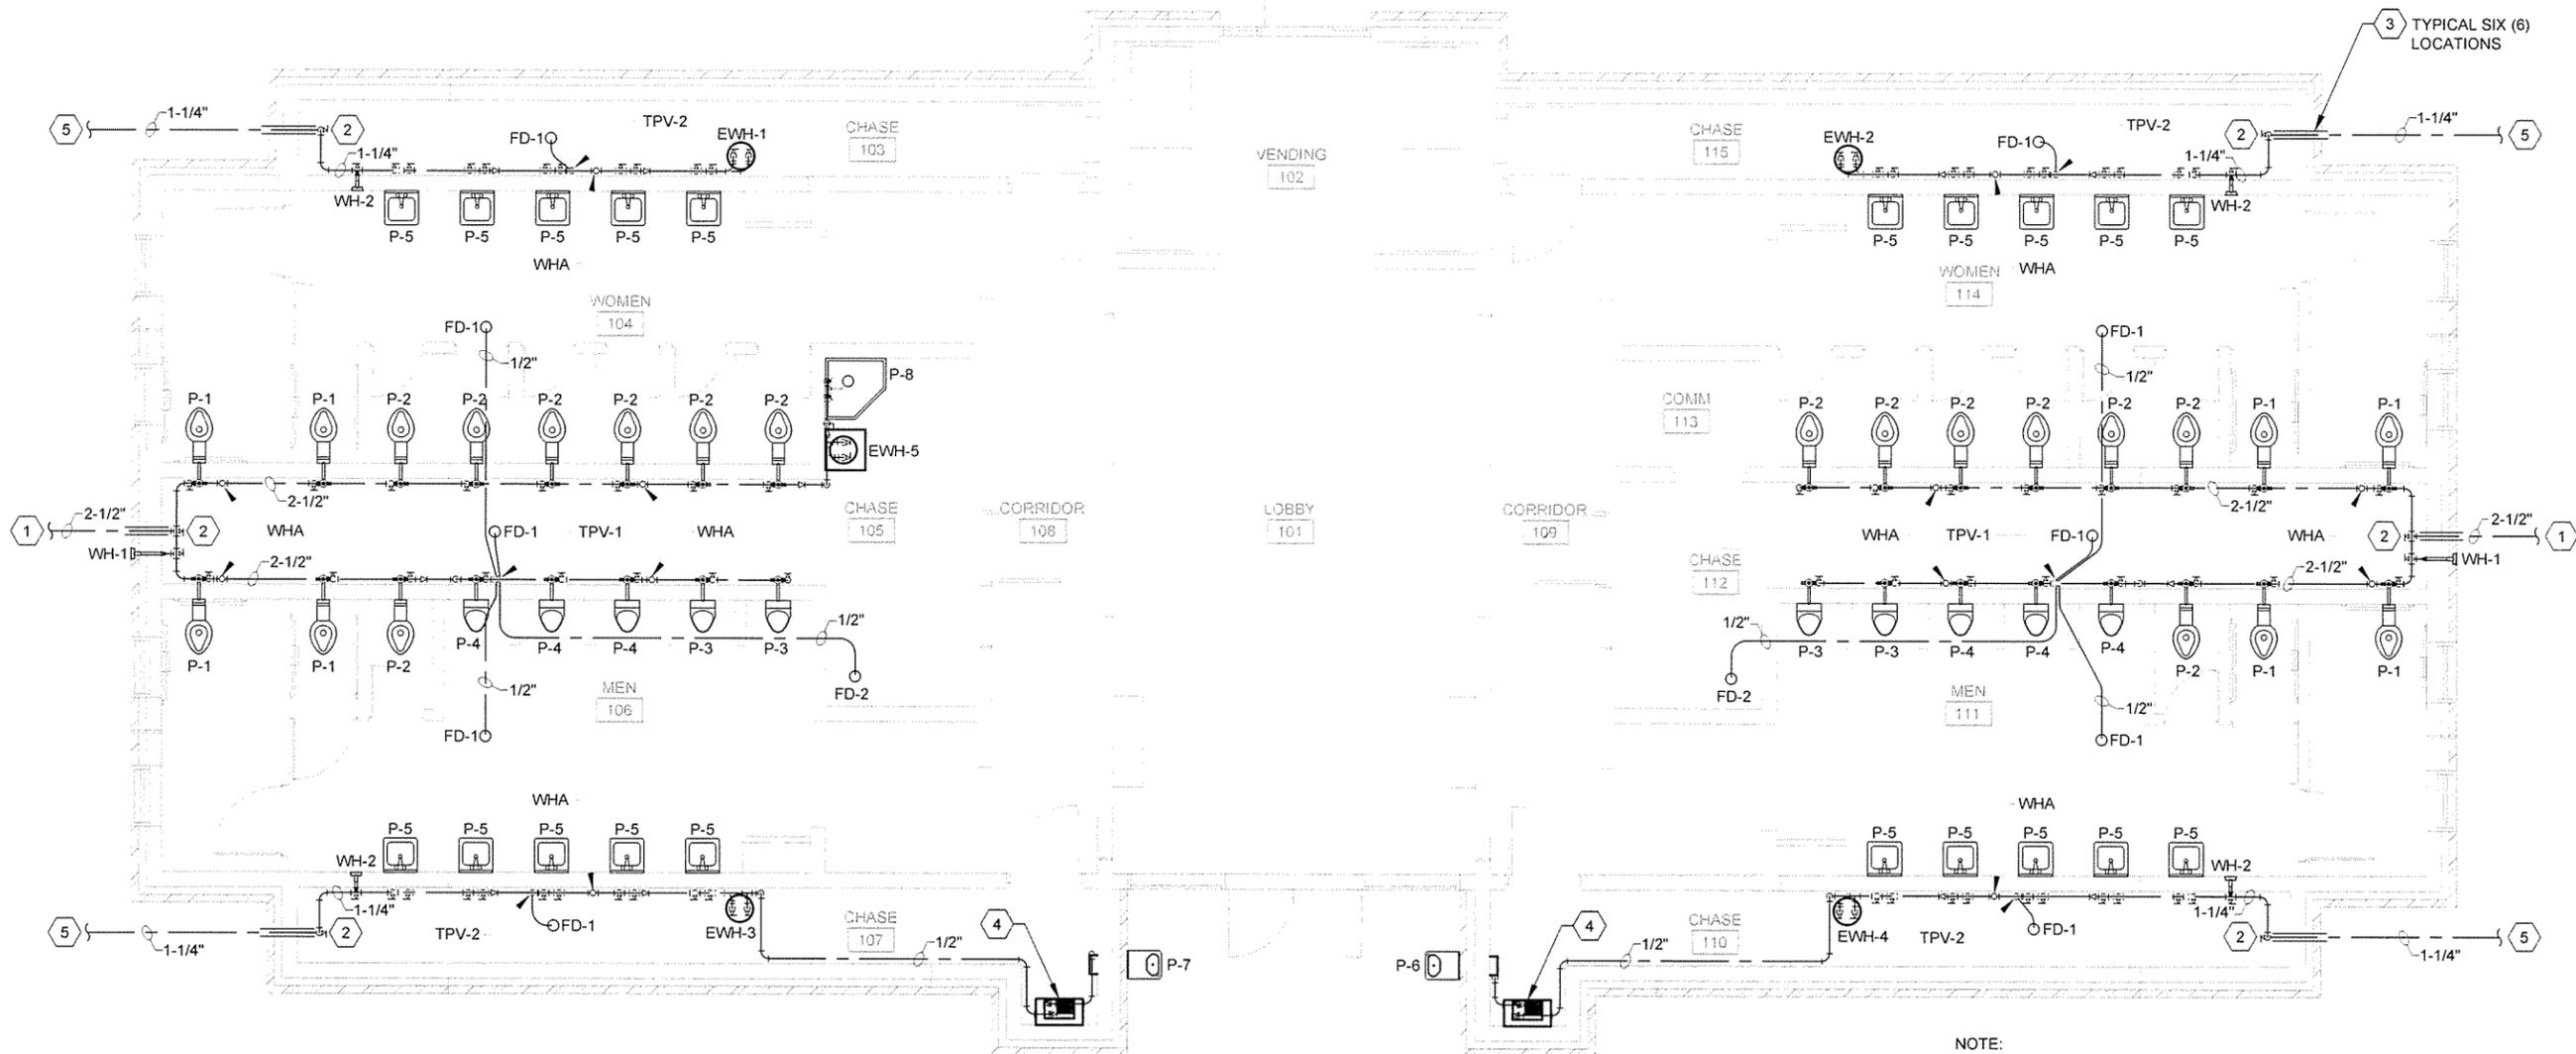

NOTE:
THIS PLAN IS TYPICAL FOR BOTH THE
EAST BOUND AND WEST BOUND TOURIST
INFORMATION CENTERS.

1 TOURIST INFORMATION CENTER - DOMESTIC WATER PIPING PLAN
P-102 SCALE: 1/4" = 1'-0"

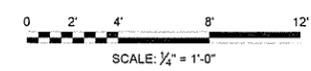

ISSUED FOR CONSTRUCTION		JRR
Description		Date
IFC Symbol		10/11/15
Job Number	060451	
Submitted by	John T. Vignola, PE, SE Director, Technical Services	
Drawn by	K. SULLIVAN	
Checked by	B. BRADSHAW	
Plot Date	9/29/15	
Plot Scale	1:1	
Drug Code		
File Name	AR\308R-P-102.DWG	
ARKANSAS HIGHWAY AND TRANSPORTATION DEPARTMENT ARKANSAS TOURIST INFORMATION CENTER (WHITE RIVER) (S) JOB 06 0451		
TOURIST INFORMATION CENTER DOMESTIC WATER PIPING PLAN		
Sheet Reference Number:		P-102
Sheet 109 of 130		


GENERAL NOTES

1. GENERAL NOTES




KEYED NOTES

- 1 SEE SITE PLAN FOR CONTINUATION. ESTIMATED DEMAND IS 37 DFU.
- 2 SLEEVE THROUGH STRUCTURAL STEM WALL. REFER TO STRUCTURAL SHEETS FOR EXTERIOR WALL FOUNDATION SECTIONS.

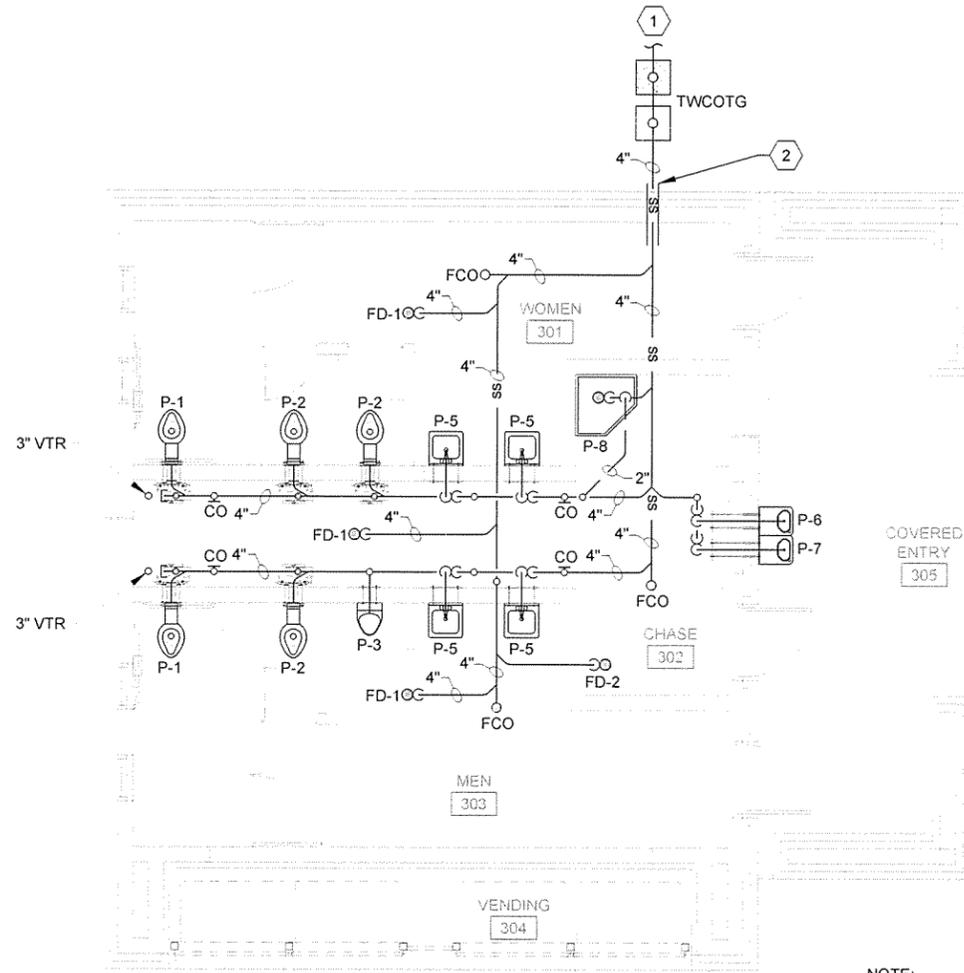

NOTE:
THIS PLAN IS TYPICAL FOR BOTH THE
EAST BOUND AND WEST BOUND
TRUCKER-VENDING BUILDINGS.

1 TRUCKER-VENDING BUILDING - SANITARY SEWER PIPING PLAN
P-131 SCALE: 1/4" = 1'-0"

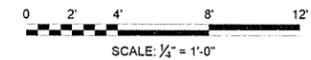


JRR	Appr
10/1/15	Date
ISSUED FOR CONSTRUCTION	Description
IFC	Symbol

Job Number	060451
Submitted by	John T. Valenzuela, PE, SE Director, Pipelife Services
Plot Date	9/29/15
Plot Scale	1:1
Designed by	K. SULLIVAN
Drawn by	K. SULLIVAN
Checked by	B. BRADSHAW
File Name	AR15NR-P-131 DWG

ARKANSAS HIGHWAY AND TRANSPORTATION DEPARTMENT
ARKANSAS TOURIST INFORMATION CENTER
(WHITE RIVER) (S)
JOB 061451


TRUCKER-VENDING BUILDING
SANITARY SEWER PIPING PLAN

Sheet Reference Number:
P-131
Sheet 110 of 130

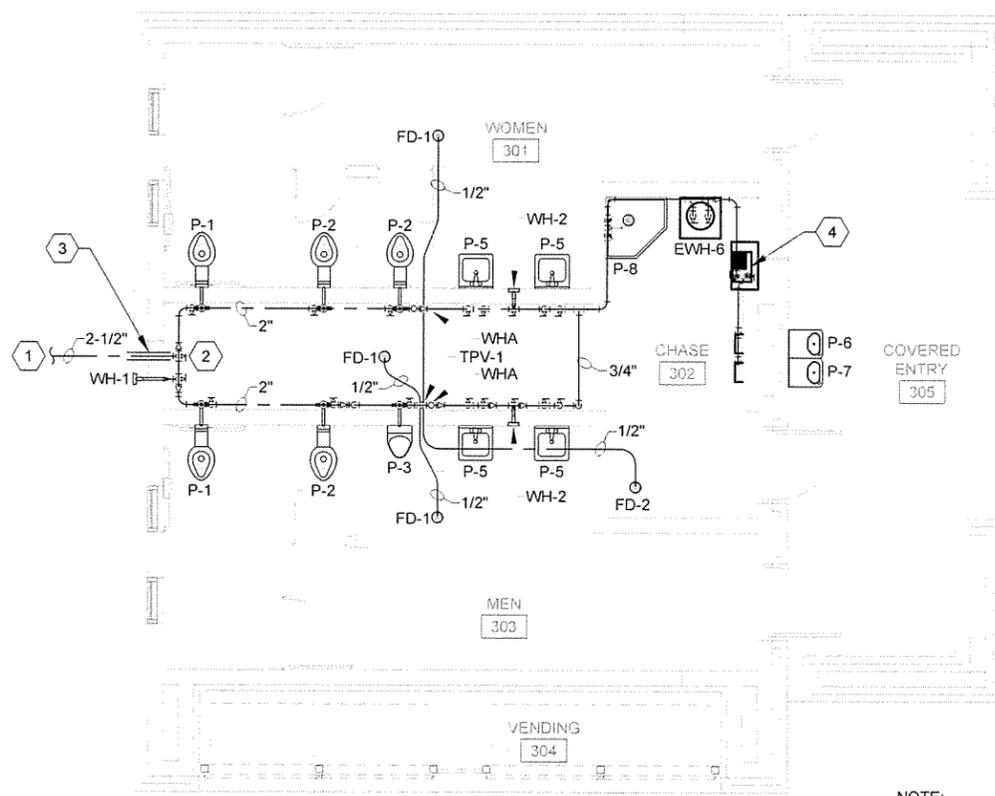

NOTE:
THIS PLAN IS TYPICAL FOR BOTH THE
EAST BOUND AND WEST BOUND
TRUCKER-VENDING BUILDINGS.

1
P-132 TRUCKER-VENDING BUILDING - DOMESTIC WATER PIPING PLAN
SCALE: 1/4" = 1'-0"

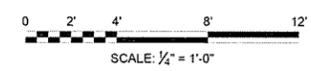

GENERAL NOTES

1. GENERAL NOTES

KEYED NOTES

- 1 SEE SITE PLAN FOR CONTINUATION. ESTIMATED DEMAND IS 80 WFU. PER TABLE E103.3(3) - 61 GPM.
- 2 INSTALL FULL PORT BALL VALVE AT SERVICE ENTRANCE INTO UTILITY CHASE.
- 3 SLEEVE THROUGH STRUCTURAL STEM WALL. REFER TO STRUCTURAL SHEETS FOR EXTERIOR WALL FOUNDATION SECTIONS.
- 4 INSTALL WATER CHILLER FOR DRINKING FOUNTAIN ON SPECIFIED SHELF AS NOTED IN FIXTURE SCHEDULE, SHEET P-601.




JRR	Appr.
10/11/15	Date
ISSUED FOR CONSTRUCTION	Description
IFC	Symbol

Job Number 060451	Submitted by John Director, Federal Services	Plot Date 9/29/15	Plot Scale 1:1	Job Code N/A	Drug Code N/A	File Name AHS15RR-P-132.DWG
Designed by K. SULLIVAN	Drawn by K. SULLIVAN	Checked by B. BRADSHAW				

ARKANSAS HIGHWAY AND TRANSPORTATION DEPARTMENT
ARKANSAS TOURIST INFORMATION CENTER
(WHITE RIVER) (S)
JOB 061451

TRUCKER-VENDING BUILDING
DOMESTIC WATER PIPING PLAN

Sheet Reference Number:
P-132
Sheet 111 of 130

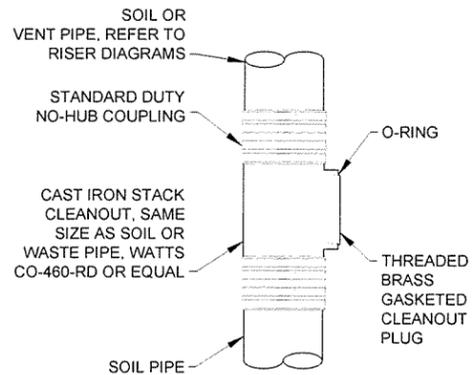


INTERIOR CLEANOUT (CO) DETAIL

1 P-501 SCALE: NONE


PIPE SIZE	FIXTURE UNITS	PDI CROSS REFERENCE	OVERALL LENGTH	CONNECTION N.P.T.
1/2"	1 - 11	A	6-1/4"	1/2"
3/4"	12 - 32	B	7-1/4"	3/4"
1"	33 - 60	C	9-1/4"	1"
1-1/4"	61 - 113	D	9-1/2"	1"
1-1/2"	114 - 154	E	11-1/4"	1"
2"-3"	155 - 330	F	12"	1"

4 WATER HAMMER ARRESTOR DETAIL

P-501 SCALE: NONE

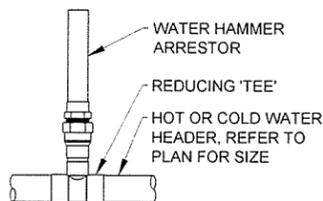


- NOTES:
- PLACE ARRESTOR AT END OF HEADER WITHIN SIX (6) FEET OF LAST FIXTURE.
 - PLACE ADDITIONAL ARRESTORS AT TWENTY (20) FOOT INTERVALS.
 - INSTALL ARRESTORS ON ALL HOT AND COLD WATER HEADERS THAT HAVE FAST ACTING VALVES LIKE FLUSHMETERS AND SOLENOID VALVES.

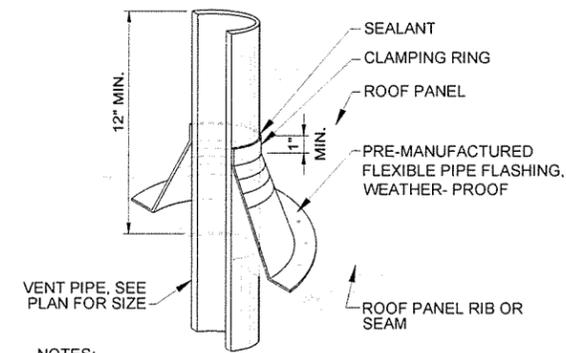

- NOTES:
- PAINT VENT TO MATCH ROOF IN ACCORDANCE WITH ARCHITECTURAL SPECIFICATIONS.
 - CENTER ALL VENT THRU ROOF PENETRATIONS BETWEEN ROOF SEAMS. DO NOT CUT ROOF SEAMS.


7 VENT THRU ROOF (VTR) DETAIL

P-501 SCALE: NONE

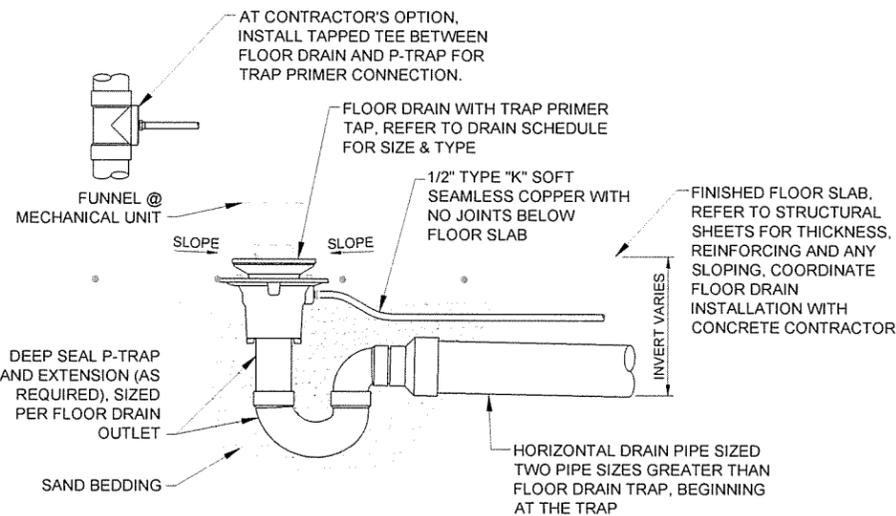

2 FLOOR DRAIN (FD) DETAIL


P-501 SCALE: NONE

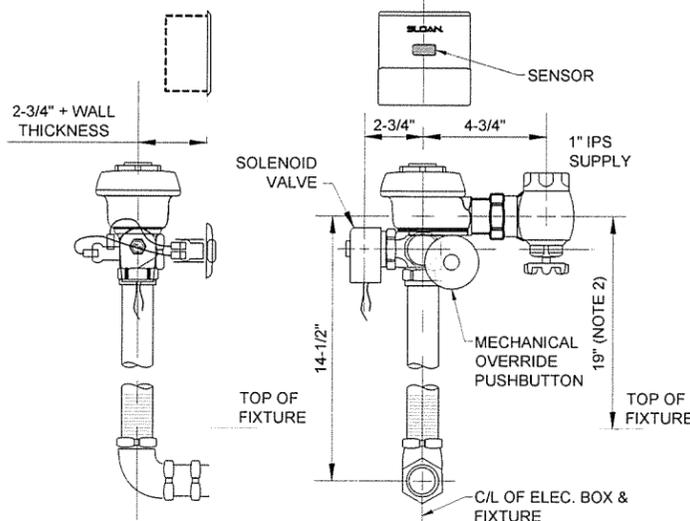

- NOTES:
- SENSOR LOCATION & POSITIONING ARE CRITICAL! FAILURE TO PROPERLY POSITION THE ELECTRICAL BOXES TO THE PLUMBING ROUGH-IN WILL RESULT IN IMPROPER INSTALLATION AND IMPAIR SENSOR PERFORMANCE. ALL TRADESMEN (PLUMBERS, ELECTRICIANS, MASONS, ETC.) INVOLVED WITH THE INSTALLATION OF THIS PRODUCT MUST COORDINATE THEIR WORK TO ASSURE PROPER SENSOR OPERATION.
 - POSITION OF SENSOR BOX MAY BE RAISED OR LOWERED 1" IF IN CONFLICT WITH HANDICAP GRAB BARS.

5 WATER CLOSET FLUSH VALVE DETAIL


P-501 SCALE: NONE

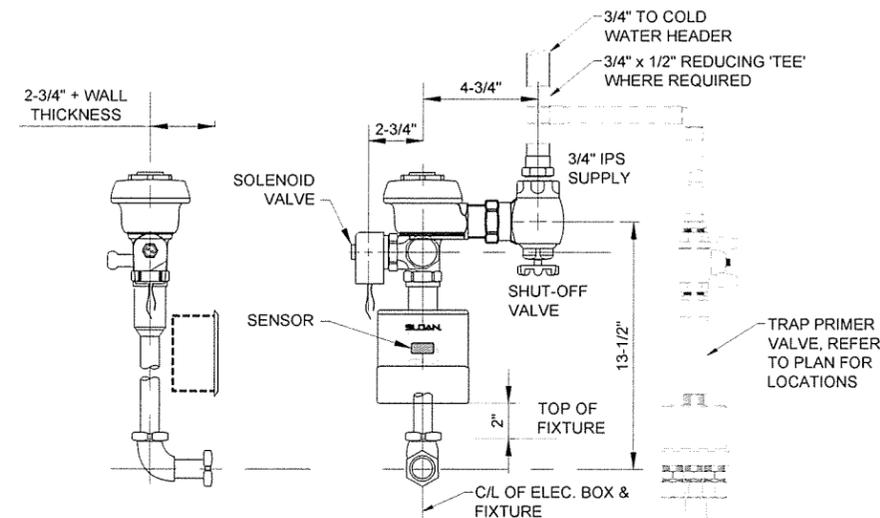

- NOTES:
- SENSOR LOCATION & POSITIONING ARE CRITICAL! FAILURE TO PROPERLY POSITION THE ELECTRICAL BOXES TO THE PLUMBING ROUGH-IN WILL RESULT IN IMPROPER INSTALLATION AND IMPAIR SENSOR PERFORMANCE. ALL TRADESMEN (PLUMBERS, ELECTRICIANS, MASONS, ETC.) INVOLVED WITH THE INSTALLATION OF THIS PRODUCT MUST COORDINATE THEIR WORK TO ASSURE PROPER SENSOR OPERATION.


8 URINAL FLUSH VALVE DETAIL

P-501 SCALE: NONE

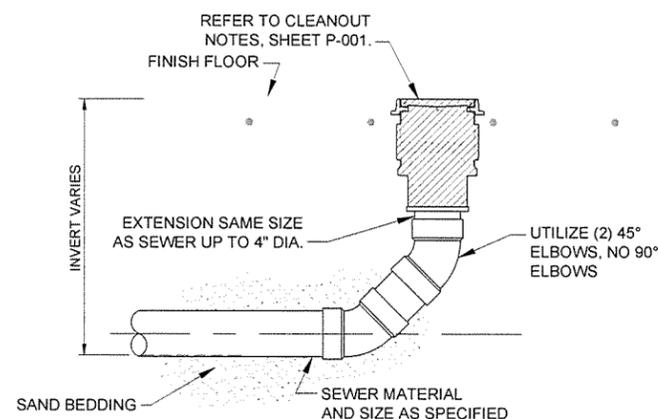

3 FLOOR CLEANOUT (FCO) DETAIL


P-501 SCALE: NONE

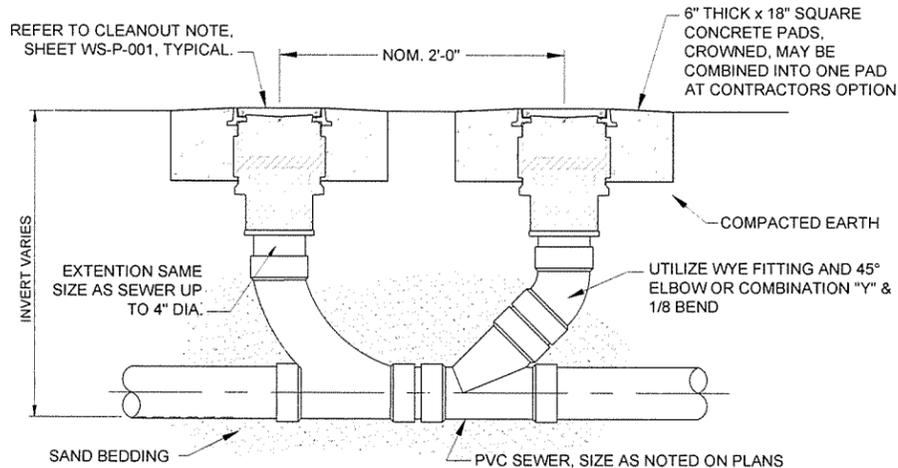

- NOTES:
- OMIT CONCRETE PAD(S) WHERE TWCOTG IS LOCATED AT SIDEWALK. INSTALL CO's TOP FLUSH WITH FINISH CONCRETE.


6 TWO-WAY CLEANOUT TO GRADE (TWCOTG) DETAIL

P-501 SCALE: NONE

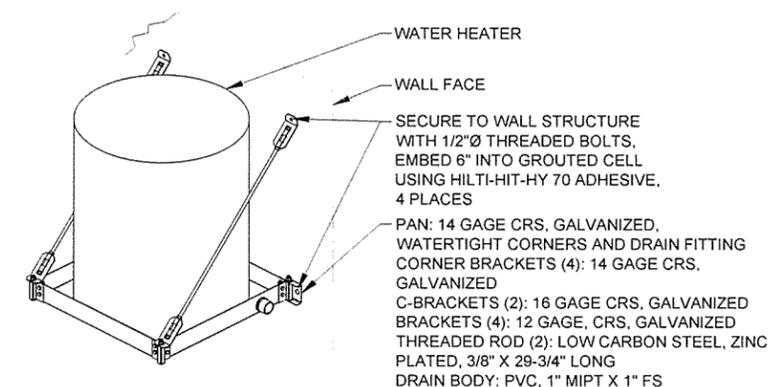

9 WATER HEATER MOUNTING DETAIL


P-501 SCALE: NONE

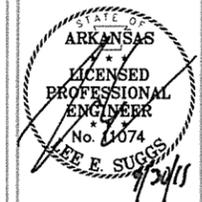


Job Number	Submitted by	Job Title	Job Date	Job Code	Job Description
060-051	John A. Sullivan, Director, Federal Services	N/A	9/29/15	11	ISSUED FOR CONSTRUCTION

Designed by	Drawn by	Checked by	File Name
K. SULLIVAN	K. SULLIVAN	B. BRADSHAW	AH150R-P-501.DWG


ARKANSAS HIGHWAY AND TRANSPORTATION DEPARTMENT
 ARKANSAS TOURIST INFORMATION CENTER
 (WHITE RIVER) (S)
 JOB 061451
 DETAILS I

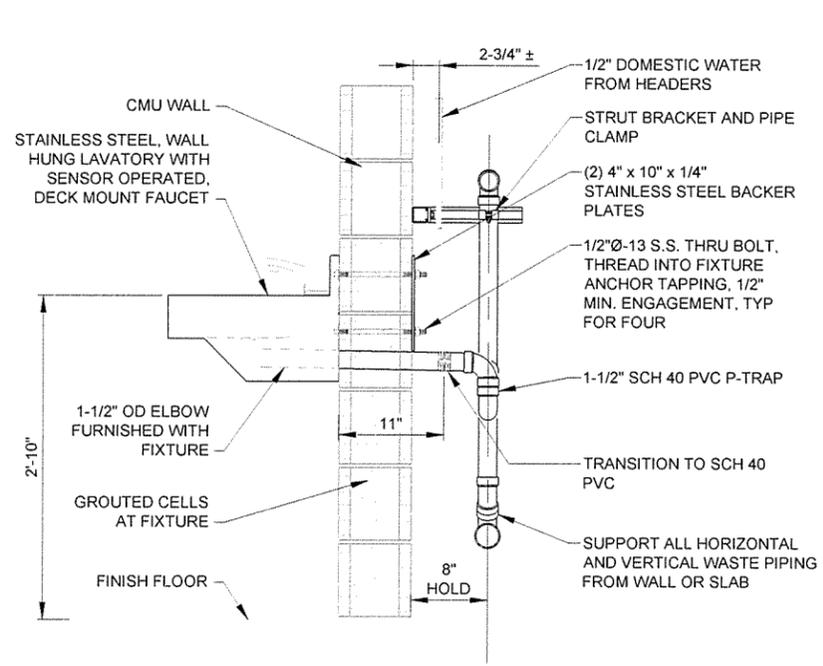


1 SECTION THRU TYPICAL WALL HUNG LAVATORY
 SCALE: NONE

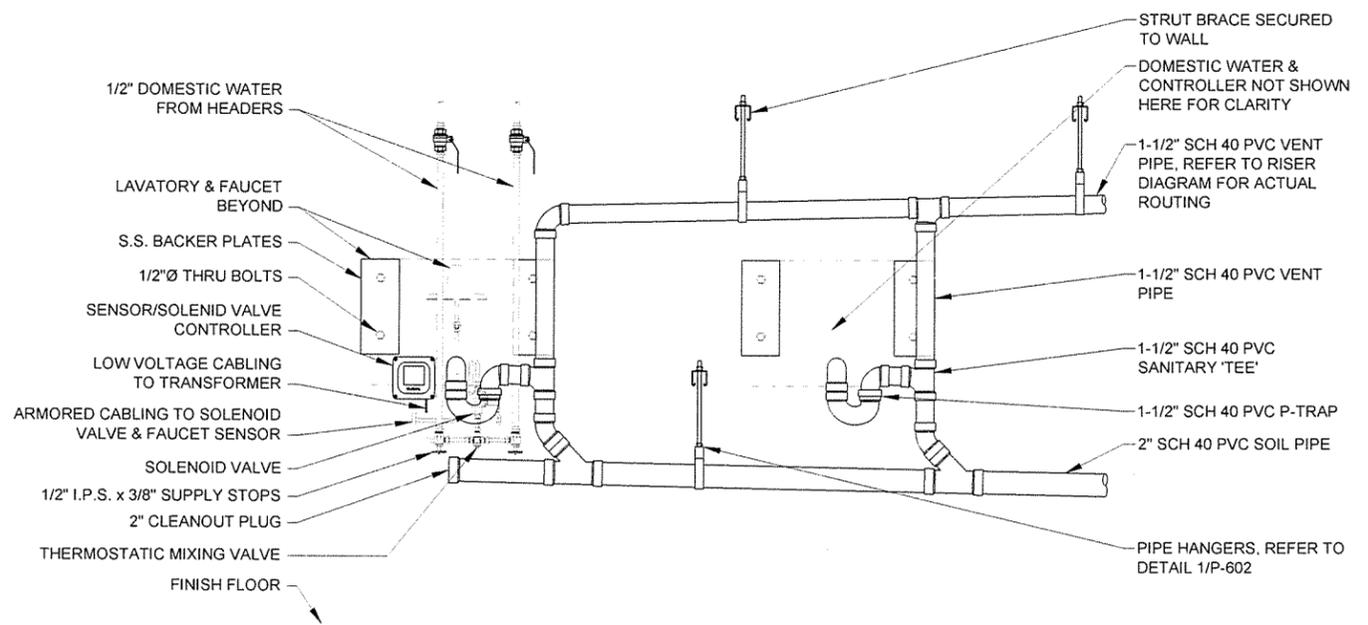


2 ELEVATION VIEW FROM UTILITY CHASE @ WALL HUNG LAVATORIES
 SCALE: NONE

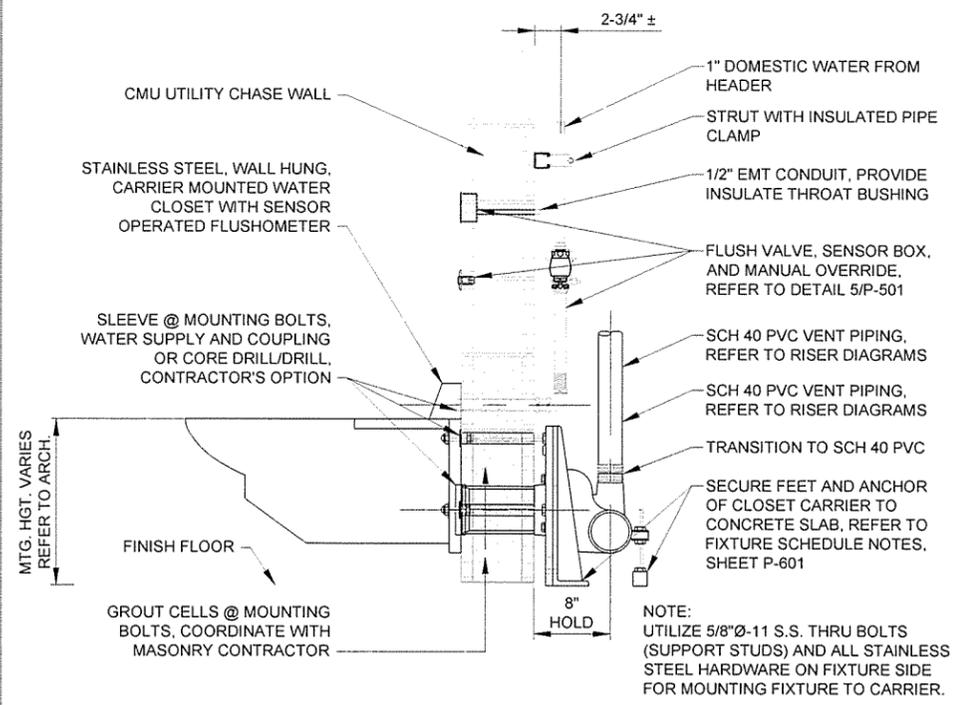

3 SECTION THRU TYPICAL WALL HUNG, CARRIER MOUNTED WATER CLOSET
 SCALE: NONE

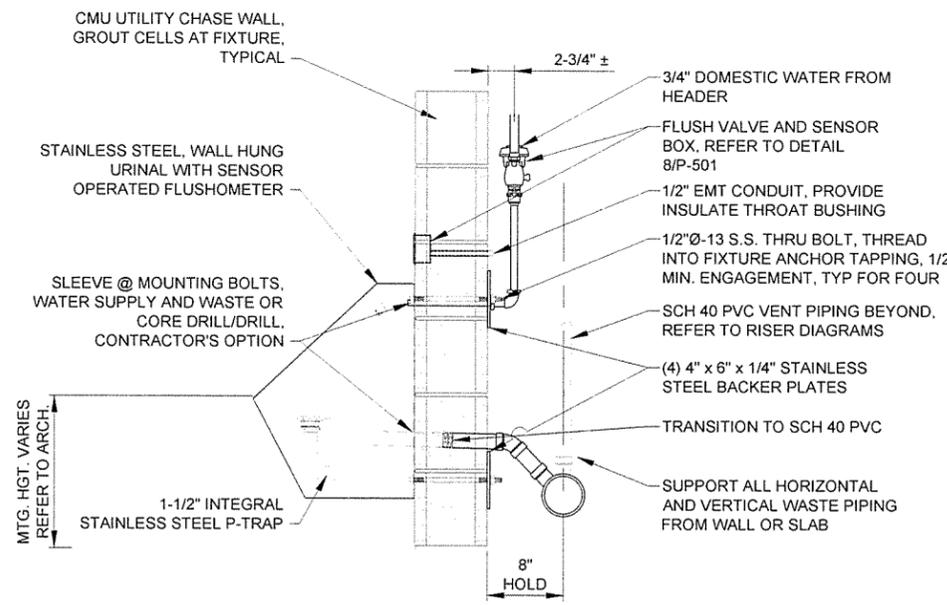


4 SECTION THRU TYPICAL WALL HUNG URINAL
 SCALE: NONE

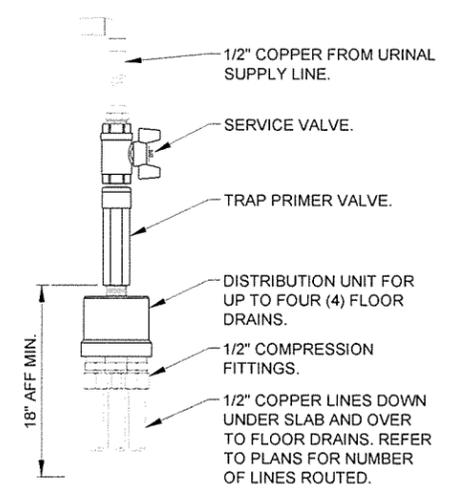

5 TRAP PRIMER VALVE TPV-1 DETAIL
 SCALE: NONE


NOTES:
 1. INSTALLATION OF TPV-2 @ LAVATORY IS SIMILAR. TPV-2 DOES NOT HAVE A DISTRIBUTION UNIT.

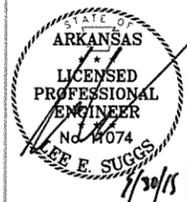


JRR	Appr.
10/11/15	Date
ISSUED FOR CONSTRUCTION	Description
IFC	Symbol

Job Number	060-451
Submitted by	John T. Valiana, III, P.E., SE Director, Field Services
Plat Scale	1:1
Plat Date	9/29/15
Checked by	B. BRADSHAW
File Name	ARHSWR-P-502 DWG


ARKANSAS HIGHWAY AND TRANSPORTATION DEPARTMENT
 ARKANSAS TOURIST INFORMATION CENTER
 (WHITE RIVER) (S)
 JOB 061451
 DETAILS II

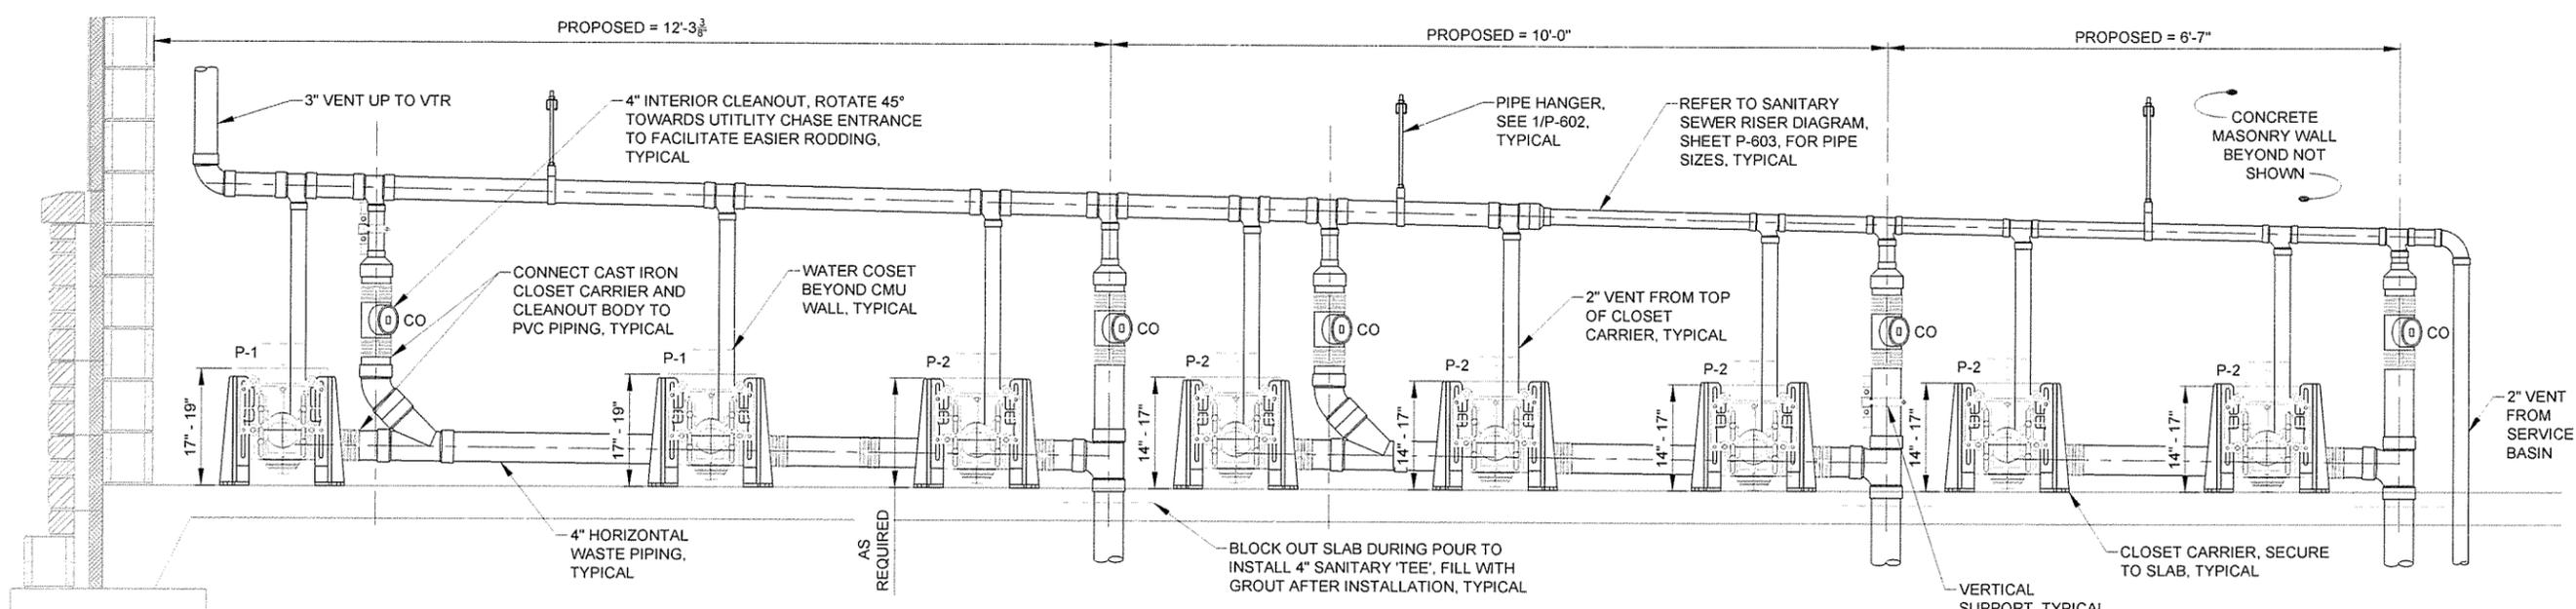

1 ELEVATION VIEW FROM UTILITY CHASE @ CARRIER MOUNTED WATER CLOSETS
 SCALE: NONE

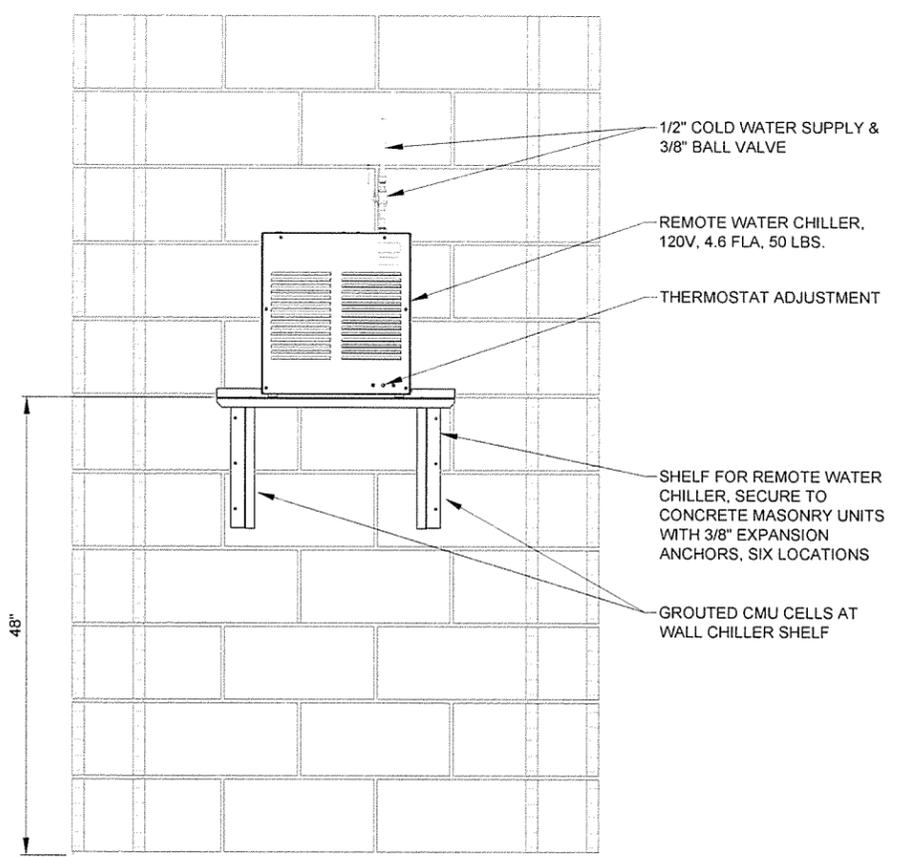

2 ELEVATION @ TYPICAL REMOTE WATER CHILLER
 SCALE: NONE

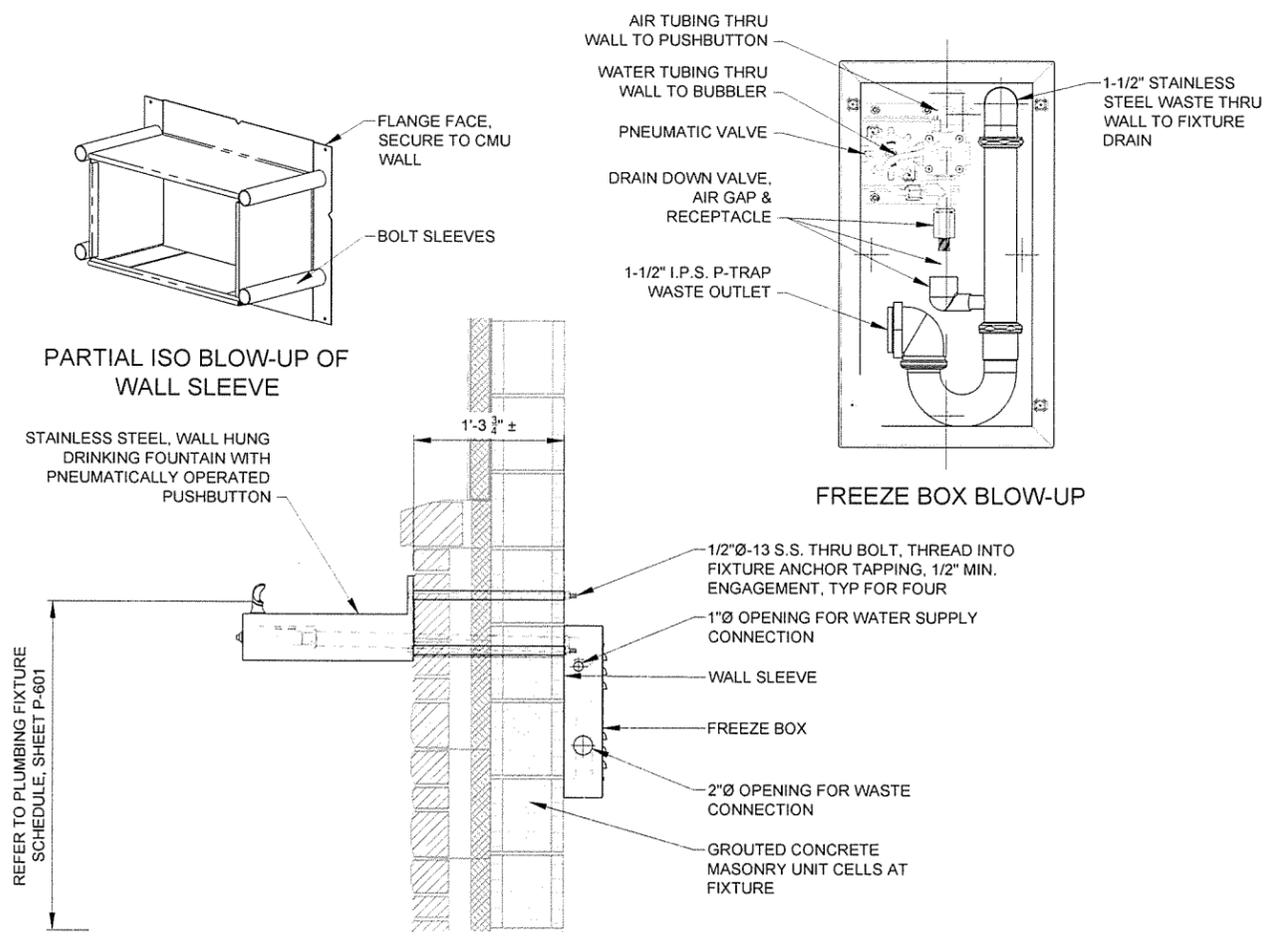

3 SECTION THRU TYPICAL DRINKING FOUNTAIN
 SCALE: NONE



JRR	Appr.
10/11/15	Date
ISSUED FOR CONSTRUCTION	Description
IFC	Symbol

Job Number	060451
Submitted by	John T. Vuolava, III, P.E., SE Director, Professional Services
Drawn by	K. SULLIVAN
Checked by	B. BRADSHAW
File Name	AR15VIR-P-503 DWG
Plat Scale	1:1
Plat Date	9/29/15
Drng Code	

ARKANSAS HIGHWAY AND TRANSPORTATION DEPARTMENT
 ARKANSAS TOURIST INFORMATION CENTER
 (WHITE RIVER) (S)
 JOB 061451
DETAILS III

PLUMBING FIXTURE SCHEDULE TOURIST INFORMATION CENTER & TRUCKER'S VENDING BUILDING												
MARK	DESCRIPTION	MFGR. & MODEL	FAUCETS, FITTINGS AND ACCESSORIES				TRAP	WASTE	COLD	HOT	REMARKS	NOTES
P-1	ADA COMPLIANT WATER CLOSET	ACORN ENGINEERING 2105-W-1-HET-1.28 GPF-FVBO-FG	FABRICATED, 14 GAGE, TYPE 304 STAINLESS STEEL, WALL HUNG, CLOSET CARRIER MOUNTED, ELONGATED, BACK SPUD, SIPHON JET, WALL OUTLET, 1.28 GPF. FURNISH WITH SLOAN VALVE 152-1.28 ES-S TMO CONCEALED, SENSOR ACTIVATED FLUSHOMETER WITH TRUE MECHANICAL OVERRIDE AND EL-154 TRANSFORMER (120 VAC/24 VAC 50 VA), ZURN Z1203-N-XH-VP EXTRA HEAVY-DUTY ADJUSTABLE CLOSET CARRIER WITH VANDAL PROOF TRIM. INSTALLATION OF WATER CLOSET IS FOR 8 INCH THICK CONCRETE MASONRY WALL.				INTEGRAL	4"	1"	-	SATIN FINISH . VERIFY MOUNTING HEIGHT WITH ARCHITECTURAL INTERIOR ELEVATIONS.	1.2
P-2	WATER CLOSET	ACORN ENGINEERING 2105-W-1-HET-1.28 GPF-FVBO-FG	FABRICATED, 14 GAGE, TYPE 304 STAINLESS STEEL, WALL HUNG, CLOSET CARRIER MOUNTED, ELONGATED, BACK SPUD, SIPHON JET, WALL OUTLET, 1.28 GPF. FURNISH WITH SLOAN VALVE 152-1.28 ES-S TMO CONCEALED, SENSOR ACTIVATED FLUSHOMETER WITH TRUE MECHANICAL OVERRIDE, ZURN Z1203-N-XH-VP EXTRA HEAVY-DUTY ADJUSTABLE CLOSET CARRIER WITH VANDAL PROOF TRIM. INSTALLATION OF WATER CLOSET IS FOR 8 INCH THICK CONCRETE MASONRY WALL.				INTEGRAL	4"	1"	-	SATIN FINISH . VERIFY MOUNTING HEIGHT WITH ARCHITECTURAL INTERIOR ELEVATIONS.	1.2
P-3	ADA COMPLIANT URINAL	ACORN ENGINEERING 1709HEU-W-1-0.125-FVBO-MT	FABRICATED, 18 GAGE WITH 16 GAGE BOWL, TYPE 304 STAINLESS STEEL, WALL HUNG, BACK OUTLET, BACK SPUD, 0.125 GPF, METAL MOUNTING TEMPLATE, INTEGRAL 1-1/2 INCH STAINLESS STEEL P-TRAP. FURNISH WITH SLOAN VALVE 195 ES-S CONCEALED, SENSOR ACTIVATED FLUSHOMETER. INSTALLATION OF URINAL IS FOR 8 INCH THICK CONCRETE MASONRY WALL.				1-1/2"	2"	3/4"	-	SATIN FINISH . VERIFY MOUNTING HEIGHT WITH ARCHITECTURAL INTERIOR ELEVATIONS.	1.3
P-4	URINAL	ACORN ENGINEERING 1709HEU-W-1-0.125-FVBO-MT	FABRICATED, 18 GAGE WITH 16 GAGE BOWL, TYPE 304 STAINLESS STEEL, WALL HUNG, BACK OUTLET, BACK SPUD, 0.125 GPF, METAL MOUNTING TEMPLATE, INTEGRAL 1-1/2 INCH STAINLESS STEEL P-TRAP. FURNISH WITH SLOAN VALVE 195 ES-S CONCEALED, SENSOR ACTIVATED FLUSHOMETER. INSTALLATION OF URINAL IS FOR 8 INCH THICK CONCRETE MASONRY WALL.				1-1/2"	2"	3/4"	-	SATIN FINISH . VERIFY MOUNTING HEIGHT WITH ARCHITECTURAL INTERIOR ELEVATIONS.	1.3
P-5	ADA COMPLIANT LAVATORY	ACORN ENGINEERING 1652LRB-1-DMS-9-H34-MT-LWE-	FABRICATED, 14 GAGE, TYPE 304 STAINLESS STEEL, WALL HUNG, WITH 3 HOLE PUNCHED DECK (2 INCHES ON CENTER, COORDINATE WITH VALVE SPECIFIED/SUBMITTED), METAL MOUNTING TEMPLATE, INTEGRAL 1-1/2 INCH STAINLESS STEEL P-TRAP WITH GRID STRAINER. FURNISH WITH SLOAN VALVE ET-600 CHROME PLATED BRASS, SENSOR ACTIVATED, 4" CENTER-SET ELECTRONIC HAND WASHING FAUCET, 0.5 GPM, WITH "BOT" BELOW DECK THERMOSTATIC MIXING VALVE AND EL-208 TRANSFORMER (120 VAC/24 VAC 100 VA), MCGUIRE ST02 1/2" IPS x 3/8" O.D. SUPPLY STOPS. INSTALLATION OF LAVATORY IS FOR 8 INCH THICK CONCRETE MASONRY WALL.				1-1/2"	2"	1/2"	1/2"	SATIN FINISH . INSTALL WITH TOP OF APRON @ 34" AFF.	3.4
P-6	ADA COMPLIANT DRINKING FOUNTAIN	ACORN ENGINEERING 1672-1-BC-03-FP-MT-SW	FABRICATED, 14 GAGE, TYPE 304 STAINLESS STEEL, WALL HUNG, WITH DECK MOUNTED CODE COMPLIANT BUBBLER, AIR-CONTROL, SINGLE TEMPERATURE, NON-METERING VALVE, FREEZE RESISTANT BOX WITH DRAIN DOWN VALVE, METAL MOUNTING TEMPLATE, AND WALL SLEEVE. FURNISH ACORN A9100080-A-SRC REMOTE WATER CHILLER (120V, 4.6A) WITH SHELF FOR REMOTE MOUNTING. INSTALLATION OF DRINKING FOUNTAIN IS FOR 16 INCH THICK WALL CONSISTING OF CONCRETE MASONRY, INSULATION/AIR GAP, AND STONE VENEER.				1-1/2"	2"	1/2"	-	SATIN FINISH . INSTALL WITH BUBBLER HEIGHT @ 34-1/2"(±) ABOVE FINISH GRADE.	3.5,6
P-7	ADA COMPLIANT DRINKING FOUNTAIN	ACORN ENGINEERING 1672-1-BC-03-FP-MT-SW	FABRICATED, 14 GAGE, TYPE 304 STAINLESS STEEL, WALL HUNG, WITH DECK MOUNTED CODE COMPLIANT BUBBLER, AIR-CONTROL, SINGLE TEMPERATURE, NON-METERING VALVE, FREEZE RESISTANT BOX WITH DRAIN DOWN VALVE, METAL MOUNTING TEMPLATE, AND WALL SLEEVE. FURNISH ACORN A9100080-A-SRC REMOTE WATER CHILLER (120V, 4.6A) WITH SHELF FOR REMOTE MOUNTING. INSTALLATION OF DRINKING FOUNTAIN IS FOR 16 INCH THICK WALL CONSISTING OF CONCRETE MASONRY, INSULATION/AIR GAP, AND STONE VENEER.				1-1/2"	2"	1/2"	-	SATIN FINISH . INSTALL WITH BUBBLER HEIGHT @ 40-1/2"(±) ABOVE FINISH GRADE.	3.5,6
P-8	MOP SERVICE BASIN	STERN WILLIAMS SBC-1425-BP	CORNER STYLE, 32" x #@" x 12", COMPOSED OF PEARL GREY MARBLE CHIPS AND WHITE PORTLAND CEMENT, INTEGRAL CAST BRASS DRAIN WITH STAINLESS STEEL STRAINER, 20 GAGE, TYPE 304 STAINLESS STEEL SPLASH CATCHER PANELS FURNISH WITH #T-35 HOSE AND WALL HOOK, #T-40 MOP HANGER AND #BP STAINLESS STEEL SPLASH GUARDS, AND CHICAGO FAUCETS 835-KKCP SURFACE MOUNTED SERVICE SINK FAUCET WITH VACUUM BREAKER,CROSS HANDLES, WALL BRACKET SUPPORT ROD, PAIL HOOK, AND 3/4 HOSE THREAD OUTLET.				3"	3"	1/2"	1/2"	INTALL FAUCET AT 42" AFF. INSTALL MOP HANGER AND HOSE WALL HOOK ON ADJACENT WALL PER MANUFACTURER'S INSTRUCTIONS.	

NOTES:

- TRANSFORMER SPECIFIED WITH P-1 WILL POWER UP TO TEN (10) WATER CLOSETS OR URINALS OR ANY COMBINATION THEREOF. NOT TO EXCEED TEN FIXTURES.
- ENSURE CLOSET CARRIER FEET AND ANCHOR ARE BOLTED TO FLOOR SLAB USING ANCHORS CAPABLE OF ACHIEVING PULL-OUT FORCE OF 805 LBS. EACH (FOUR LOCATIONS @ EACH CARRIER).
- ONLY ONE METAL MOUNTING TEMPLATE WILL BE REQUIRED FOR INSTALLATION PURPOSES.
- TRANSFORMER SPECIFIED WITH P-5 WILL POWER UP TO SIX (6) LAVATORY SENSOR CONTROLLERS.
- INSTALL REMOTE CHILLER ON SHELF SPECIFIED AT 48" AFF MINIMUM TO ALLOW CLEAR FLOOR SPACE WITHIN UTILITY CHASE.
- ONLY ONE CHILLER SHALL BE REQUIRED AT TRUCKER'S VENDING BUILDING WHERE P-6 & P-7 ARE MOUNTED SIDE BY SIDE.

DOMESTIC WATER HEATER SCHEDULE TOURIST INFORMATION CENTER & TRUCKER'S VENDING BUILDING

MARK	DESCRIPTION	MFGR. & MODEL	STORAGE (GALLONS)	INPUT (KW)	MIN. THERMAL EFFICIENCY	VOLTAGE/ PHASE	OUTLET (DEG. F)	ELEC. REQUIREMENTS	RECOVERY (GALLONS/HR.)	REMARKS	NOTES
EWH-1 EWH-2 EWH-3 EWH-4	ELECTRIC WATER HEATER	WHIRLPOOL E1F6US017V	6	1650	N/A	120/1	135	FLEXIBLE CONNECTION WITH DISCONNECT	N/A	FURNISH WITH OATEY 34160 PLASTIC DRAIN PAN WITH 1" PVC DRAIN CONNECTION, DIELECTRIC UNIONS, HOT & COLD WATER SHUT-OFF VALVES, AND APPROVED T & P RELIEF VALVE (PIPE FULL-SIZE DISCHARGE DOWN INTO DRAIN PAN, PROVIDE AIR GAP).	1, 4, 5, 7
EWH-5 EWH-6	ELECTRIC WATER HEATER	WHIRLPOOL E1F6US017V	6	1650	N/A	120/1	135	FLEXIBLE CONNECTION WITH DISCONNECT	N/A	FURNISH WITH HOLD-RITE #40-SWHP-W WALL MOUNTED EQUIPMENT PLATFORM/INTEGRAL DRAIN PAN WITH 1" PVC DRAIN CONNECTION AND ALL MOUNTING HARDWARE, DIELECTRIC UNIONS, HOT & COLD WATER SHUT-OFF VALVES, AND APPROVED T & P RELIEF VALVE (PIPE FULL-SIZE DISCHARGE INTO INTEGRAL PAN, PROVIDE AIR GAP).	1, 2, 3, 4, 6, 7

NOTES:


- CONTRACTOR SHALL SET OUTLET TEMPERATURE ON WATER HEATER.
- CONTRACTOR SHALL COORDINATE WALL MOUNTED EQUIPMENT PLATFORM WITH MASONRY CONTRACTOR TO ENSURE CMU CELLS ARE GROUTED FOR EMBEDDING SECURING BOLTS.
- CONTRACTOR SHALL ROUTE PAN DRAIN FOR DOWN TO SERVICE BASIN IN CORNER OF UTILITY CHASE.
- CONTRACTOR SHALL COORDINATE WITH ELECTRICAL CONTRACTOR TO ENSURE SUFFICIENT LENGTH OF FLEXIBLE CONDUIT IS INSTALLED TO ALLOW FOR FUTURE REMOVAL AND REPLACEMENT OF WATER HEATER.
- INSTALL WATER HEATER ON FLOOR IN UTILITY CHASE. ROUTE 1" PVC PAN DRAIN ALONG WALL UNDER WASTE PIPING TOWARDS FLOOR DRAIN AND TURN OUT. THE DESIGN INTENT IS TO KEEP THE PAN DRAIN PIPE UNDER PIPING IN CHASE AND TO NOT IMPEDE FOOT TRAFFIC.
- INSTALL WATER HEATER AND STAND AT MAXIMUM MOUNTING HEIGHT TO PROVIDE CLEAR HEAD ROOM UNDER STAND.
- FINAL CONNECTION TO WATER HEATER AT DIELECTRIC UNION SHALL BE MADE WITH SUFFICIENT LENGTH OF FLEXIBLE COPPER TUBING TO ALLOW FOR FUTURE REMOVAL AND REPLACEMENT OF WATER HEATER.



Job Number	660451
Submitted by	John V. Varnon, II, P.E., SE Director, Federal Services
Drawn by	K. SULLIVAN
Checked by	B. BRADSHAW
File Name	AR151WR-P-001.DWG
Date	10/1/15
Appr.	JRR
Issued For Construction	Description
Symbol	IPC

Job Number	660451
Submitted by	John V. Varnon, II, P.E., SE Director, Federal Services
Drawn by	K. SULLIVAN
Checked by	B. BRADSHAW
File Name	AR151WR-P-001.DWG
Date	9/29/15
Scale	1:1


ARKANSAS HIGHWAY AND TRANSPORTATION DEPARTMENT
 ARKANSAS TOURIST INFORMATION CENTER
 (WHITE RIVER) (S)
 JOB 061451
 SCHEDULES I

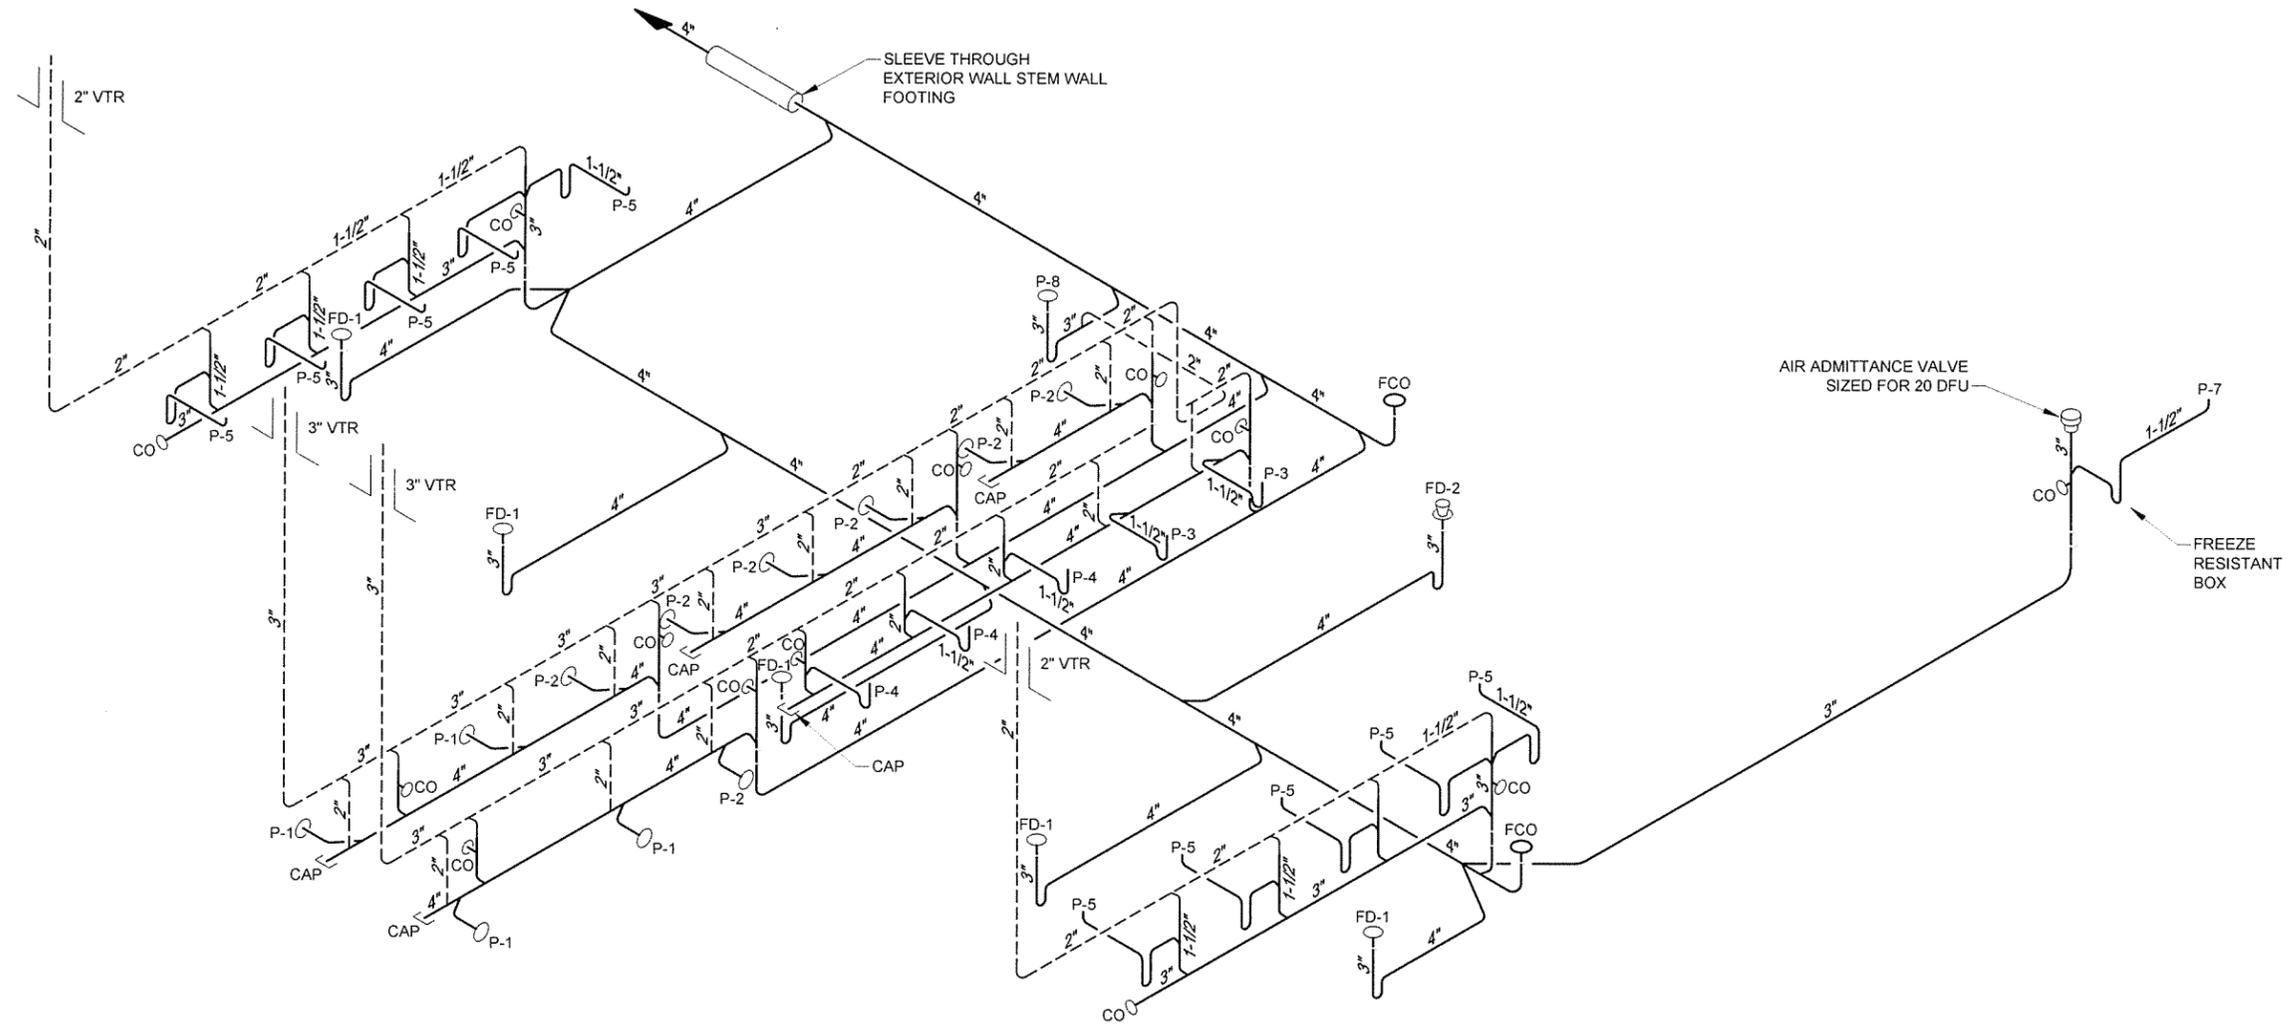

1
P-603

TOURIST INFORMATION CENTER - SANITARY SEWER RISER DIAGRAM

SCALE: NONE
NOTE: OPPOSITE SIDE OF STRUCTURE RISER DIAGRAM IS SIMILAR, OPPOSITE HAND.

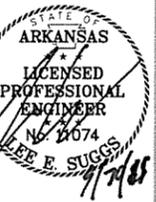


JRR	Appr.
10/1/15	Date
ISSUED FOR CONSTRUCTION	Description
IFC	Symbol

Job Number	080451
Submitted by	E. SE Federal Services
Plat Date	9/29/15
Plat Scale	1:1
Drawn by	K. SULLIVAN
Checked by	B. BRODSHAW
File Name	AH15WR-P-603 DWG

ARKANSAS HIGHWAY AND TRANSPORTATION DEPARTMENT
 ARKANSAS TOURIST INFORMATION CENTER
 (WHITE RIVER) (S)
 JOB 061451
 RISER DIAGRAMS 1

Sheet Reference Number:
P-603
 Sheet 117 of 130

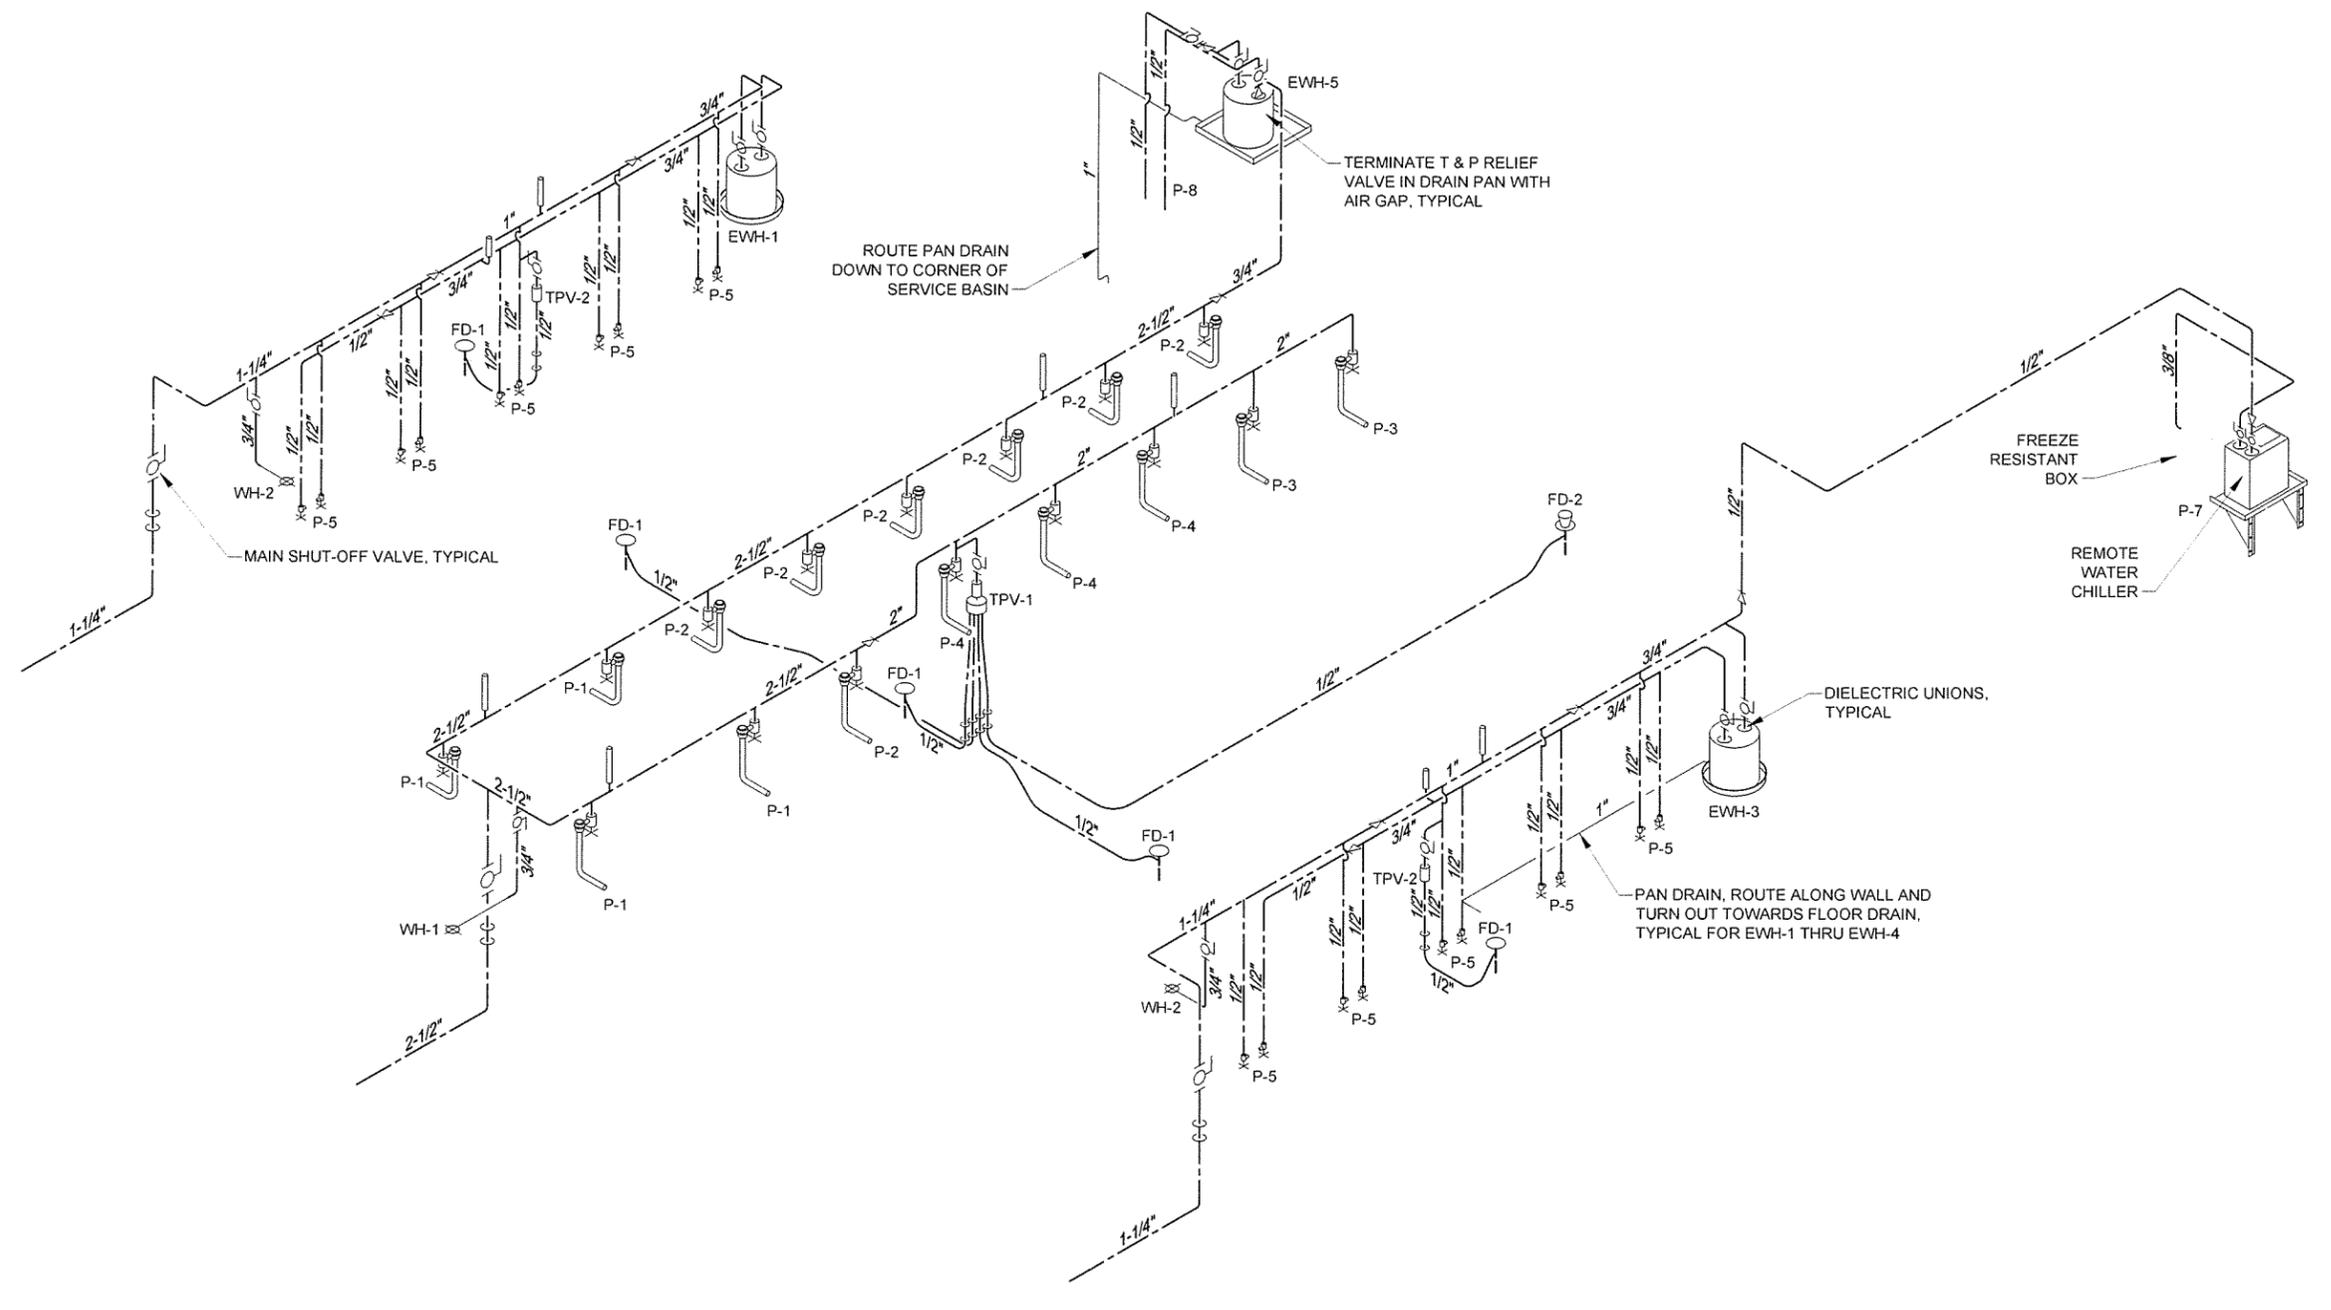

1
P-604

TOURIST INFORMATION CENTER - DOMESTIC WATER RISER DIAGRAM

SCALE: NONE

NOTE: OPPOSITE SIDE OF STRUCTURE RISER DIAGRAM IS SIMILAR, OPPOSITE HAND.



Job Number	060451
Submitted by	John T. Watkins, II, PE, SE Director, Federal Services
Drawn by	K. SULLIVAN
Checked by	B. BRADSHAW
Plot Date	9/29/15
Plot Scale	1:1
Drwg Code	
File Name	AH15WRP-04.DWG
IFC Symbol	
ISSUED FOR CONSTRUCTION	
Date	10/1/15
Appr.	
Description	REMOTE WATER CHILLER

Job Number	060451
Submitted by	John T. Watkins, II, PE, SE Director, Federal Services
Drawn by	K. SULLIVAN
Checked by	B. BRADSHAW
Plot Date	9/29/15
Plot Scale	1:1
Drwg Code	
File Name	AH15WRP-04.DWG
IFC Symbol	
ISSUED FOR CONSTRUCTION	
Date	10/1/15
Appr.	
Description	REMOTE WATER CHILLER

ARKANSAS HIGHWAY AND TRANSPORTATION DEPARTMENT
 ARKANSAS TOURIST INFORMATION CENTER
 (WHITE RIVER) (S)
 JOB 061451

RISER DIAGRAMS II

Sheet Reference Number:
P-604
 Sheet 118 of 130

LIGHTING, POWER & SYSTEM LEGEND

	WALL MOUNTED FLUORESCENT LIGHT FIXTURE		20 AMP DUPLEX RECEPTACLE, MTD 18" AFF, WITH #12 GROUND WIRE, "GFCI" INDICATES GROUND FAULT CIRCUIT INTERRUPTER, "WP" INDICATES WEATHERPROOF WHILE-IN-USE ENCLOSURE AND COVER, RECEPTACLES SHOWN IN "WP" ENCLOSURES SHALL BE WEATHER RESISTANT "WR" TYPE, "TR" INDICATES TAMPER-RESISTANT DEVICE, BOX INDICATES FLOOR OUTLET WITH RECESSED CAST JUNCTION BOX
	FLUORESCENT LIGHT FIXTURE 1'x4'		20 AMP QUADPLEX RECEPTACLE, MTD 18" AFF
	FLUORESCENT LIGHT FIXTURE 2'x4'		ELECTRICAL PANEL OR EQUIPMENT CABINET, SURFACE MOUNTED, 5'-6" TO TOP OF ENCLOSURE
	FLUORESCENT LIGHT FIXTURE 2'x2'		HOME RUN TO PANEL IN DEDICATED CONDUIT, RECEPTACLES AND EQUIPMENT SHALL HAVE DEDICATED GREEN GROUND WIRE. NUMBER OF ARROWS INDICATES NUMBER OF PHASE CONDUCTORS, LETTER(S) INDICATE NAME OF PANEL, NUMBER(S) INDICATE CIRCUIT NUMBERS
	FLUORESCENT LIGHT FIXTURE WITH EMERGENCY LIGHT (EL) BATTERY PACK, 1400 LUMENS MINIMUM FOR 2 LAMPS		TELEPHONE OUTLET, SINGLE JACK WITH 3/4"C TO ABOVE LAY-IN CEILING OR CABLE TRAY
	RECESSED LIGHT FIXTURE, UNLESS OTHERWISE SHOWN		DATA OUTLET, SINGLE JACK
	WALL MOUNTED LIGHT FIXTURE, MOUNTING HEIGHT AS INDICATED		DATA OUTLET, BOX INDICATES FLOOR OUTLET WITH RECESSED CAST JUNCTION BOX, DUAL COMBINATION WITH (1) TELEPHONE AND (1) DATA JACK UNLESS OTHERWISE NOTED
	LED EXIT LIGHT FIXTURE, CEILING MOUNTED, DARKENED AREA INDICATES FACE, ARROWS INDICATE DIRECTION OF EGRESS, STROBES AS INDICATED		TELEVISION OUTLET, SINGLE JACK MTD 18" AFF WITH 3/4"C TO ABOVE LAY-IN CEILING OR CABLE TRAY UNLESS NOTED OTHERWISE
	BATTERY PACK EMERGENCY LIGHT FIXTURE WITH TWO LAMP HEADS		TRANSFORMER, IDENTIFIER SHOWN, REFER TO SCHEDULE FOR SIZE
	INDUSTRIAL STRIP FLUORESCENT LIGHT FIXTURE		TRANSFORMER, RATINGS AS SHOWN
	NON-FUSED DISCONNECT SWITCH, SIZE AS NOTED		CIRCUIT BREAKER, TRIP RATING SHOWN, 3-POLE UNLESS NOTED OTHERWISE
	COMBINATION DISCONNECT AND MOTOR STARTER, SIZE AS NOTED, FUSED TYPE SHOWN		3/4"x10'-0" COPPER CLAD GROUND ROD
	FUSED DISCONNECT SWITCH, SIZE AS NOTED		CLOSED CIRCUIT (CCTV) CAMERA EXTERIOR MOUNTED
	JUNCTION BOX, 42 CUBIC INCH MINIMUM CAPACITY		CLOSED CIRCUIT (CCTV) CAMERA INTERIOR MOUNTED
	S LIGHT SWITCH, 120V, 20A, MTD 4'-0" AFF		
	S ₃ LIGHT SWITCH, 120V, 20A, 3-WAY, MTD 4'-0" AFF		
	S ₄ LIGHT SWITCH, 120V, 20A, 4-WAY, MTD 4'-0" AFF		
	S _{OS} LIGHT SWITCH, LINE VOLTAGE, OCCUPANCY SENSOR TYPE, DUAL TECHNOLOGY, 2-POSITION, AUTO-ON, MANUAL-ON MTD 4'-0" AFF		
	S _M MOTOR RATED SWITCH, 120V		
	OS CEILING MOUNTED LIGHT SWITCH, LINE VOLTAGE, OCCUPANCY SENSOR TYPE,		
	PC CEILING MOUNTED PHOTO SENSOR CONTROL		

GENERAL NOTES:

- SOME SYMBOLS OR ABBREVIATIONS MAY APPEAR ON THIS SHEET BUT NOT BE UTILIZED ON THE PROJECT.
- LIGHTING LEGEND SHOWS EXAMPLE IDENTIFIERS, REFER TO LIGHT FIXTURE SCHEDULE FOR SPECIFIC REQUIREMENTS.

ABBREVIATIONS

A	AMP	MCB	MAIN CIRCUIT BREAKER
ABC	ABOVE COUNTER	MCC	MOTOR CONTROL CENTER
ACS	ACCESS CONTROL SYSTEM	MCP	MOTOR CIRCUIT PROTECTOR
ACU	AIR CONDITIONING UNIT	MFR	MANUFACTURER
AFF	ABOVE FINISHED FLOOR	MIN	MINIMUM
AFG	ABOVE FINISHED GRADE	MLO	MAIN LUGS ONLY
AIC	AMPS INTERRUPTING CAPACITY	MS	MOTOR STARTER
AHU	AIR HANDLING UNIT	MTD	MOUNTED
AM	AMP-METER	N	NEUTRAL
AP	AERIAL PRIMARY	NFDS	NON-FUSED DISCONNECT SWITCH
AS	AERIAL SECONDARY	NL	NIGHT LIGHT
ATS	AUTOMATIC TRANSFER SWITCH	NTS	NOT TO SCALE
AUX	AUXILIARY	OC	ON CENTER
BFI	BLOWN FUSE INDICATOR	OF/CI	OWNER FURNISHED/ CONTRACTOR INSTALLED
BKR	BREAKER	OH	OVERHEAD
C	CONDUIT	OHP	OVERHEAD PRIMARY
CB	CIRCUIT BREAKER	OHS	OVERHEAD SECONDARY
CGRS	PVC COATED GALVANIZED RIGID STEEL	OL	OVERLOAD
CF/CI	CONTRACTOR FURNISHED/ CONTRACTOR INSTALLED	PB	PUSH BUTTON
CKT	CIRCUIT	PEC	PHOTO ELECTRIC CELL
CL	CENTERLINE	PF	POWER FACTOR
COM	COMMON	PFCC	POWER FACTOR CORRECTION CAPACITOR
CONT	CONTINUOUS	PL	PILOT LIGHT
CP	CONTROL PANEL	PMR	PHASE MONITOR RELAY
CPT	CONTROL POWER TRANSFORMER	PNL	PANEL
CR	CONTROL RELAY	PTT	PUSH-TO-TEST
CRI	COLOR RENDERING INDEX	PVC	SCHEDULE 40 POLYVINYL CONDUIT
CS	CORD SET	RECPT	RECEPTACLE
CU	COEFFICIENT OF UTILIZATION	RM	ROOM
CU	CONDENSING UNIT	S	SECOND
DEB	DIRECT EARTH BURIED	SDBC	SOFT DRAWN BARE COPPER
EC	EMPTY OR EMBEDDED CONDUIT	SE	SERVICE ENTRANCE
EF	EXHAUST FAN	SHT	SHEET
EG	EQUIPMENT GROUND	SN	SOLID NEUTRAL
EL	EMERGENCY LIGHT	SPD	SURGE PROTECTIVE DEVICE
EMT	ELECTRICAL METALLIC TUBING	SS	STAINLESS STEEL
ETM	ELAPSED TIME METER	STA	STATION
FC	FAN COIL	SW	SWITCH
FDS	FUSED DISCONNECT SWITCH	TEL	TELEPHONE
FLR	FLOOR	TD	TIME DELAY
FOC	FIBER OPTIC CABLE	THD	TOTAL HARMONIC DISTORTION
FS	FLOAT SWITCH	TMB	TELECOMMUNICATION MOUNTING BOARD
FT	FEET	TYP	TYPICAL
FVNR	FULL VOLTAGE NON-REVERSING STARTER	TC	TIME CLOCK
FVR	FULL VOLTAGE REVERSING STARTER	TGB	TELECOMMUNICATION GROUNDING BAR
GFCI	GROUND FAULT CIRCUIT INTERRUPTER	TMGB	TELECOMMUNICATION MAIN GROUNDING BAR
GF/CI	GOVERNMENT FURNISHED/ CONTRACTOR INSTALLED	UG	UNDERGROUND
GF/GI	GOVERNMENT FURNISHED/ GOVERNMENT INSTALLED GROUND	UGE	UNDERGROUND ELECTRIC
GND	GROUND	UGP	UNDERGROUND PRIMARY
GRS	GALVANIZED RIGID STEEL	UGS	UNDERGROUND SECONDARY
HOA	HAND-OFF-AUTO	UH	UNIT HEATER
HP	HORSEPOWER OR HEAT PUMP	UNO	UNLESS NOTED OTHERWISE
HR	HOUR	UTP	UNSHIELDED TWISTED PAIR
IG	ISOLATED GROUND	V	VOLT
ISP	INDIVIDUALLY SHIELDED PAIR	VA	VOLT-AMP
JB	JUNCTION BOX	VFD	VARIABLE FREQUENCY DRIVE
KVA	KILOVOLT-AMPERE	VM	VOLT-METER
KVAR	KILOVOLT-AMPERE, REACTIVE	W	WATT OR WIRE
KW	KILOWATT	WH	WEATHER HEAD
LLF	LIGHT LOSS FACTOR	WM	WATT METER
LO	LUGS ONLY	WP	WEATHERPROOF
LOR	LOCAL-OFF-REMOTE	W/	WITH
LV	LOW VOLTAGE	XMFR	TRANSFORMER

1 LEGEND & ABBREVIATIONS
E-001 SCALE: NONE




Job Number	060451	ISSUED FOR CONSTRUCTION
Submitted by	John W. SE Director, Federal Services	IFC Symbol
Drawn by	H. HOOPER	Date
Checked by	S. FEZOR	10/1/15
File Name	AH15WR-E-001.DWG	Appr.

Scale	1:1
Plot Date	9/29/15
Drng Code	

ARKANSAS HIGHWAY AND TRANSPORTATION DEPARTMENT
 ARKANSAS TOURIST INFORMATION CENTER
 (WHITE RIVER) (S)
 JOB 061451
 LEGEND & ABBREVIATIONS

KEYED NOTES

- 1 NFDS, 30A, 2 POLE, NEMA 3R
- 2 NFDS, 60A, 2 POLE, NEMA 3R
- 3 HAND DRYER
- 4 REFER TO DETAILS 5/P-501 AND 9/P-501 FOR EXACT LOCATION OF BACK BOX FOR SENSORS. FEILD COORDINATE WITH ALL TRADES.
- 5 NFDS 30A, 2POLE, NEMA 1
- 6 NFDS 60A, 2 POLE, NEMA 1

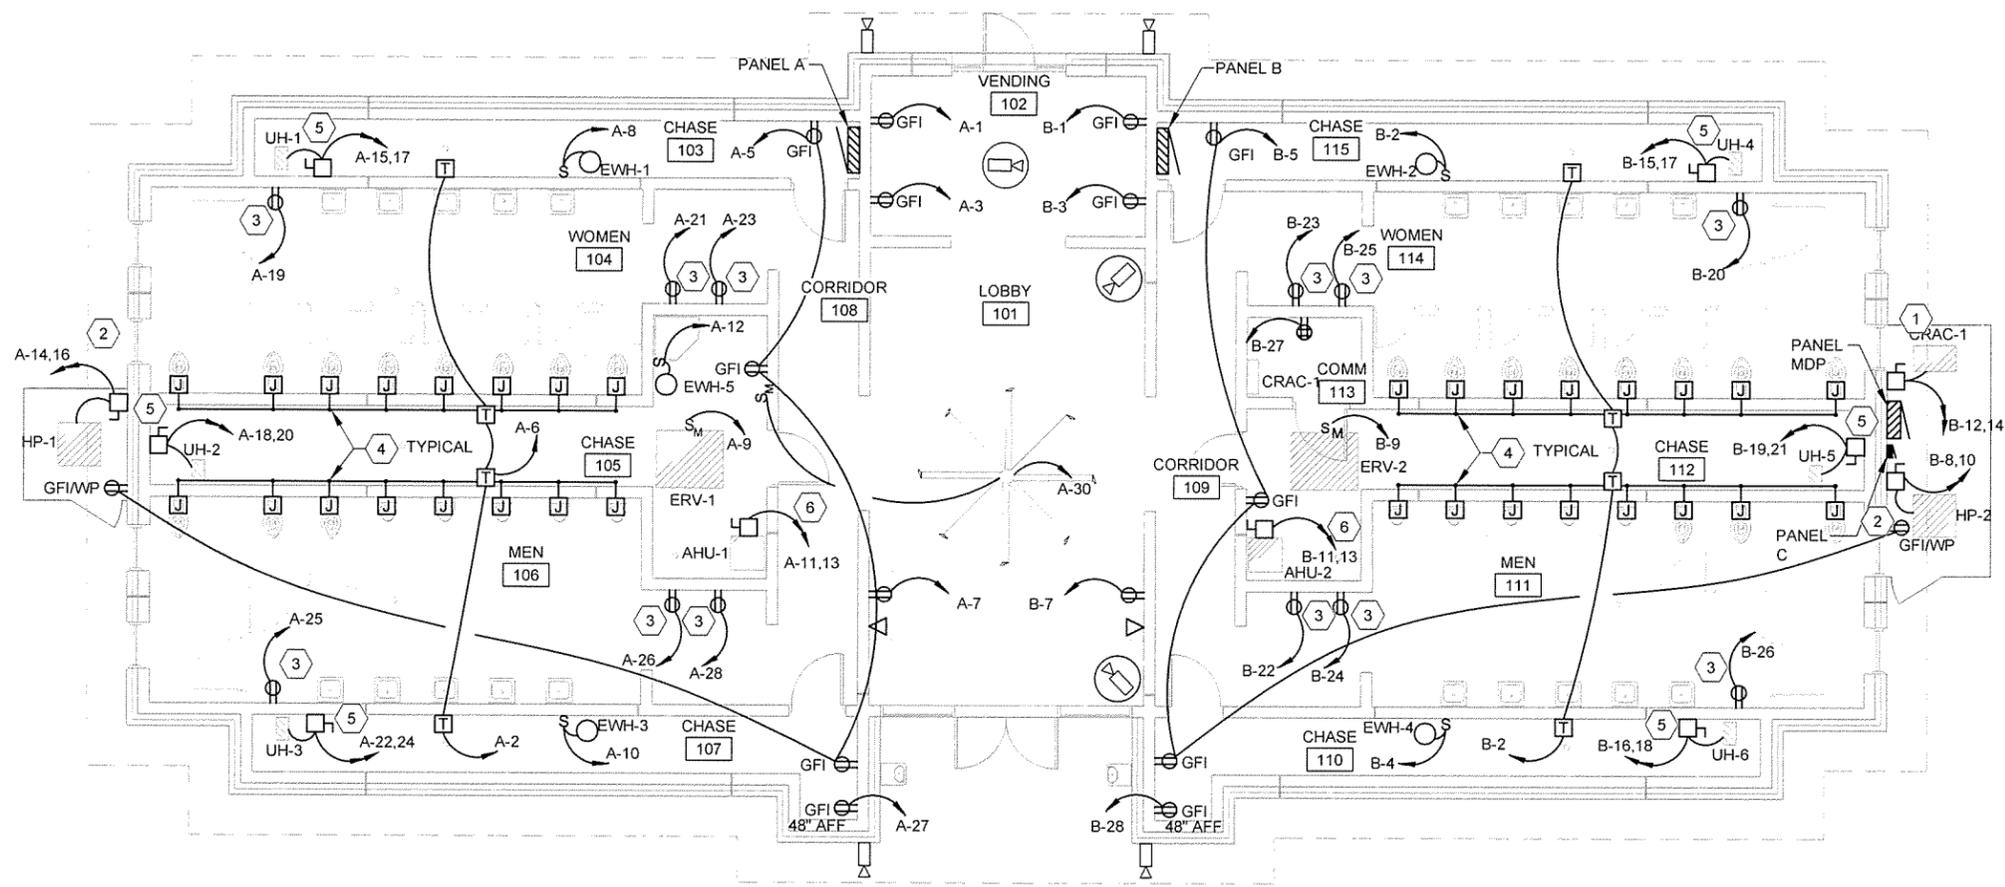


JRR	Apr
10/1/15	Date
ISSUED FOR CONSTRUCTION	Description
IPC	Symbol

Submitted by John T. Vickers, III, PE, SE Director, Federal Services	Job Number 000451
Plat Date 9/29/15	Plat Scale 1:1
Drawn by H. HOOVER	Checked by S. FEEZOR
Designed by B. MELTON	File Name A115WRF-E-102.DWG


ARKANSAS HIGHWAY AND TRANSPORTATION DEPARTMENT
 ARKANSAS TOURIST INFORMATION CENTER
 (WHITE RIVER) (S)
 JOB 051451

TOURIST INFORMATION CENTER
 POWER & SYSTEMS PLAN

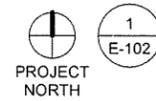

POWER & SYSTEMS PLAN - TOURIST INFORMATION CENTER


SCALE: 3/16" = 1'-0"

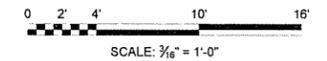

Sheet Reference Number:
E-102
 Sheet 122 of 130

KEYED NOTES


① NFDS, 60A, 2 POLE, NEMA 1

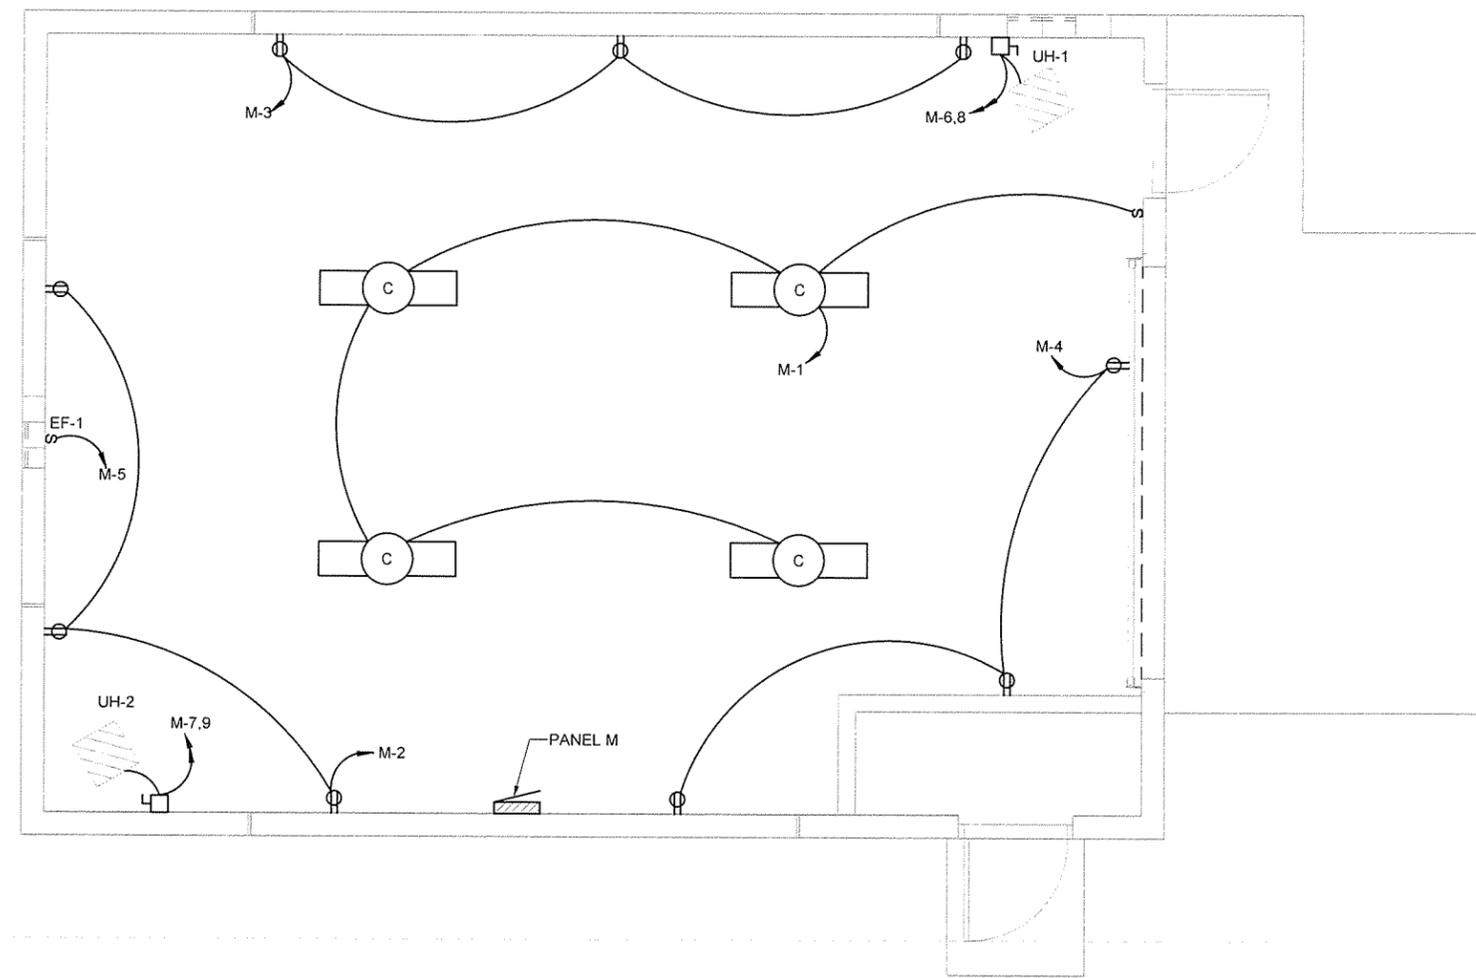

1
E-121

ELECTRICAL PLAN - MAINTENANCE BUILDING

SCALE: 3/8" = 1'-0"


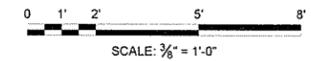


ISSUED FOR CONSTRUCTION	JRR
Description	Apr.
IFC Symbol	Date
	10/1/15


Designed by	Submitted by	Job Number
B. MELTON	John T. Valenz, II, PE, SE Director, Federal Services	000451
Drawn by	Plot Date	Plot Scale
H. HOOVER	9/29/15	1:1
Checked by	Draw Code	
S. FEEZOR		
File Name:		
AH15WRE-121.DWG		

ARKANSAS HIGHWAY AND TRANSPORTATION DEPARTMENT
 ARKANSAS TOURIST INFORMATION CENTER
 (WHITE RIVER) (S)
 JOB 061451
 MAINTENANCE BUILDING
 ELECTRICAL PLAN

Sheet Reference Number:
E-121
 Sheet 123 of 130

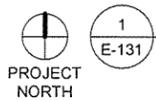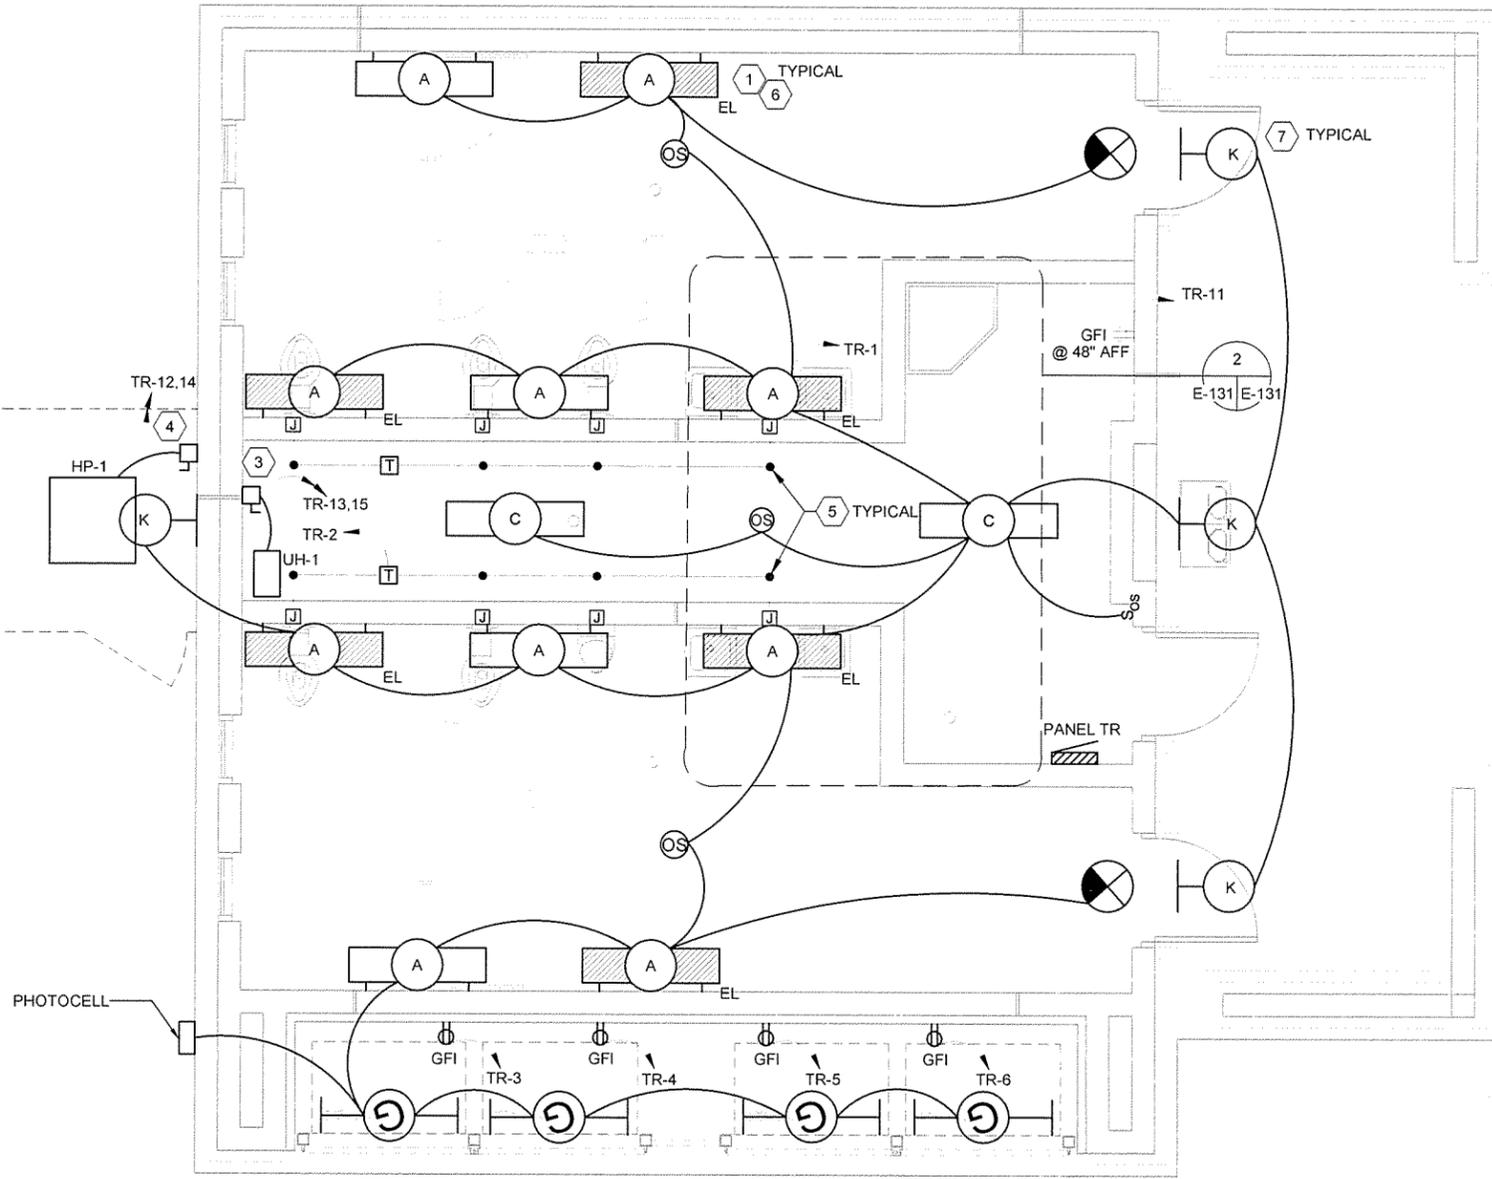




1
E-131
ELECTRICAL PLAN - TRUCKER-VENDING
SCALE: 3/8" = 1'-0"

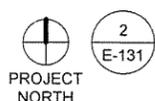

2
E-131
PARTIAL POWER PLAN
SCALE: 1/2" = 1'-0"

KEYED NOTES



- 1 MOUNT FIXTURE 9' AFF, TYPICAL.
- 2 HAND DRYER.
- 3 30A NFDS, 2 POLE, NEMA 1
- 4 30A NFDS, 2 POLE, NEMA 3R
- 5 REFER TO DETAILS 5/P-501 AND 9/P-501 FOR EXACT LOCATION OF BACK BOX FOR SENSORS. FIELD COORDINATE WITH ALL TRADES.
- 6 REFER TO A-431 FOR MOUNTING HEIGHT AND EXACT LOCATION. TYPICAL FOR TYPE A FIXTURES.
- 7 REFER TO A-232 FOR MOUNTING HEIGHT AND EXACT LOCATION. TYPICAL FOR TYPE K FIXTURES.

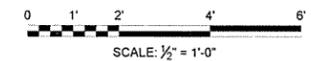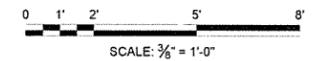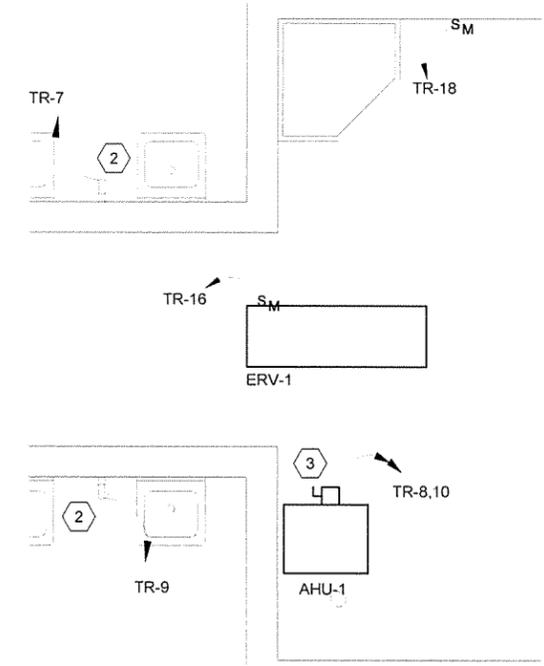

ICF Symbol	Issued For Construction Description	Date	Appr.
		10/1/15	JRR

Job Number	Submitted By	Plat Date	Plat Scale	Job Code	File Name
000451	John T. Watkins, II, PE, SE Director, Federal Services	9/29/15	1:1	N/A	AH15WR-E-131.DWG


ARKANSAS HIGHWAY AND TRANSPORTATION DEPARTMENT
 ARKANSAS TOURIST INFORMATION CENTER
 (WHITE RIVER) (S)
 JOB 061451
**TRUCKER-VENDING BUILDING
 ELECTRICAL PLAN**

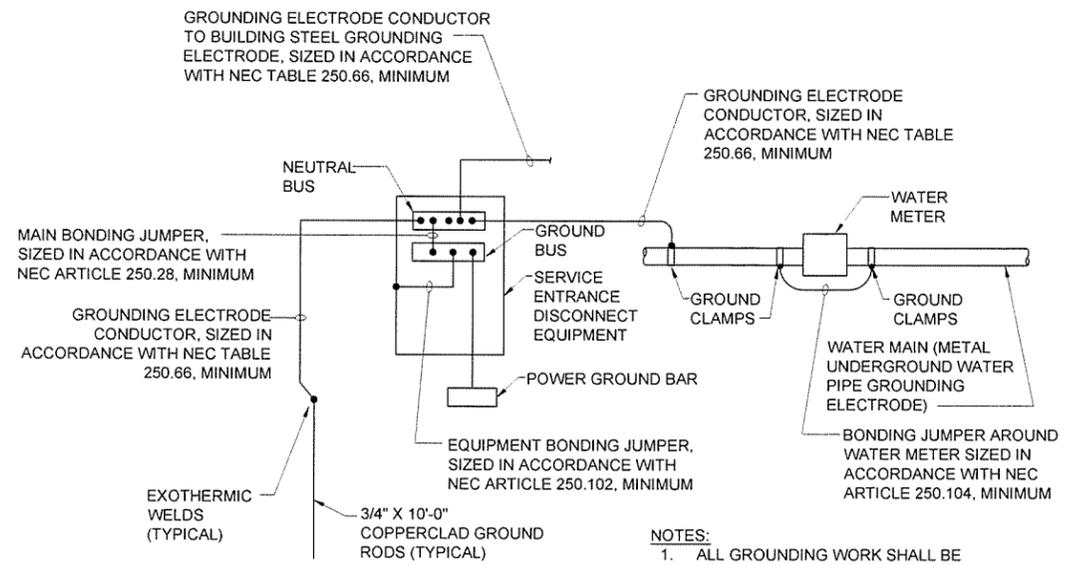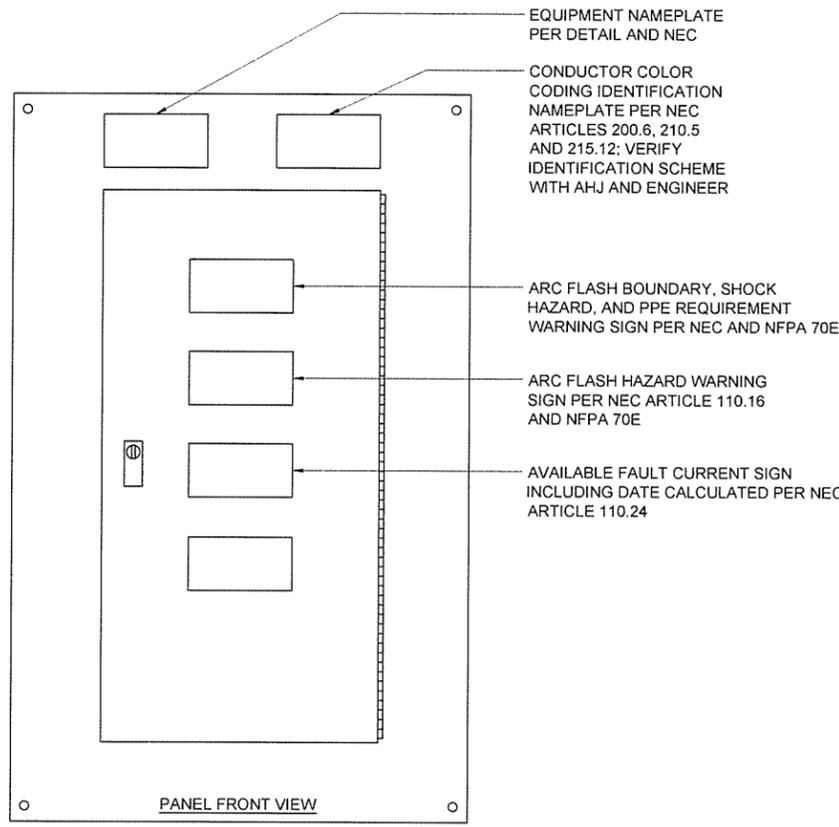

- NOTES:**
1. ALL GROUNDING WORK SHALL BE PERFORMED IN ACCORDANCE WITH NEC ARTICLE 250 - GROUNDING.
 2. REFER TO SPECIFICATIONS FOR ADDITIONAL GROUNDING INFORMATION AND REQUIREMENTS.


2
E-501 **GROUNDING SYSTEM CONNECTIONS DETAIL**
SCALE: NONE

- GENERAL NOTE:**
1. INSTALL ALL NAMEPLATES AND WARNING SIGNS IN ACCORDANCE WITH NEC AND NFPA 70E REQUIREMENTS.
 2. INSTALL NAMEPLATES AND WARNING SIGNS ON ALL ELECTRICAL EQUIPMENT, INCLUDING BUT NOT LIMITED TO, SWITCHBOARDS, PANELBOARDS, TRANSFORMERS, SWITCHES, CONTROL PANELS AND MOTOR CONTROL CENTERS.
 3. EXTERIOR EQUIPMENT SHALL HAVE WEATHER-RESISTANT, NON-FADING NAMEPLATES AND SIGNAGE.
 4. INSTALL CIRCUIT DIRECTORY AND/OR CIRCUIT IDENTIFICATION FOR PROPER FIELD IDENTIFICATION.
 5. REFER TO SPECIFICATIONS FOR ADDITIONAL REQUIREMENTS.

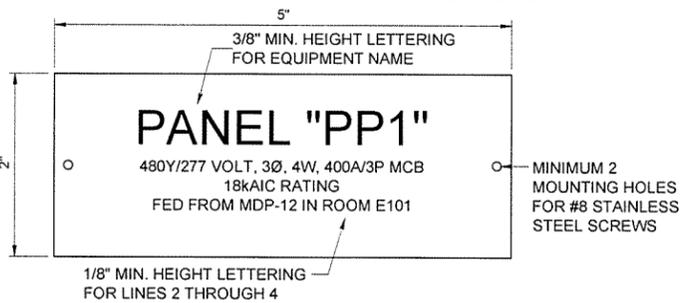

- EQUIPMENT NAMEPLATE NOTES:**
1. INSTALL 2-PLEX ACRYLIC, WHITE ON BLACK CORE, 5"x2" TILE, TEXT LINES AS INDICATED, CUSTOM ENGRAVED NAME PLATES.
 2. MOUNT WITH STAINLESS STEEL SCREWS.
 3. SEAL SCREW HOLES WITH SILICONE RUBBER.
 4. NAMEPLATE INFORMATION SHALL INCLUDE:
 - A. IDENTIFICATION NAME.
 - B. VOLTAGE SYSTEM, AND AMPACITY RATING AND TYPE.
 - C. EQUIPMENT AIC RATING.
 - D. FEEDER SOURCE OF SUPPLY DESCRIPTION.
 5. COORDINATE NAMEPLATE INFORMATION FOR EACH PIECE OF EQUIPMENT.


1
E-501 **TYPICAL ENGRAVED NAMEPLATE AND SIGNAGE DETAIL**
SCALE: NONE

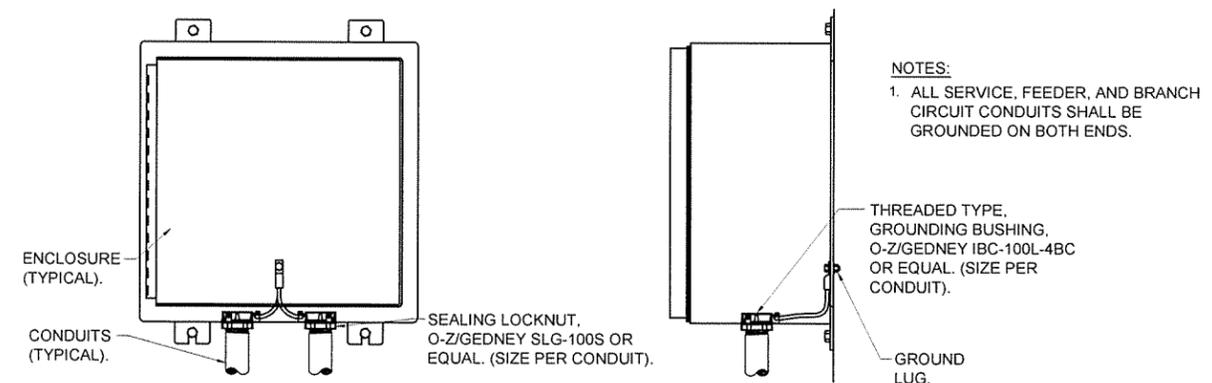

- NOTES:**
1. ALL SERVICE, FEEDER, AND BRANCH CIRCUIT CONDUITS SHALL BE GROUNDED ON BOTH ENDS.

3
E-501 **CONDUIT GROUNDING DETAIL**
SCALE: NONE

SECURE TO WALL OR BOARD AS INDICATED ON DRAWINGS

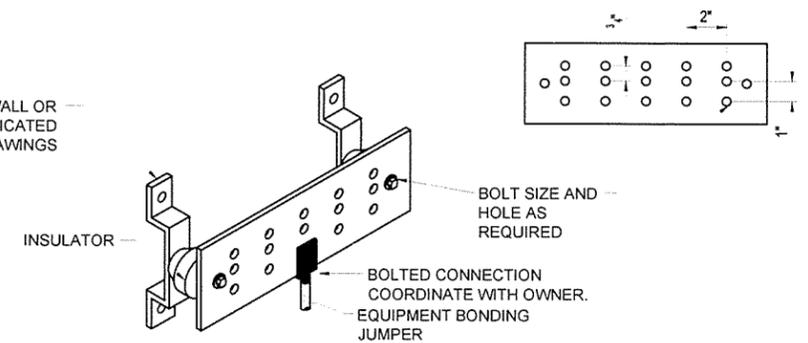

- GROUNDING BAR NOTES:**
1. COPPER GROUND BAR WITH WALL MOUNTING BRACKETS AND INSULATORS SPACED 24" ON CENTER MAX.
 2. DIMENSIONS: 1/4" THICK, 4" HIGH, LENGTH AS INDICATED ON DRAWINGS (MINIMUM SIZE-24").
 3. ALL HOLES 7/16" UON.
 4. MOUNT 24" AFF.

4
E-501 **GROUNDING BAR DETAIL (POWER)**
SCALE: NONE



Job Number	Submitted by	Plot Date	Plot Scale	Job Title	Date	Appr.
080451	John T. Director, Federal Services	9/29/15	1:1	N/A	10/1/15	JRR

ISSUED FOR CONSTRUCTION


Symbol Description

Designed by	Drawn by	Checked by	File Name
B. MELTON	H. HOOPER	S. PEZGOR	AH15WR-E-501.DWG

ARKANSAS HIGHWAY AND TRANSPORTATION DEPARTMENT
ARKANSAS TOURIST INFORMATION CENTER
(WHITE RIVER) (S)
JOB 061451


DETAILS I

PHOTOCELL EQUAL TO TORK # 2002
 TIME CLOCK EQUAL TO TORK #D25100BP

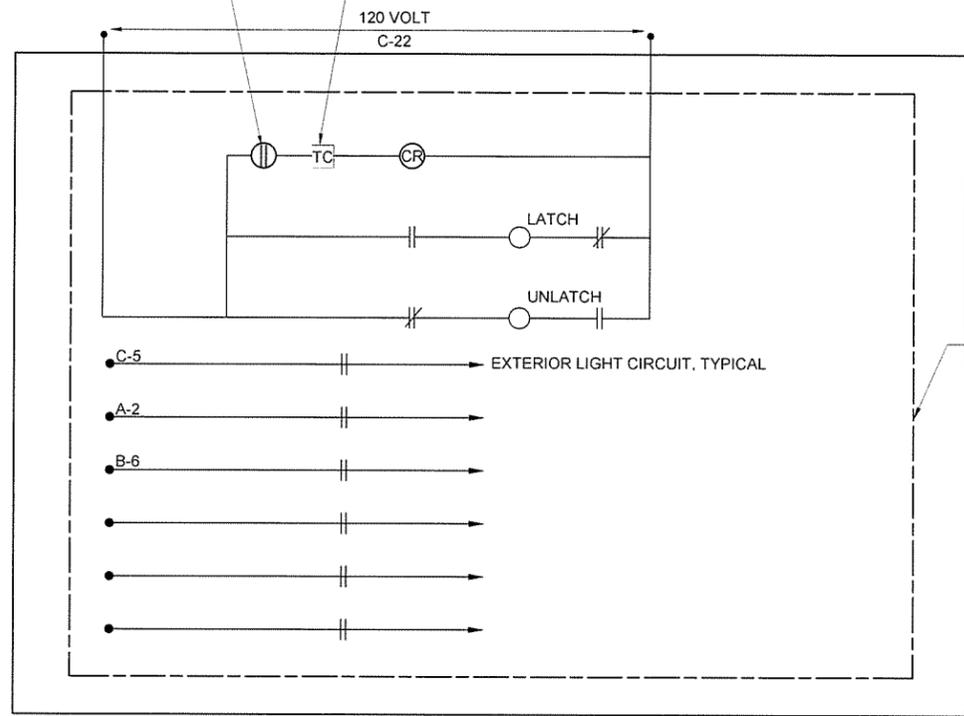


PROVIDE NEMA 4X LOCKABLE ENCLOSURE TO HOUSE TIME CLOCK AND LIGHTING CONTACTOR
 MOUNT PHOTOCELL ON ROOF

LIGHTING CONTACTOR EQUAL TO SQUARE D LXG60

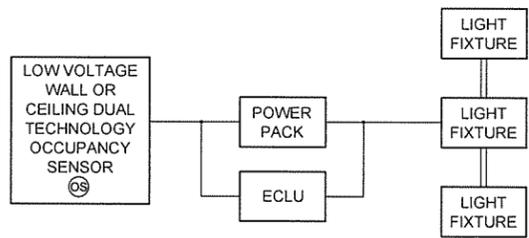

ONE SENSOR CONTROLLING ONE CIRCUIT

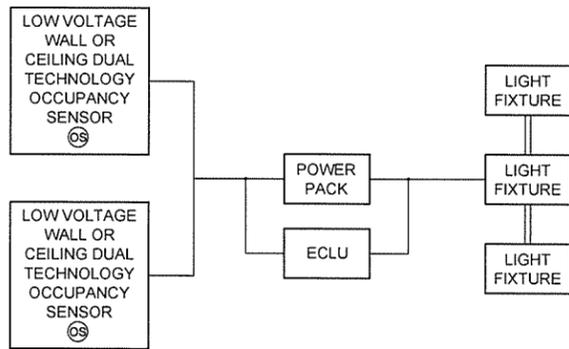

MULTIPLE SENSORS CONTROLLING ONE CIRCUIT

SENSOR DIAGRAM NOTES:

1. REFER TO LIGHTING PLANS FOR LIGHTING CONTROL AND EQUIPMENT QUANTITY REQUIREMENTS.
2. REFER TO EQUIPMENT MANUFACTURER WIRING DIAGRAMS AND PRODUCT DATA SHEETS FOR ADDITIONAL REQUIREMENTS.
3. EMERGENCY LIGHTING CONTROL UNIT (WATTSTOPPER ECLU-200 OR APPROVED EQUAL) FOR FIXTURES IN PATH OF EGRESS ONLY.
4. MANUAL TOGGLE SWITCH ADJACENT TO WALL SWITCH PROVIDES OVERRIDE LIGHTING SHUTOFF. PROVIDE TWO 3-WAY SWITCHES WHERE TWO SHUT OFF LOCATIONS ARE REQUIRED.
5. POWER PACKS NOT SHOWN ON LIGHTING PLANS FOR CIRCUITING CLARITY.

— LOW VOLTAGE AS RECOMMENDED BY MANUFACTURER.
 = LINE VOLTAGE AS SHOWN ON LIGHTING DRAWINGS.




Date	JRR	Appr.
10/1/15		
ISSUED FOR CONSTRUCTION		
IFC	Symbol	Description

Submitted by John Valdes, P.E. SE Director, Technical Services	Job Number 060451		
Drawn by H. HOOVER	File Date 9/29/15	Plot Scale 1:1	Job Name ANISHK-E-502 DWG
Checked by S. FEZZOR	File Name		


ARKANSAS HIGHWAY AND TRANSPORTATION DEPARTMENT
 ARKANSAS TOURIST INFORMATION CENTER
 (WHITE RIVER) (S)
 JOB 061451
 DETAILS II

FEEDER SCHEDULE

- ① 225A PANEL FEEDER - (2#4/0+1#4/0N+1#2EG)2"C
- ② 100A PANEL FEEDER - (2#3+1#3N+1#8EG)1"C
- ③ 50A PANEL FEEDER - (2#8+1#8N+1#10EG)1"C

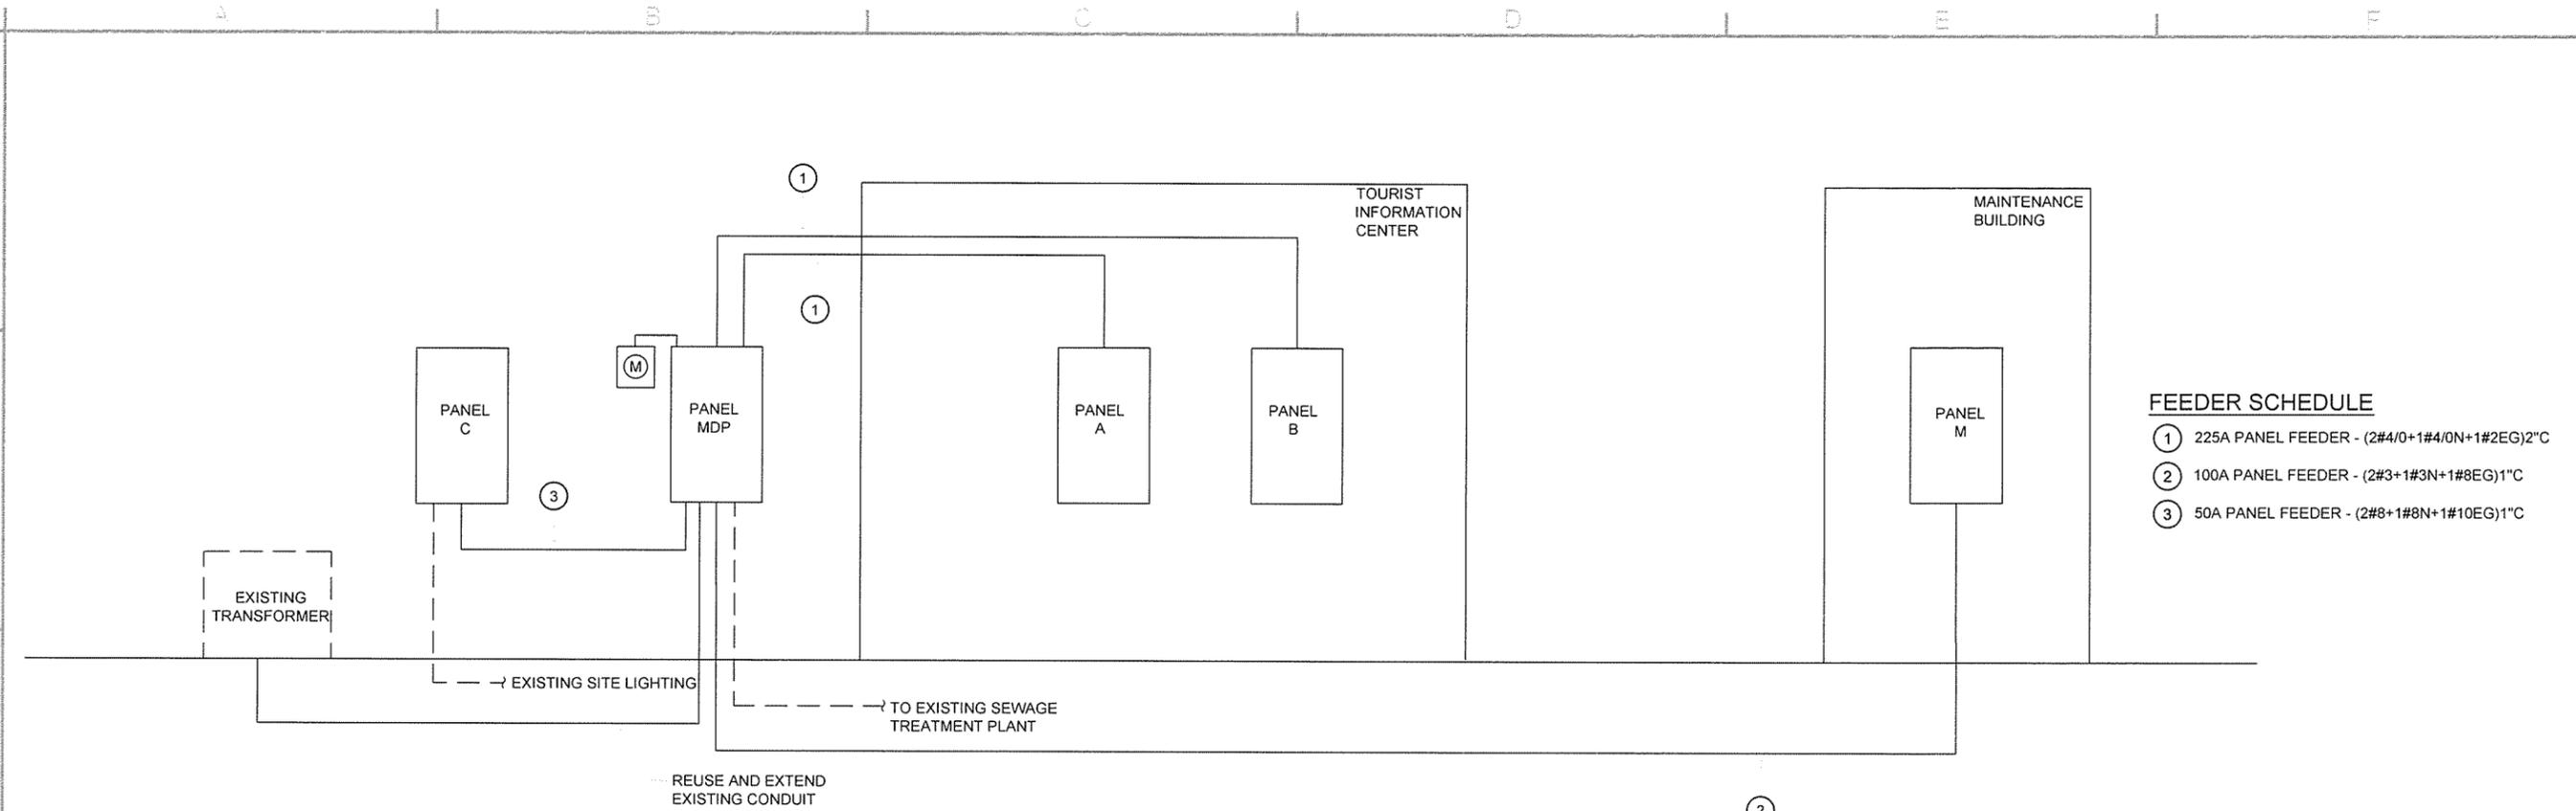

① **WHITE RIVER RISER DIAGRAM**
 E-601 SCALE: NONE

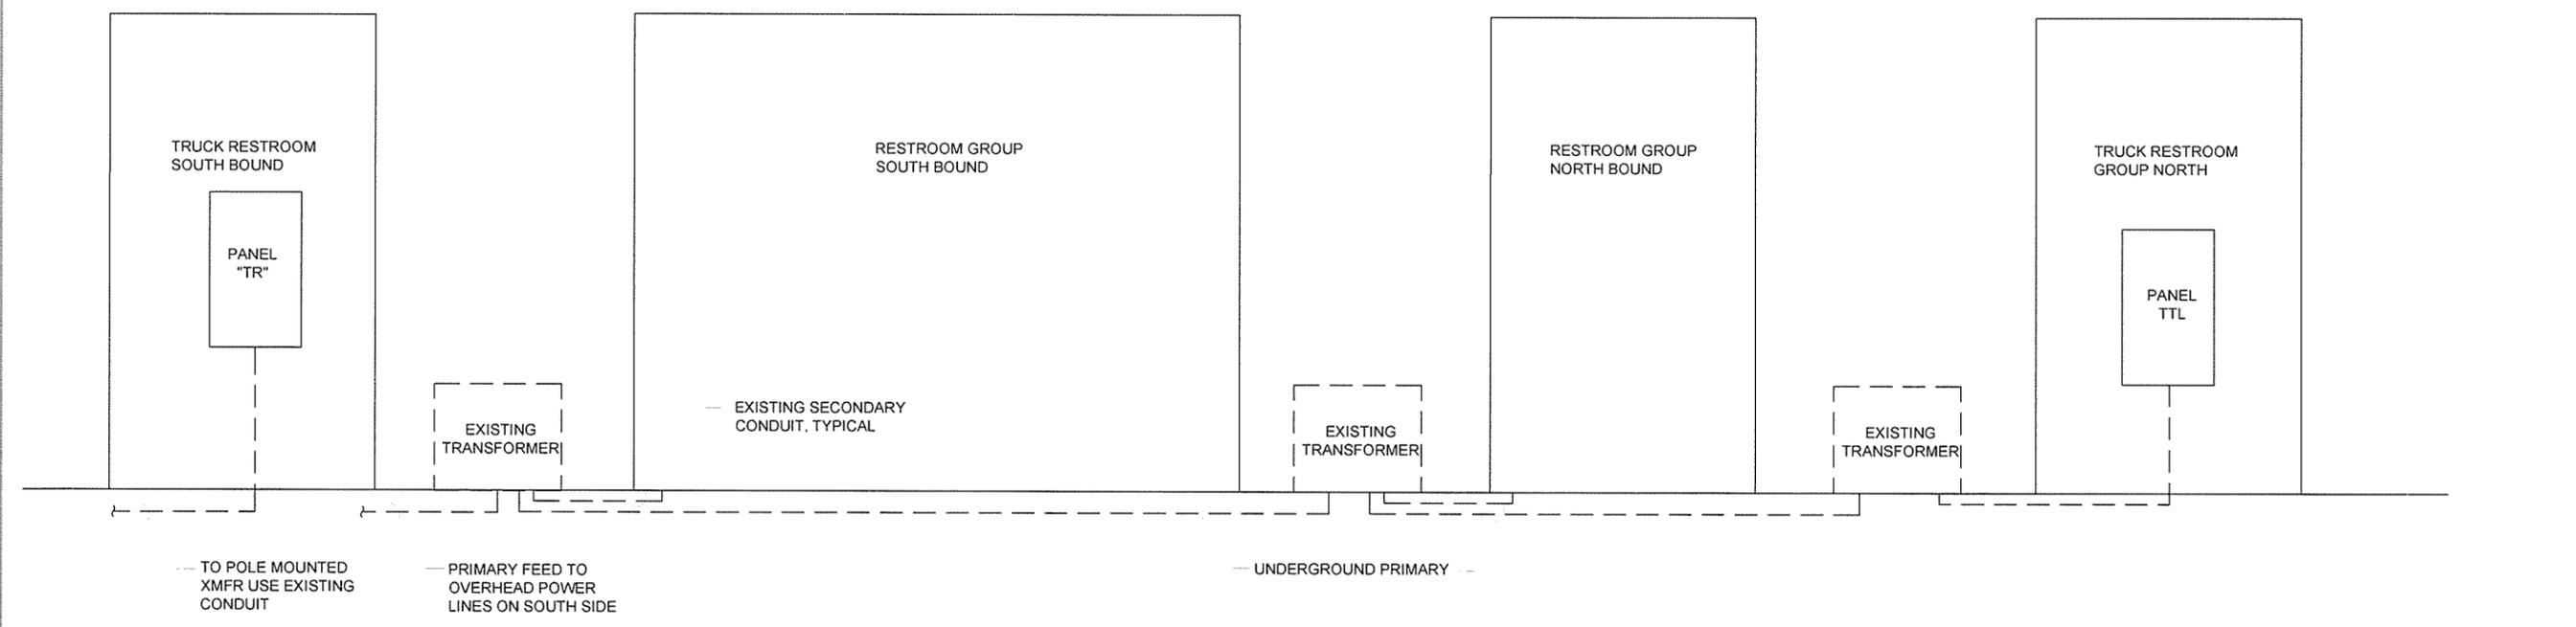


② **WHITE RIVER PRIMARY DISTRIBUTION RISER DIAGRAM**
 E-601 SCALE: NONE

IFC Symbol	ISSUED FOR CONSTRUCTION Description	Date	Appr.
		10/1/15	JRR

Job Number	660451
Submitted by	John T. Watkins, II, PE, SE Director, Federal Services
Drawn by	H. HOOPER
Checked by	S. FEEZOR
File Name	AR15WR-E-601.DWG
Plot Date	9/29/15
Plot Scale	1:1
Drng Code	
Job Number	660451
Submitted by	John T. Watkins, II, PE, SE Director, Federal Services
Drawn by	H. HOOPER
Checked by	S. FEEZOR
File Name	AR15WR-E-601.DWG
Plot Date	9/29/15
Plot Scale	1:1
Drng Code	

ARKANSAS HIGHWAY AND TRANSPORTATION DEPARTMENT
 ARKANSAS TOURIST INFORMATION CENTER
 (WHITE RIVER) (S)
 JOB 061451

RISER DIAGRAMS I

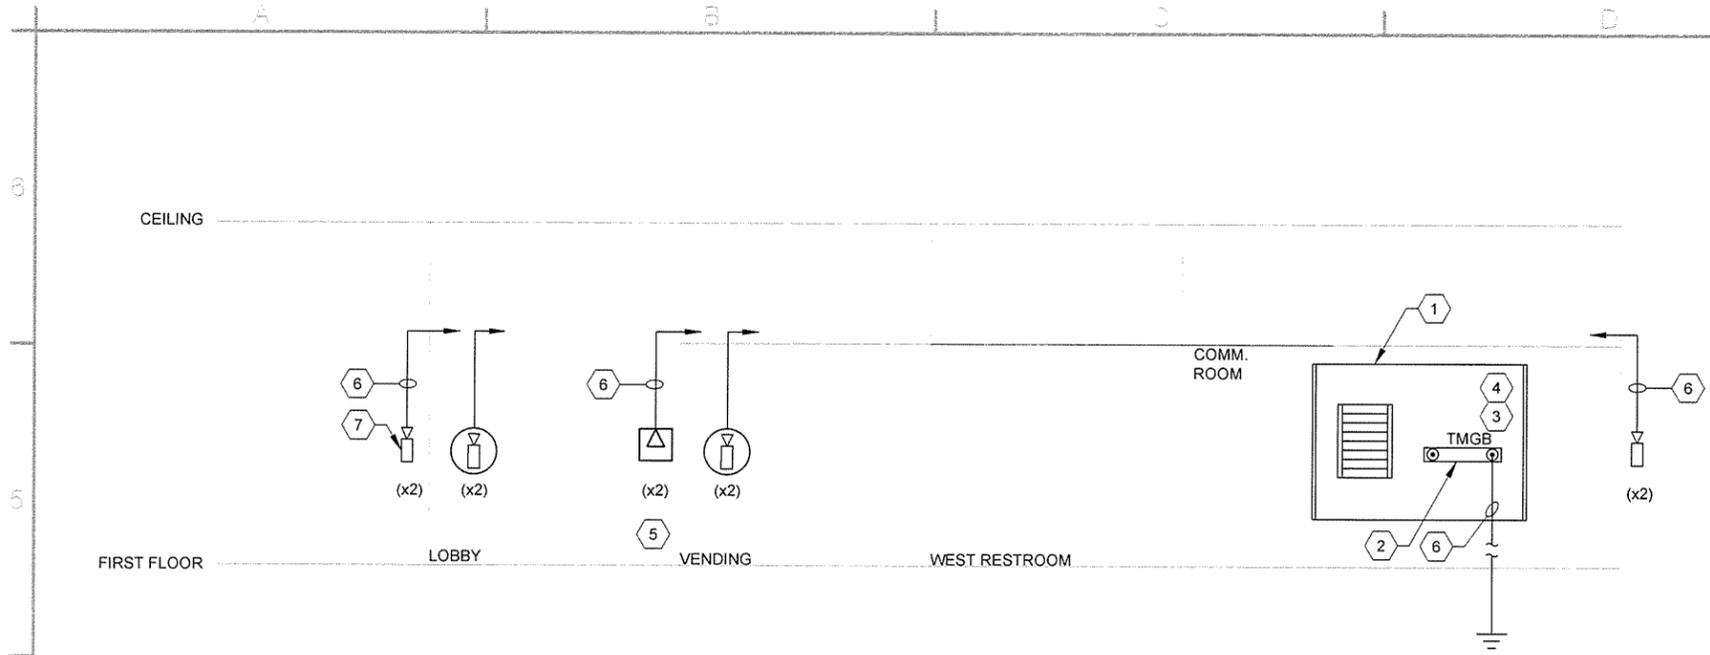

TELECOMMUNICATIONS RISER KEYED NOTES:

- 1 WALL MOUNTED TELECOMMUNICATION CABINET.
- 2 TELECOMMUNICATION TYPE GROUND BUS, COPPER, 1/4" X 4" X 24", PREDRILLED, MTD ON ISOLATORS.
- 3 PROVIDE 48-PORT, 8-PIN MODULE PATCH PANELS WITH 4-PAIR UTP PATCH CORDS FOR TERMINATION OF ALL CABLES, MAKE ALL FINAL CONNECTIONS. SEE SPECIFICATIONS FOR ADDITIONAL TELECOMMUNICATION DETAILS.
- 4 TELEPHONE MOUNTING BOARD USING 3/4" x 4' x 8' PLYWOOD SECTIONS, FIRE TREATED PLYWOOD ON WALLS INDICATED FROM FLOOR TO 8'-0" AFF FOR MOUNTING OF EQUIPMENT.
- 5 CATEGORY 6 DATA OUTLET WITH ONE JACK AND ONE DEDICATED CATEGORY 6 4-PAIR #24 AWG UTP CABLE HOMERUN IN CABLE TRAY, TERMINATE ALL CABLES AT PATCH PANELS (TYPICAL).
- 6 1" C ROUTED TO CABINET.
- 7 OUTLET BOX.

1
E-601 **TOURIST INFORMATION CENTER SYSTEM RISER DIAGRAM**
SCALE: NONE



ISSUED FOR CONSTRUCTION	JRR
Description	Appr.
IPC Symbol	Date
	10/1/15

Designed by B. MELTON	Submitted by John Vanders, P.E., SE Director, Program Services	Job Number 060451
Drawn by H. HOOVER	Plot Date 9/29/15	N/A
Checked by S. FEEZOR	Plot Scale 1:1	N/A
File Name A1515WR-E-602.DWG	Dwg Code	N/A

ARKANSAS HIGHWAY AND TRANSPORTATION DEPARTMENT
 ARKANSAS TOURIST INFORMATION CENTER
 (WHITE RIVER) (S)
 JOB 061451
 RISER DIAGRAMS II

LIGHT FIXTURE SCHEDULE

TYPE	DESCRIPTION	MANUFACTURER CATALOG NUMBER	NO.	LAMPS		VOLTAGE	MOUNTING	REMARKS
				WATTS	TYPE			
A	ARCHITECTURAL WALL MOUNT	TERON LIGHTING BSCN48232E-120E-PRF-SM-W2L	2	32	F32 T8	120	WALL	3 5
B	ARCHITECTURAL WALL MOUNT	LINEAR LIGHTING C313P-B-3-ET5HO-120-NS/MBL-WMT-AP-EM-PSB10-4	3	28	F28 T5	120	WALL	3 5
C	1'X4' STANDARD INDUSTRIAL	HE WILLIAMS 80-4-4 32-EB2-120	2	32	F32 T8	120	SURFACE	3
D	7.5" ROUND DOWNLIGHT	HE WILLIAMS PHSD75-2 26Q - CPL-TP-EB2-120	2	26	F26	120	RECESSED	3 5
F	LOW-PROFILE WRAP	HE WILLIAMS 18-4-2 32-A-EB2-120	2	32	F32 T8	120	SURFACE	3
G	FULLY ENCLOSED INDUSTRIAL	HE WILLIAMS 95-4-1 32-HIAFR-WET/2-TP/SS LATCH-120	1	32	F32 T8	120	SURFACE	2 3 5
H	WALL MOUNTED LED	US ARCHITECTURAL CBR5/12LED NW/RAL-7004/CFC	1	14	LED	120	WALL	2
K	ARCHITECTURAL WALL PACK	HE WILLIAMS VWP V-LED32/740-T4-GRAY-EM/BSL722LT-PC-120	1	45	LED	120	WALL	2
L	ARCHITECTURAL WALL PACK	LUMENPULSE LCNRO - 120 - 48 - 40K - CL - WH - NO	1	12	LED	120	WALL	2
SA	SITE LIGHT	SELUX SACL-R5-1-LG3500-40-14-SV-240	1	51	LED	120	POLE	2
SB	SITE LIGHT	GE LIGHTING ERS2-1-E3-D1-5-40-1-GRAY	1	99	LED	120	POLE	2
X	EXIT SIGN	HE WILLIAMS EXIT-R-EM-WHT-SDT	1	4	LED	UNV	SURFACE	1 2 4

GENERAL NOTES:

- COORDINATE THE INSTALLATION OF ELECTRICAL EQUIPMENT WITH THE ARCHITECT'S REFLECTED CEILING PLANS, MECHANICAL HVAC PLANS, AND FIRE PROTECTION PLANS.
- SEE SPECIFICATIONS FOR ADDITIONAL FIXTURE AND LAMP REQUIREMENTS.
- MAINTAIN INTEGRITY OF ALL FIRE RATED WALLS DUE TO CONDUIT WALL PENETRATIONS.
- LAMP COLOR TEMPERATURE SHALL BE 3500K

KEYED NOTES:

- PROVIDE FIXTURE WITH UNIVERSAL MOUNTING HARDWARE. INSTALL FIXTURE FOR WALL OR CEILING MOUNTING. PROVIDE FIXTURE WITH SINGLE OR DOUBLE FACE AS INDICATED. PROVIDE ARROWS IF AND AS SHOWN.
- PROVIDE FIXTURE LISTED AND LABELED FOR WET LOCATION.
- PROVIDE FIXTURE WITH LATEST, < 10% THD ELECTRONIC BALLAST.
- PROVIDE FIXTURE WITH SELF DIAGNOSTICS.
- PROVIDE FIXTURE WITH INTEGRAL FLUORESCENT LAMP EMERGENCY BATTERY UNIT, 1400 LUMENS OUTPUT, 90 MINUTE EMERGENCY OPERATION WHERE INDICATED ON PLANS.

Panel MDP		120 Volts L-N 10, 3W 240 Volts L-L 65,000 AIC MTG. SPACE - 36"				800A MAIN CIRCUIT BREAKER COPPER BUS EQUIP. GROUNDING BAR				TYPE: I LINE HCM NEMA 3R ENCLOSURE SURFACE MOUNTED		
Service	Ckt. No.	Conn. Load	Brkr.	Wire Size	Phase AØ BØ	Wire Size	Brkr.	Conn. Load	Ckt. No.	Service		
PANEL A	1	27120	225/2	4/0	3	100/2	10896	2	PANEL M			
	3	26942		4/0	3		11080	4				
PANEL B	5	30120	225/2	4/0	3	100/2	10768	6	PANEL TR			
	7	22628		4/0	3		10352	8				
PANEL C	9	400	50/2	12		20/1		10	SPARE			
	11	300		12		20/1		12	SPARE			
SPARE	13		20/1			20/1		14	SPARE			
SPARE	15		20/1			20/1		16	SPARE			
SPARE	17		20/1			20/1		18	SPARE			
SPARE	19		20/1			20/1		20	SPARE			
		AØ	Totals				BØ					
		107 510	VA	150 606				43 096				
		895.9	AMPS	627.53				359.1				

Panel M		120 Volts L-N 10, 3W 240 Volts L-L Max No. Of Circuits: 10,000 AIC 42				100A MAIN CIRCUIT BREAKER COPPER BUS EQUIP. GROUNDING BAR				TYPE: NQOD NEMA 1 ENCLOSURE SURFACE MOUNTED		
Service	Ckt. No.	Conn. Load	Brkr.	Wire Size	Phase AØ BØ	Wire Size	Brkr.	Conn. Load	Ckt. No.	Service		
LIGHTING	1	256	20/1	12		12	20/1	540	2	RECEPTACLES		
RECEPTACLES	3	540	20/1	12		12	20/1	540	4	RECEPTACLES		
EF-1	5	100	20/1	12		6	60/2	5000	6	UH-1		
	7	5000	60/2	6		6	60/2	5000	8			
UH-2	9	5000		6			20/1		10	SPARE		
SPARE	11		20/1				20/1		12	SPARE		
SPARE	13		20/1				20/1		14	SPARE		
SPARE	15		20/1				20/1		16	SPARE		
SPARE	17		20/1				20/1		18	SPARE		
SPARE	19		20/1				20/1		20	SPARE		
SPARE	21		20/1				20/1		22	SPARE		
SPARE	23		20/1				20/1		24	SPARE		
SPARE	25		20/1				20/1		26	SPARE		
SPARE	27		20/1				50/2		28	SPD		
SPARE	29		20/1						30			
		AØ	Totals				BØ					
		10 896	VA	21 976				11 080				
		90.8	AMPS	91.57				92.3				



Job Number 680451	Submitted by B. MELTON	Job Date 9/29/15	Plot Scale 1:1	Job Title Director, Federal Services	Job Number N/A	Submitted by H. HOOVER	Job Date 9/29/15	Plot Scale 1:1	Job Title Director, Federal Services	Job Number N/A	Submitted by S. PEZZOR	Job Date 9/29/15	Plot Scale 1:1	Job Title Director, Federal Services
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Job Number 680451	Submitted by B. MELTON	Job Date 9/29/15	Plot Scale 1:1	Job Title Director, Federal Services	Job Number N/A	Submitted by H. HOOVER	Job Date 9/29/15	Plot Scale 1:1	Job Title Director, Federal Services	Job Number N/A	Submitted by S. PEZZOR	Job Date 9/29/15	Plot Scale 1:1	Job Title Director, Federal Services
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ARKANSAS HIGHWAY AND TRANSPORTATION DEPARTMENT
 ARKANSAS TOURIST INFORMATION CENTER
 (WHITE RIVER) (S)
 JOB 061451
 SCHEDULES I



4701 Northshore Drive
Little Rock, AR 72118
501-375-3633
www.GarverUSA.com



Panel A		120 Volts L-N 1Ø, 3W 240 Volts L-L Max No. Of Circuits: 25,000 AIC 42		225 MAIN LUGS ONLY COPPER BUS EQUIP. GROUNDING BAR		TYPE: NQOD NEMA 1 ENCLOSURE SURFACE MOUNTED					
Service	Ckt. No.	Conn. Load	Brkr.	Wire Size	Phase AØ BØ	Wire Size	Brkr.	Conn. Load	Ckt. No.	Service	
RECEPTACLES VENDING 102	1	180	20/1	12		12	20/1	1512	2	LIGHTING WEST	
RECEPTACLES VENDING 102	3	180	20/1	12		12	20/1	1636	4	LIGHTING CENTER	
RECEPTACLES CORRIDOR 108	5	720	20/1	12		12	20/1	400	6	RESTROOM SENSORS	
RECEPTACLES LOBBY/MECH 101	7	180	20/1	12		12	20/1	1650	8	EWH-1	
ERV-1	9	2640	25/1	10		12	20/1	1650	10	EWH-3	
AHU-1	11	6360	60/2	6		12	20/1	1650	12	EWH-5	
	13	6360		6		8	20/1	2760	14	HP-1	
UH-1	15	2500	30/2	10		8	40/2	2760	16	HP-1	
	17	2500		10		10	30/2	2500	18	UH-2	
HAND DRYER RECEPTACLE	19	2022	25/1	10		10	30/2	2500	20	UH-2	
HAND DRYER RECEPTACLE	21	2022	25/1	10		10	30/2	2500	22	UH-3	
HAND DRYER RECEPTACLE	23	2022	25/1	10		10	30/2	2500	24	UH-3	
HAND DRYER RECEPTACLE	25	2022	25/1	10		10	25/1	2022	26	HAND DRYER RECEPTACLE	
EWG	27	500	20/1	12		10	25/1	2022	28	HAND DRYER RECEPTACLE	
SPARE	29		20/1			12	20/1	468	30	HVLS FAN	
SPARE	31		20/1				20/1		32	SPARE	
SPARE	33		20/1				20/1		34	SPARE	
SPARE	35		20/1				20/1		36	SPARE	
SPARE	37		20/1				20/1		38	SPARE	
SPARE	39		20/1				20/1		40	SPARE	
SPARE	41		20/1				20/1		42	SPARE	
		AØ	Totals				BØ				
		30 208	VA	58 738				28 530			
		251.7	AMPS	244.74				237.8			

Panel B		120 Volts L-N 1Ø, 3W 240 Volts L-L Max No. Of Circuits: 25,000 AIC 42		225A MAIN LUGS ONLY COPPER BUS EQUIP. GROUNDING BAR		TYPE: NQOD NEMA 1 ENCLOSURE SURFACE MOUNTED					
Service	Ckt. No.	Conn. Load	Brkr.	Wire Size	Phase AØ BØ	Wire Size	Brkr.	Conn. Load	Ckt. No.	Service	
RECEPTACLES VENDING 102	1	180	20/1	12		12	20/1	1650	2	EWH-2	
RECEPTACLES VENDING 102	3	180	20/1	12		12	20/1	1650	4	EWH-4	
RECEPTACLES CORRIDOR 109	5	720	20/1	12		12	20/1	1512	6	LIGHTING EAST	
RECEPTACLES LOBBY/MECH 101	7	180	20/1	12		8		2760	8	HP-2	
ERV-2	9	2640	25/1	10		8	40/2	2760	10	HP-2	
AHU-2	11	6360	60/2	6		12	15/2	1200	12	CRAC-1	
	13	6360		6		12	15/2	1200	14	CRAC-1	
UH-4	15	2500	30/2	10		10	30/2	2500	16	UH-6	
	17	2500		10		10	30/2	2500	18	UH-6	
UH-5	19	2500	30/2	10		10	25/1	2022	20	HAND DRYER RECEPTACLE	
	21	2500		10		10	25/1	2022	22	HAND DRYER RECEPTACLE	
HAND DRYER RECEPTACLE	23	2022	25/1	10		10	25/1	2022	24	HAND DRYER RECEPTACLE	
HAND DRYER RECEPTACLE	25	2022	25/1	10		10	25/1	2022	26	HAND DRYER RECEPTACLE	
TTB	27	1000	20/1	12		12	20/1	500	28	EWG	
SPARE	29		20/1				20/1		30	SPARE	
SPARE	31		20/1				20/1		32	SPARE	
SPARE	33		20/1				20/1		34	SPARE	
SPARE	35		20/1				20/1		36	SPARE	
SPARE	37		20/1				20/1		38	SPARE	
SPARE	39		20/1				20/1		40	SPARE	
SPARE	41		20/1				20/1		42	SPARE	
		AØ	Totals				BØ				
		31 664	VA	57 984				26 320			
		263.9	AMPS	241.60				219.3			

Panel TR		120 Volts L-N 1Ø, 3W 240 Volts L-L Max No. Of Circuits: 10,000 AIC 42		100A MAIN CIRCUIT BREAKER COPPER BUS EQUIP. GROUNDING BAR		TYPE: NQOD NEMA 1 ENCLOSURE SURFACE MOUNTED					
Service	Ckt. No.	Conn. Load	Brkr.	Wire Size	Phase AØ BØ	Wire Size	Brkr.	Conn. Load	Ckt. No.	Service	
LIGHTING	1	948	20/1	12		12	20/1	200	2	RESTROOM SENSORS	
RECEPTACLES VENDING	3	1000	20/1	12		12	20/1	180	4	RECEPTACLES VENDING AREA	
RECEPTACLES VENDING	5	1000	20/1	12		12	20/1	180	6	RECEPTACLES VENDING AREA	
HAND DRYER RECEPTACLE	7	1000	20/1	12		10		2760	8	AHU-1	
HAND DRYER RECEPTACLE	9	1000	20/1	12		10	30/2	2760	10	AHU-1	
RECEPTACLES WATER COOLERS	11	1000	20/1	12		12	20/1	1080	12	HP-1	
UH-1	13	2500	30/2	10		12	20/1	1080	14	HP-1	
	15	2500		10		10	25	2112	16	ERV-1	
EXTERIOR LGT*	17	200	20/1	12		12	20/1	1650	18	EWH-6	
SPARE	19		20/1				20/1		20	SPARE	
SPARE	21		20/1				20/1		22	SPARE	
SPARE	23		20/1				20/1		24	SPARE	
SPARE	25		20/1				20/1		26	SPARE	
SPARE	27		20/1				20/1		28	SPARE	
SPARE	29		20/1				20/1		30	SPARE	
		AØ	Totals				BØ				
		11 148	VA	23 150				12 002			
		92.9	AMPS	96.46				100.0			

Panel C		120 Volts L-N 1Ø, 3W 240 Volts L-L Max No. Of Circuits: 10,000 AIC 12		100A MAIN LUGS ONLY COPPER BUS EQUIP. GROUNDING BAR		TYPE: QO LOAD CENTER NEMA 3R ENCLOSURE SURFACE MOUNTED					
Service	Ckt. No.	Conn. Load	Brkr.	Wire Size	Phase AØ BØ	Wire Size	Brkr.	Conn. Load	Ckt. No.	Service	
SB FIXTURES	1	600	20/2	12		12	20/2	400	2	SA FIXTURES	
	3	600		12		12		400	4	SA FIXTURES	
TIC LIGHTING	5	174	20/1	12		12	20/1		6	SPARE	
SPARE	7		20/1	12		12	20/1		8	SPARE	
SPARE	9		20/1	12		12	20/1		10	SPARE	
SPARE	11		20/1	12		12	20/1		12	SPARE	
		AØ	Totals				BØ				
		1 374	VA	2 174				0 800			
		11.5	AMPS	9.06				6.7			

ISSUED FOR CONSTRUCTION
Description
Symbol
Date
10/11/15
JRR
Appr

Job Number
060451
Submitted by
John P. F. SE
Director, Field Services
Per Date
9/29/15
Per Scale
1:1
Drawn by
H. HOOVER
Checked by
S. FEEZOR
File Name
ARHSR E-604.DWG

ARKANSAS HIGHWAY AND TRANSPORTATION DEPARTMENT
ARKANSAS TOURIST INFORMATION CENTER
(WHITE RIVER) (S)
JOB 061451
SCHEDULES II

Sheet Reference Number:
E-604
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